datestamp

P

South Line of the SW 1/4 of Sec. 21 N 88'59'20" E

SIGNED DEPT.

BASIS OF BEARINGS

SOUTHWEST CORNER FOUND CDOT ALUM CAP IN RANGE BOX, PLS 8142

monumented as shown.

All bearings are based on the southerly line of the Southwest Quarter of Section 21,
Township 8 North, Range 62 West assumed to bear N 88'59'20" E a distance of 2648.00 feet,

SOUTH 1/4 CORNER FOUND CDOT ALUM CAP IN RANGE BOX, PLS 8142

Ŷ

7

Electric Lines

Dec. Trons. Tower
Buried Tel. Cable T. Edd. T. Culverts & Draine Section Corner 12 7 Road Approaches — Voven Wire — Combination Fence — Proposed Edisting (To be dashed) RO.W. No Hope O Deciduous Siphon Exieting (To be doeshed) Center of Seciton * * Coniferous 16' 1 . . End Sections to be Removed

To be Removed

To be Removed

How

STATE OF COLORADO DEPARTMENT OF TRANSPORTATION REVISES: JULY 1996 COLORADO DEPARTMENT OF TRANSPORTATION mm/yy Sheet Revisions ğ

C D O T Region 4
1420 2nd Street
Greeley, CO 80631
Greeley, CO 80631
FAX: (970) 350-2178

RIGHT OF WAY PLANS UNIT: JRJ

CONVENTIONAL SIGNS

DEPARTMENT


STATE 0F COLORADO TRANSPORTATION

1/18 Section Line

RIGHT OF WAY PLAN OF PROPOSED

PROJECT NO. C 0142-040 STATE HIGHWAY NO. RIGHT OF WAY WELD COUNTY

SCALES OF ORIGINAL DRAWINGS 1" = 100' R.O.W. LENGTH OF PROJECT 0.026 miles

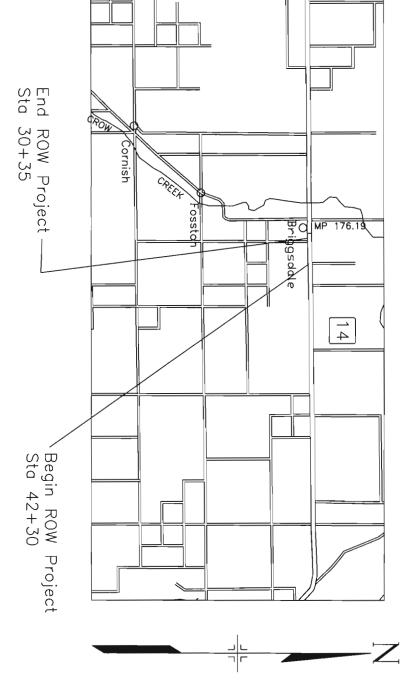

	ROJECT CODE:	HS			
Ž	CODE:	14			
INDEX OF SHEETS	14313	Briggsdal	C 014	TITLE	RIGHT
<u>FETS</u>	SHEET NUMBER:	SH 14 Briggsdale Safety Project	C 0142-040	TITLE SHEET	RIGHT OF WAY

- U 4 U V -1 1 3C
- 5A Title Sheet
 Tabulation of Properties
 Control Diagram
 Monumentation Sheets
 ROW Plan/Ownership Sheets

SIGNED DEPT. datestamp TE-2 TE-2A PARCEL NO. TE-4TE-3TE-1TE-4ATE-2B R.O.W. TABULATION OF PROPERTIES Same Same Agland Lueking, Lueking, James Same ጵ Gilliland, Wayne Joyce $\mathbf{a}\mathbf{s}$ as above Inc. <u>C</u> above James OWNER H. Same Same Eaton, CO P.0. Oxford, Briggsdale, 38535 Hwy 10081 10081 US Hwy 6 Same 0xford, Box 338 N as as $\mathbf{a}\mathbf{s}$ SDADDRESS NE 68967 ZE above above WELD above Hwy 6 14 68967 CO 80615 80611 COUNTY WELD COUNTY $\mathbf{3E}$ ${\bf 3S}$ ΖE ${\bf 3S}$ WN \mathbf{SE} \mathbf{SE} 1/4,1/4,1/4,1/4,1/4,1/4,1/4, Sec 28 LOCATION R62W Sec Sec Sec Sec Sec 21 21 21 21 21 28 1000 1000 1000 605 600 600 1337 AREA OF PARCEL \mathbf{sf} \mathbf{sf} \mathbf{sf} \mathbf{sf} \mathbf{sf} \mathbf{sf} gf EXISTING RO₩ \mathbf{S} Η. NET AREA TEFT REMAINDER REC. For Grading and Construction For Grading For Grading and Construction and Construction Previous editions are obsolete and may not be used CDOH Form 136 Rev. 05-91 REMARKS

7

COLORADO DEPARTMENT OF TRANSPORTATION

DOT Region 4
1420 2nd Street
Greeley, CO 80631
Phone: (970) 350-2157 FAX: (970) 350-2178

RIGHT OF WAY PLANS UNIT: JRJ

Sheet Revisions

NO.

SH 14 Briggsdale Safety Project TABULATION OF PROPERTIES RIGHT OF WAY C 0142-040

PROJECT CODE: 14313 SHEET NUMBER:

Survey Unit:

1420 2nd Street Greeley, CO 80631 Phone: (970) 350-2173 Mark D. Guerrero

(970) 350-2223 mm/dd/yy Sheet Revisions

SH 14 176.19 RP to 176.29 RP Weld County, Colorado Section 21 & 28, T8N, R62W, 6th P.M.

Project Control Diagram Title Sheet

Project Number: C0142-040

Project Location: SH 14 - 1 MILE EAST OF
Project Location: IN WELD COUNTY
Project Code: Last Nod. Date | Subset Sheets | Sheet No. |
14313 | 02/24/2003 | 1 of 4 | 3 | 윴

392

U ROJE \bigcirc COORDINATES SUMMARY TABLE (FEET

DOME NIVE	PROJECT C	PROJECT COORDINATES	ELEV	DESCRIPTION
LOTAL INVICE	NORTHING	EASTING	(NAVD 88)	DESCRIF LION
CP 7605 (MP 176.05)	166055.070	371360.468	4827.36	CDOT Type II Control Monument
CP 7620 (MP 176.20)	166129.500	372134.595	4851.88	CDOT Type II Control Monument
CP 7635 (MP 176.35)	166088.486	372933.387	4863.57	CDOT Type II Control Monument
CP 7650 (MP 176.50)	166104.516	373690.208	4873.41	CDOT Type II Control Monument
CP 7664 (MP 176.64)	166020.993	374429.231	4886.73	CDOT Type II Control Monument
CP 7673 (MP 176.73)	166123.189	374899.722	4887.57	CDOT Type II Control Monument

GPS COORDINATE SUMMARY TABLE (METRIC) (ADJUSTED FIELD DATA)

	GEODETIC COORDINAT	GEODETIC COORDINATES NAD-83(92) (CHARN) ELLIPSOID	ELLIPSOID	MAPPING	20 7 4	NAD 83(92) ZONE	ONE 0501
FOHNT NAIVE	LATITUDE(N)	LONGITUDE(W) (NAVD 88)	(NAVD 88)	ANGLE	SCALE	NORTHING(m) EASTING(m)	EASTING(m)
CP 7605 (MP 176.05)	40° 38' 22.92371"	104° 20' 06.67358"	1453.082	0° 45' 09.44850"	0.999979847	450497.866	1012930.478
CP 7620 (MP 176.20)	40° 38′ 23.55836″	104° 19′ 56.62252″	1460.551	0° 45′ 15.94282"	0.999979867		1013166.372
CP 7635 (MP 176.35)	40° 38' 23.04919"	104° 19′ 46.27133″	1464.110	0° 45′ 22.63107″	0.999979851	450508.049	1013409.782
CP 7650 (MP 176.50)	40° 38' 23.10874"	104° 19′ 36.45464″	1467.102	0° 45' 28.97396"	0.999979853	450512.934	1013640.402
CP 7664 (MP 176.64)	40° 38' 22.18700"	104° 19' 26.88587"	1471.156	0° 45' 35.15667"	0.999979822	450487.482	1013865.599
CP 7673 (MP 176.73)	40° 38′ 23.13482″	104° 19′ 20.76729″ ·	1471.405	0° 45′ 39.11009″	0.999979853	450518.624	1014008.968
BRIGGS (HARN Pt.)	40° 38' 22.79276"	104° 23′ 05.23387″	1491.580	0° 43' 14.07473"	0.999979842	450439.889	1008735.207
PARACHINI (Densification Pt.) 40° 28' 52.44714"		104° 05' 23.51288"	1415.738	0° 54' 40.08817"	0.999964917	433204.982	1033959.911

BASIS OF BEARINGS: Bearings used in the calculation of coordinates are based on a grid bearing of S 55°39'25" E from HARN Point "BRIGGS" (NGS horizontal control disk set in top of a round concrete post stamped BRIGGS 1960) Section 24, Township 8 North, Range 63 West, Sixth P.M. and the Densification Point "PARACHINI" (NGS horizontal control disk set in top of a round concrete post stamped PARACHINI 1997) Section 16, Township 6 North, Range 60 West, Sixth P.M. as obtained from a Global Positioning System (GPS) survey based on the Colorado High Accuracy Reference Network (CHARN).

BASIS OF ELEVATIONS: Project is based on a NAVD 88 elevation of 1509.728m on HARN Point "BRIGGS" (NGS horizontal control disk set in top of a round concrete post stamped BRIGGS 1960). All other Control Point elevations were GPS derived.


NOTE: No guarantee as to the accuracy of the information contained on the attached drawing is either stated or implied unless this copy bears an original signature of the professional land

surveyor hereon named.

of the statement shown.

NOTE: According to Colorado law you must commence any legal action based upon any defect in this survey within three years after you first discover such defect. In no event may any action based upon any defect in this survey be commenced more than ten years from the date

COORDINATE DATUM: Project Coordinates are modified Colorado State Plane North Zone NAD 83(92) coordinates. State Plane Coordinates were modified to mean project elevation of 1509.728m. The combined elevation/scale factor used to modify the coordinates was 0.9997429715. Project Coordinates are truncated by 400,000 in the Northing and 900,000 in the Easting. The CHARN is based on NAD 83(92) datum.

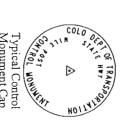



Typical Control Monument Cap Not to Scale


SURVEYORS STATEMENT: I, Lee K. Groves, a Professional Land Surveyor in the State of Colorado, hereby state that this Control Survey Diagram was prepared under my direct supervision this day of supervision and checking for and on behalf of the Department of Transportation, State of Colorado, and is not a Land Survey Plat or Right-of-Way Survey Plat and to the best of my knowledge and belief this control survey, as shown, meets the minimum horizontal control tolerances of a CDOT Type B Survey and this topographic survey, as shown, meets the minimum horizontal control tolerances of a CDOT Type D Survey as listed in the Colorado Department of Transportation Survey Manual Chapter Three (Revised 4/29/92). Lee \nearrow L.S. 34169

CP - Control Point Monuments set by CDOT. They are CDOT Type 2 monuments a 3-1/4" dia. aluminum control monument cap (as shown) on a 3' X 3/4" dia. finned aluminum security rod on a 3' X 3/4" dia. smooth aluminum rod.

Groves

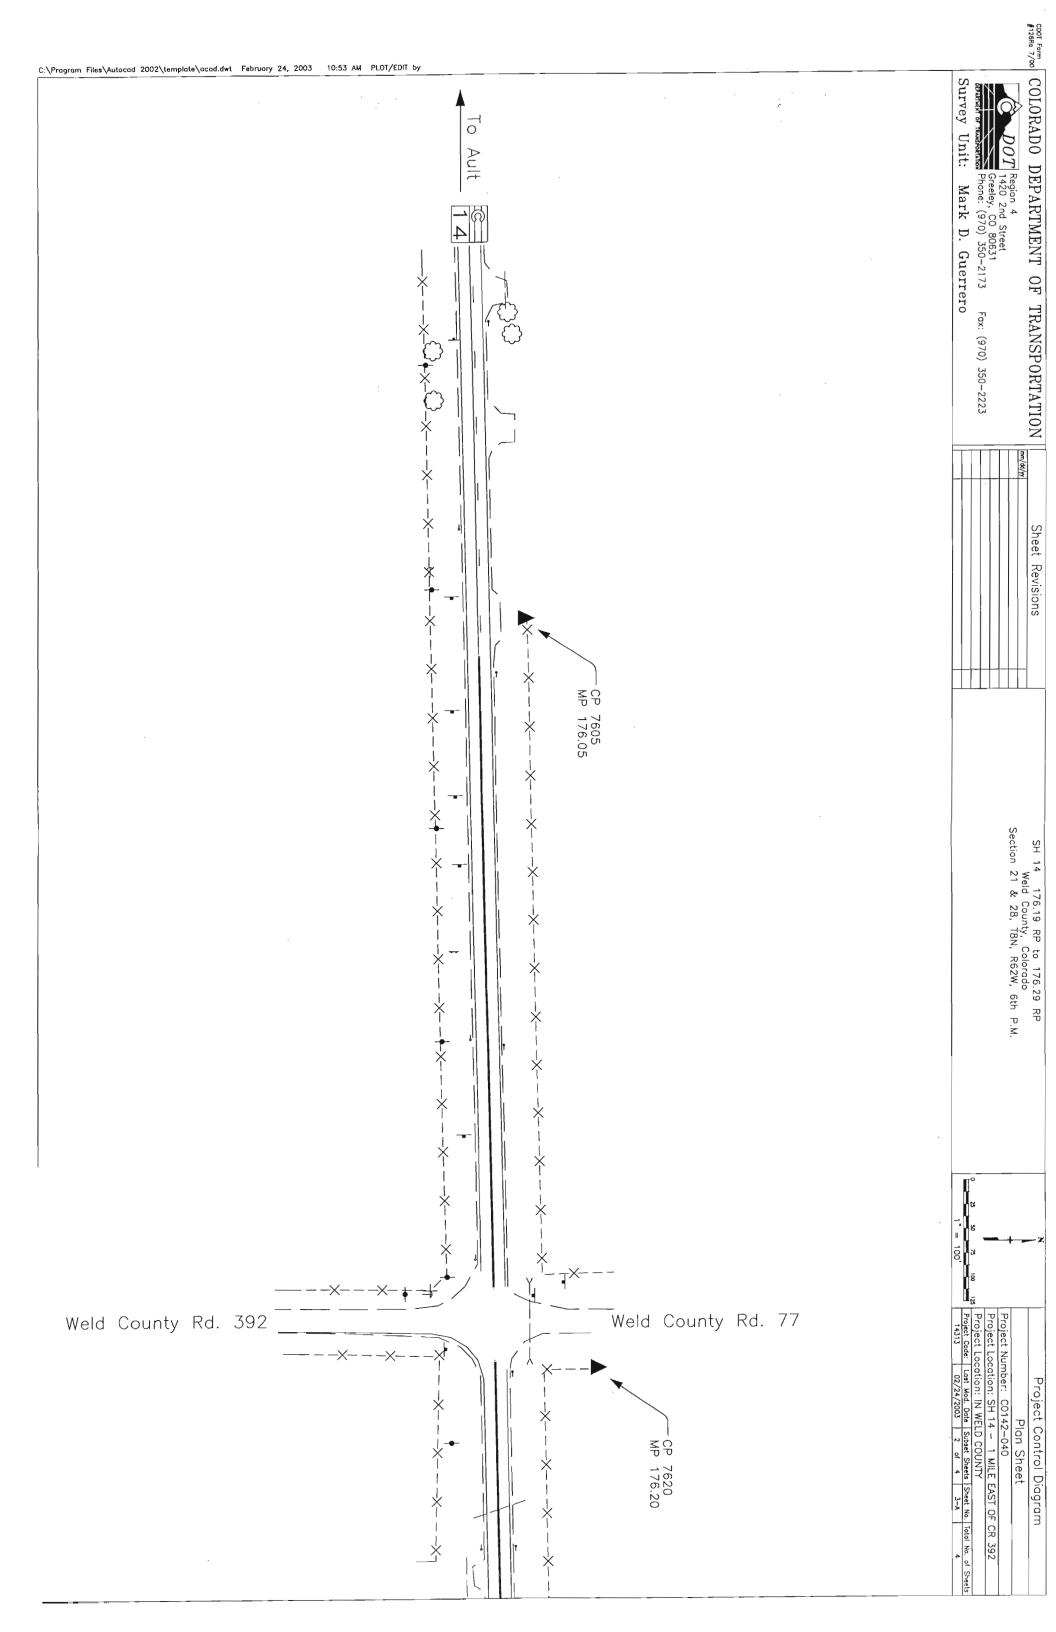

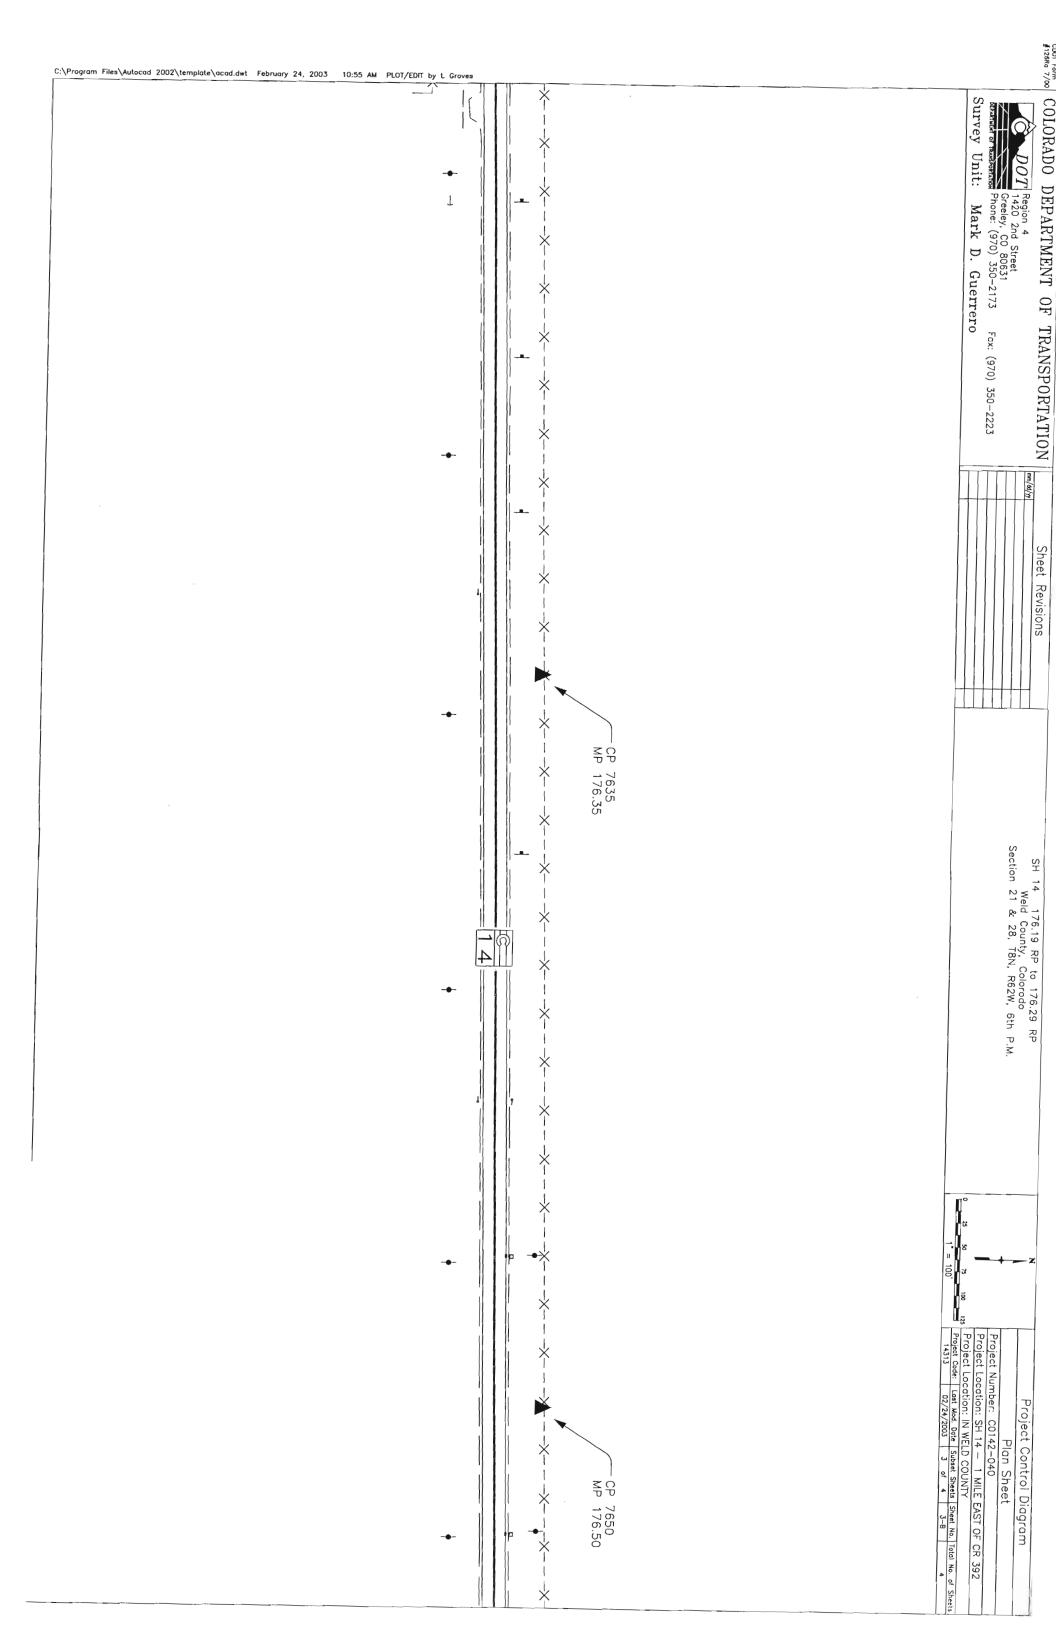

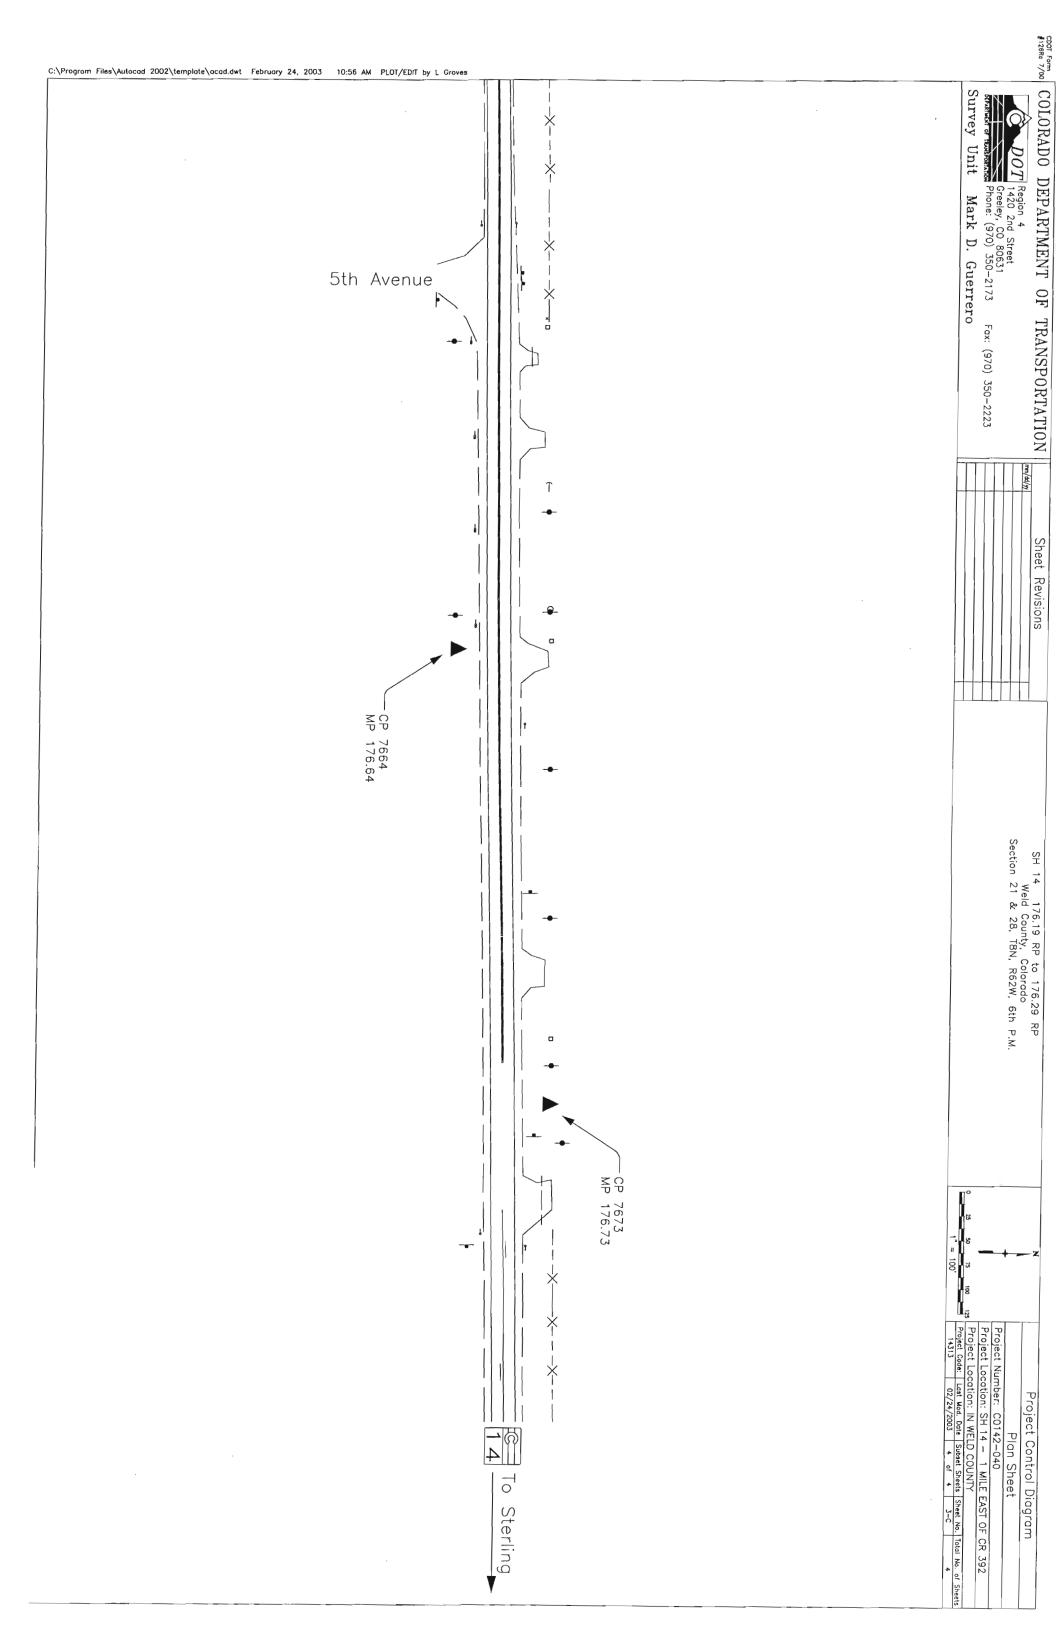

FIZESS 7/00 COLORADO DEPARTMENT OF TRANSPORTATION

mm/dd/yy

DOT Region 4 Right-of-Way 1420 2nd Street Greeley, CO 80631 Phone: (303) 350-2153

Right of Way Plans Unit Jerry R. Johnson, PLS Fax: (303) 350-2178

> Sheet Revisions ğ Sheet Revisions ğ mm/dd/yy Sheet Revisions

TABULATION OF TEMPORARY EASEMENT POINTS TO BE STAKED

TABULATION OF ALIQUOT CORNERS
TO BE RESET

POINT NO. 5000

166053.872 NORTHING

																											374030.075	EASTING
634	633	632	631	630	629	628	627	626	625	624	623	622	621	620	619	618	617	616	615	614	613	612	611	610	609	608	607	POINT NO.
166134.513	166154.509	166153.445	166133.449	166129.673	166149.669	166148.605	166128.610	166122.743	166142.747	166141.683	166121.678	166117.696	166137.701	166137.062	166117.058	166115.927	166135.932	166135.293	166115.289	165984.501	166014.926	166014.255	165996.491	165982.643	166012.825	166001.561	166009.033	NORTHING
375017.976	375017.551	374967.562	374967.987	374790.539	374790.114	374740.125	374740.550	374464.853	374464.853	374414.853	374414.853	374227.721	374227.721	374197.721	374197.721	374144.599	374144.599	374114.599	374114.599	374060.626	374099.185	374060.056	373988.533	374000.782	374000.073	373965.539	373821.881	EASTING

GENERAL NOTES

 Project Location: Briggsdale, CO

 Project Code: Last Mod. Date Subset Sheets Sheet No. Total No. of Sheets 14313

 03/06/2003
 1 of 1
 4
 9

Project Location: SH 14 Briggsdale Safety Project

Project Number: C 0142-040

Monumentation Sheet RIGHT OF WAY PIATIS

- This Right of Way plan is not a complete boundary survey of all adjoining owners and is prepared for Transportation Department purposes Only.
- Survey Control Points set with a higher degree of accuracy than ROW Markers.

?

- NOTICE: According to Colorado law you must commence any legal action based upon any defect in this survey within three years after you first discover such defect. In no event, may any action based upon any defect in this survey be commenced more than ten years from the date of the certification shown hereon.
- 4. All R.O.W. Markers set from survey control points.
- All centerline and offset stationing is theoretical only and may not represent the centerline as constructed in the field. All stationing is approximate.
- 6. All coordinates listed are project coordinates only.
- Field survey control precision computed to exceed 1/20,000.
- 8.No Commitments for title insurance were supplied for this project. Easements are located from available records.

QUANTITY OF MONUMENTS TO BE SET

CAP			NO.	MONUMENT TYPE	NTT	YPE		
TYPE	1	1A	2	2A	3	<i>3A</i>	4	5
REFERENCE								
RIGHT OF WAY								
CONTROL								
ALIGHOT CORNER						1		
טרושטטי טטווייריי								

SURVEYOR CERTIFICATE (FIELD)

Control Survey and Monumentation was done under my supervision and checking.

BOW Blanc and Local Depositions were proper	SURVEYOR	
local Deposintions	CERTIFICATE	
	(OFFICE	

DATE

NAME

P.L.S. NO.

Unknown.dwg March 06, 2003 01:37 PM PLOT/EDIT by DGM

R.O.W. Plans and Legal Descriptions were prepared

	NAME	under
		my
		under my supervision and checking.
		and
	P.L.S. NO.	checking.
	NO.	
	1	

Right of Way Plans Unit: Jerry R. Johnson, PLS

mm/dd/yy Sheet Revisions ğ Sheet Revisions XX/pp/mm/xxx Sheet Revisions

Project Number: C 0142-040

Project Location: SH 14 Briggsdale Safety Project

Project Location: Briggsdale, CO

Project Code: Last Mod. Date Subset Sheets Sheet No. Total No. of Sheets 14313

03-04-03

3 of 3 5

9

Plan and Ownership Sheet

Right of Way Plans

 ∞ ; Z R. 62 W., 6th Principal Meridian

SW 1/4 SEC. 21

Gilliland, Wayne H. & Joyce C. 38535 HWY 14 Briggsdalle, CO 80611

23 FR R. C.

ANGENI CINEDA

PAR DON'T CHALL

N.S

Lucking, James 10081 US HWY 6 Oxford, NE 68967-2005

ROW 30+35, Begin Project

ΓE

607

143.85 178.23

30.19

23.55

18.49 610 611

NW 1/4 SEC. 28

DateStamp