Colorado Department of Transportation



18500 East Colfax Avenue Aurora, CO 80011 Phone: 303-757-9648 FAX: 303-757-9746

David A. Stewart Region 1

	Sheet Revisions			Sheet Revisions	
ote	Description	Initials	Date	Description	Initials
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4755 FORGE ROAD, SUITE 150 COLORADO SPRINGS, COLORADO 80907 (719) 590-9194 / (917) 590-9111 Fax

Final Land	Survey	Control Diagram
	Title	Sheet
Project Number: FE	R 0362-032	2
Project Location: 5	SH 36 @ Co	manche Creek
1	lear Strasbu	rg, CO

INDEX OF SHEETS

(2) Monument Coordinate Tables

(1) Title Sheet

(2) Plan Sheet

(5) Total Sheets

DEPARTMENT OF TRANSPORTATION STATE OF COLORADO

FINAL LAND SURVEY CONTROL DIAGRAM AND RIGHT OF WAY PLAN


State Highway 36 MP 95.2 to 95.6 Sections 33 & 34, Township 3 South & Sections 3 & 4, Township 4 South, Range 62 West of the 6th Principal Meridian Counties of Arapahoe & Adams

1 1 QUARTER, SIXTEENTH, SECTION CORNER (1) 1 RIGHT OF WAY SET EASMENT TEMPORARY QUARTER, SIXTEENTH, NOAA MARKER BLM MARKER PROPERTY PIN AND SECTION CORNERS WC. WITNESS CORNER BENCH MARK USGS MARKER FEDERAL MONUMENT 100 LOCAL OR PLSS SECONDARY CONTROL RIGHT OF WAY MONUMENT MONUMENT MARKER N 9.88 E 3.81 EL 0.00 N 10.13 E 3.81 EL 0.00 E 3.81 EL 0.00 PROJECT CONTROL DENSIFICATION HIGH ACCURACY REFERENCE


Note: For a complete listing of symbololyy used within this set of plans, please refer to the M-100-1 Standard Symbols of the Colorado Department of Transportation M&S Standards Publication dated July 2006. Existing features are shown as screened weight (gray scale). Proposed or new features are shown as full weight without screening.

General Notes:

- 1. This Preliminary Land Survey Control Diagram is an interim document for informational purposes only. This document will be superseded by the Land Survey Control Diagram included with the deposited right of way plans.
- 2. Title policy, title commitment, and title research are not part of this survey. therefore easements, rights, and restrictions of record were not researched and are not shown on this diagram. The verification of the physical evidence with relation to easements, rights of ways, property boundaries, and restrictions, as described in the instruments of record, were not included in this preliminary land survey control diagram.
- 3. This plan set is subject to change and may not be the most current set. It is the user's responsibility to verify with CDOT that this set is the most current. The information contained on the attached drawing is not valid unless this copy bears and original signature of the Professional Land Surveyor hereon named.
- 4. Refer to the M-629-1 Survey Monuments of the Standard Plans dated July, 2006 found in The Colorado Department of Transportation, M & S Standards for typical survey monument descriptions.

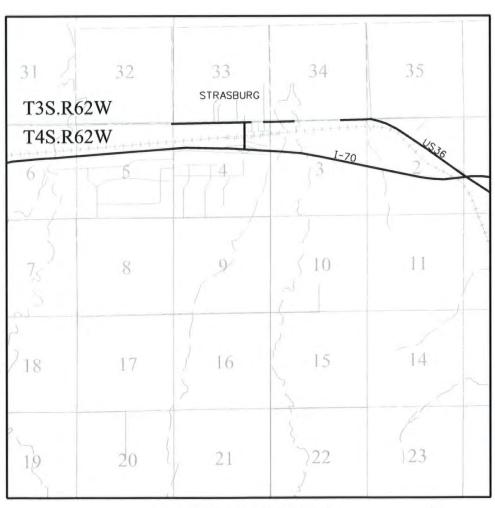

PROJECT LOCATION MAP

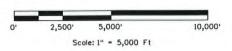

Basis of Bearings: Bearings used in the calculations of coordinates are based on a grid bearing of N88° 36'28"W from CM-MP 95.30 to CM-MP 95.57. Both monuments are CDOT Type II, marked appropriately for their milepost location and control position. The survey data was obtained from a Global Positioning System (GPS) survey base on the Colorado High Accuracy Reference Network (CHARN).

SHEET NO.

4.01

4.02-4.03

4.04-4.05

Basis of Elevations: Project elevations are based on Bench Mark A259 1938, PID: KK0023, a standard bench mark disk set on top of a concrete monument. with a NAVD 88 elevation of 5395.29ft. A259 is a First order benchmark.

COORDINATE DATUM: Project coordinates are modified Colorado State Plane Central Zone NAD '83/(92) coordinates. The combined elevation/scale factor used to modify the coordinates from state plane to project coordinates is 1.00030129. The resulting project coordinates are truncated by 1,000,000ft in the Northing and 3,000,000ft in the Easting after converting from state plane coordinates to project coordinates. The CHARN is based on the NAD '83(92)

Project Coordinates Northing US Survey Feet = (State Plane Coordinate Northing * (3937/1200) * 1.00030129 - 1,000,000).


Project Coordinates Easting US Survey Feet = (State Plane Coordinate Easting * (3937/1200) * 1.00030129 - 3,000,000).

NOTICE: According to Colorado law you must commence any legal action based upon any defect in this survey within three years after you first discover such defect. In no event may any action based upon any defect in this survey be commenced more than ten years from the date of the certification shown hereon.

SURVEYOR STATEMENT (LAND SURVEY CONTROL DIAGRAM)

I, <u>Terry R Maw</u>, a professional land surveyor licensed in the State of Colorado, do hereby state to the Colorado Department of Transportation this Land Survey Control Diagram was prepared and the field survey it represents was performed under my responsible charge and, based upon my knowledge, information and belief is in accordance with applicable standards of practice defined by Colorado Department of Transportation publications. This statement is not a guaranty or warranty, either expressed or implied.

PLS No. 31161

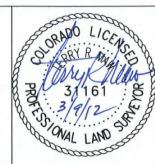

Colorado Department of Transportation



Region 1

18500 East Colfax Avenue Aurora, CD 80011 Phone: 303-757-9648 FAX: 303-757-9746 David A. Stewart

Sheet Revisions				Sheet Revisions	
Date	Description	Initials	Date	Description	Initials



4755 FORGE ROAD, SUITE 150 COLORADO SPRINGS, COLORADO 80907 (719) 590-9194 / (917) 590-9111 Fax www.f-w.com

Final L	and Surve	y Contro	ol Diagram
М	onument Co	oordinate	e Tables
Project Num	ber: FBR 0362-0	132	
Project Loca	otion: SH 36 @ (Comanche Cr	eek
	Near Stras	burg, CD	
Project Code:	Lost Mod Date	Subset	Sheet No.





Point No.	Geodetic Coordinates NAD-83(92) (CHARN)		Elip Height	Ortho Height (m)	NAD 83(92)	Zone 0502	Be a selection
POINT NO.	Latitude(N)	Longitude(W)	(NAVD88)(m)	Ortho Height (m)	SP Northing(m)	SP Easting(m)	Description
A259	39°44'13.82865"	104°17'54.40095"	1626.099	1644.488	516829.13	1017396.30	3.25" BRASS CAP IN CONC US COAST & GEODETIC
ASAY	39°46'55.04134"	104°19"13.97812"	1595.072	1613.52	521775.951	1015437.087	3.25" BRASS CAP IN CONC ADAMS COUNTY
-				-			





Point No.	Geodetic Coordinates	NAD-83(92) (CHARN)	Elip Height	Ortho Height	NAD 83(92)	Zone 0502	Decembration
FOITE NO.	Latitude(N)	Long1 tude (W)	(NAVD88) (m)	(m)	SP Northing (m)	SP Easting(m)	Description
9530	39°44'18.43159"N	104°19'17.80838"W	1619.579	1637.926	516945.063	1015408.607	Set CDOT Type II for MP 95.30
9536	39°44'17.98221"N	104°19'13.60892"W	1619.297	1637.646	516932.502	1015508.770	Set CDOT Type II for MP 95.36
9547	39°44'18.06994"N	104°19'06.14279"W	1618.977	1637.330	516937.518	1015686.494	Set CDOT Type II for MP 95.47
9557	39°44'18.59429"N	104°18'59.16242"W	1618.879	1637.236	516955.852	1015852.477	Set CDOT Type II for MP 95.57
					-		





Northing(ft) Easting(ft) (NAVD88) 59 696141.10 338913.37 5395.290 3.25" Brass Cap in Conc - US Coast & Geode -54 696549.01 333919.77 5372.630 3.25" Alum Cap - Arapahoe County 1 696554.32 332966.63 5364.043 #5 Rebar w/RPC "Farns worth Control" 30 696521.56 332390.09 5373.762 Set CDOT Type II for MP 95.30	Northing(ft) Easting(ft) (NAVD88) A259 696141.10 338913.37 5395.290 3.25" Brass Cap in Conc - U P4-54 696549.01 333919.77 5372.630 3.25" Alum Cap - Arapahoe 0 11 696554.32 332966.63 5364.043 #5 Rebar w/RPC "Farms wort 9530 696521.56 332390.09 5373.762 Set CDOT Type II for MP 95.3	
-54 696549.01 333919.77 5372.630 3.25" Alum Cap - Arapahoe County 1 696554.32 332966.63 5364.043 #5 Rebar w/RPC "Farns worth Control" 30 696521.56 332390.09 5373.762 Set CDOT Type II for MP 95.30	P4-54 696549.01 333919.77 5372.630 3.25" Alum Cap - Arapahoe 0 11 696554.32 332966.63 5364.043 #5 Rebar w/RPC "Farms wort 9530 696521.56 332390.09 5373.762 Set CDOT Type II for MP 95.3	or special
1 696554.32 332966.63 5364.043 #5 Rebar w/RPC "Farns worth Control" 30 696521.56 332390.09 5373.762 Set CDOT Type II for MP 95.30	11 696554.32 332966.63 5364.043 #5 Rebar w/RPC "Farms wort 9530 696521.56 332390.09 5373.762 Set CDOT Type II for MP 95.3	S Coast & Geodetic
30 696521.56 332390.09 5373.762 Set CDOT Type II for MP 95.30	9530 696521.56 332390.09 5373.762 Set CDOT Type II for MP 95.3	County
Street International Control of the	State of the state	th Control"
36 696480.34 332718.81 5372.843 Set CDOT Type II for MP 95.36	0000	30
	9536 696480.34 332718.81 5372.843 Set CDOT Type II for MP 95.3	36
47 696496.80 333302.07 5371.806 Set CDOT Type II for MP 95.47	9547 696496.80 333302.07 5371.806 Set CDOT Type II for MP 95.4	47
57 696556.96 333846.80 5371.497 Set CDOT Type II for MP 95.57	9557 696556.96 333846.80 5371.497 Set CDOT Type II for MP 95.5	57



Colorado Department of Transportation

Region 1

18500 East Colfax Avenue Aurora, CD 80011 Phone: 303-757-9648 FAX: 303-757-9746

David	A.	Stewart
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Sheet Revisions				Sheet Revisions	
ate	Description	Initials	Date	Description	Initials
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4755 FORGE ROAD, SUITE 150 COLORADO SPRINGS, COLORADO 80907 (719) 590-9194 / (917) 590-9111 Fax www.f-w.com

Finall	and Surv	ey Contro	l Diagram
М	onument (Coordinate	Tables
Project Num	ber: FBR 0362	-032	
Project Loc	otion: SH 36 @	Comanche Cree	ek
	Near Stro	sburg, CO	
Project Code:	Last Mod. Date	Subset	Sheet No.
18276	08-31-11	4.03 of 4.05	4.03

 \Diamond

FOUND ALIQUOT MONUMENT COORDINATE TABLE					
Northing(ft)	Easting(ft)	Description			
696516.35	332451.45	3.25" ALUM. CAP IN RANGE BOX - ILLEGIBLE			
696578.35	335095.62	3.25" ALUM. CAP - ILLEGIBLE			
696636.17	337736.46	SET 3.25" ALUM. CAP ON REBAR IN RANGE BOX			
	Northing(ft) 696516.35 696578.35	Northing(ft) Easting(ft) 696516.35 332451.45 696578.35 335095.62			

PP


	FOUND BOUNDARY MONUMENT COORDINATE TABLE						
Point No.	Northing(ft)	Easting(ft)	Description				
1000	696564.88	333242.90	YPC - LS 13487 FUTURA ENG.				
1001	696571.64	333523.77	YPC - LS 13487 FUTURA ENG.				
1002	696578.78	333836.82	YPC - LS 13487 FUTURA ENG.				
1003	696592.78	334425.83	#3 REBAR - NO CAP				
1004	696585.61	334126.30	RPC ON BENT #4 REBAR - LS 12330				
1005	696582.94	334025.53	YPC - 23041				
1006	696579.96	334026.22	1-1/2" ALUM. CAP - LS 28277 BSF				
1007	696461.08	333071.32	YPC - 2438				
1008	696231.40	333195.95	YPC - LS 18475 M. SCHEAR				
1009	696717.99	332292.15	YPC - LS 28258 BASELINE ENG.				
1010	696542.86	332295.39	YPC - LS 28258 BASELINE ENG.				
1011	696554.00	332781.06	YPC - LS 13487 FUTURAENG.				
1013	696080.72	333244.61	1-1/2" ALUM. CAP - 24662				
2000	696720.75	332418.13	#5 REBAR W/ YPC - PLS 28258 BASELINE				
2001	696067.58	333245.91	#4 REBAR W/ YPC - LS 18475 M. SCHEAR				

FOUND R.O.W. MONUMENT COORDINATE TABLE ROW Point No. Northing(ft) Easting(ft) Description 20082 696545.45 332420.97 FOUND 4"x4" CONC. POST STAMPED ST. HWY ROW


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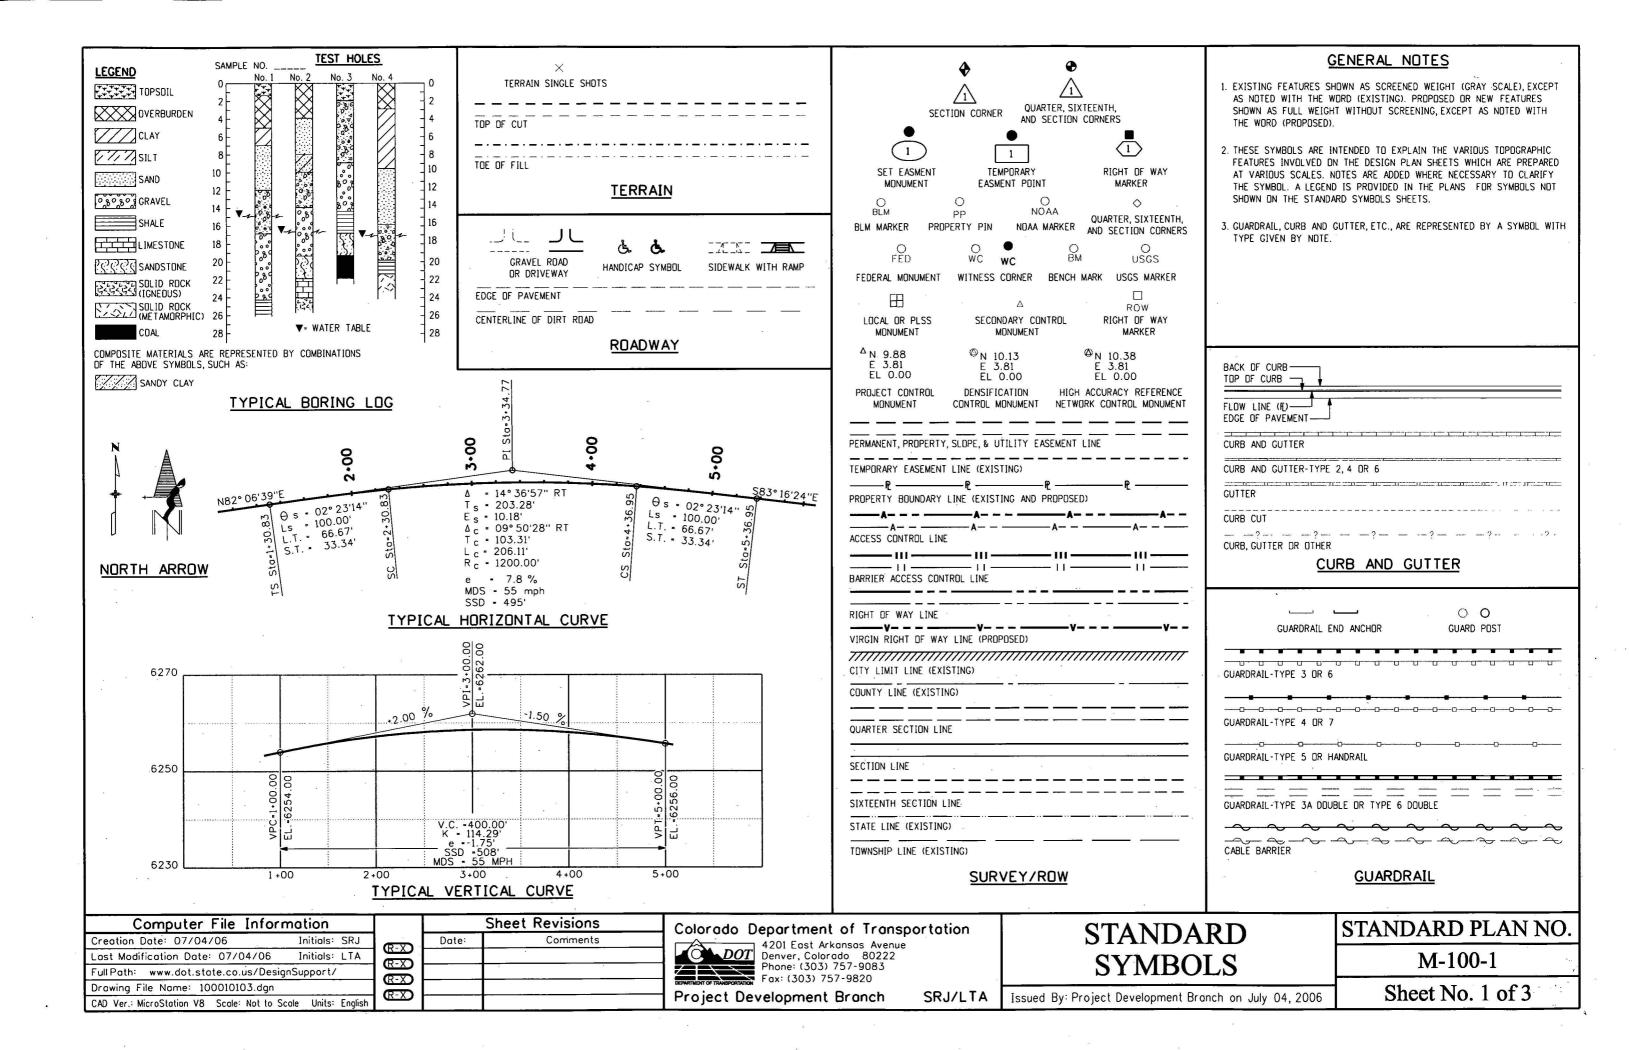
	FOUND EASE	MENT MONUMENT CO	ORDINATE TABLE
Point No.	Northing(ft)	Easting(ft)	Description




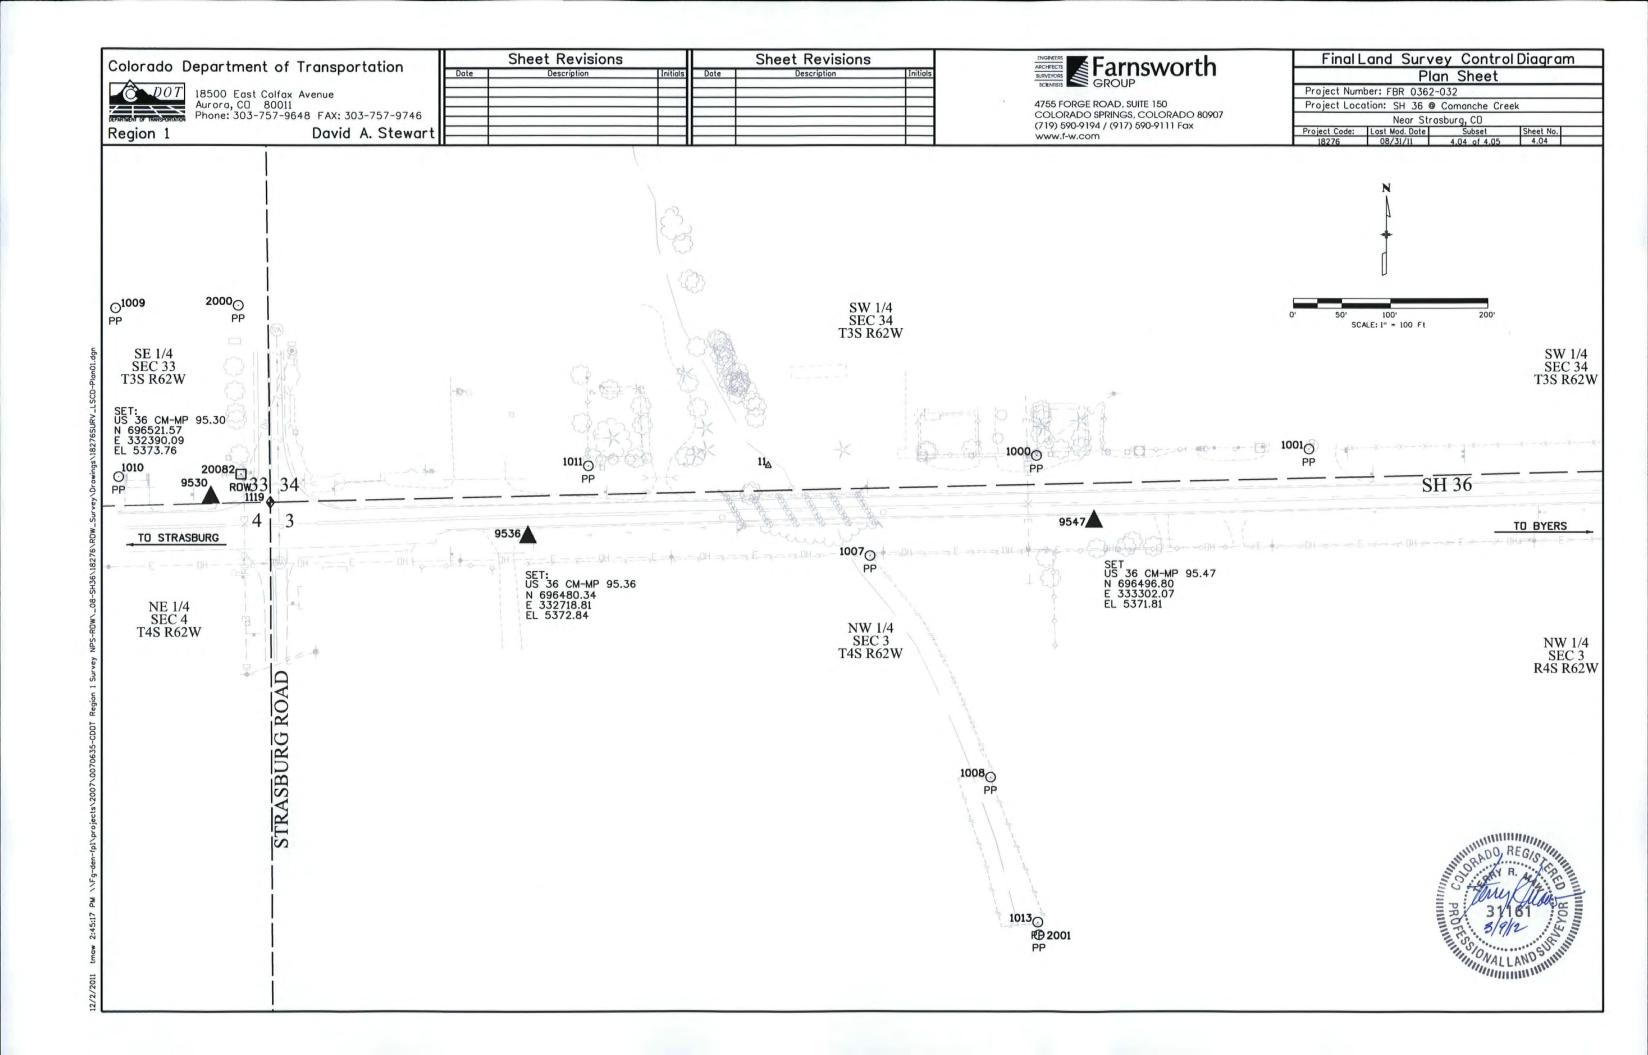



Colorado Department of Transportation	Sheet Revisions Date Description Initials Date	Sheet Revisions Description Initials	ENGINERS ARCHITICALS SCIENTISS SCIENTISS GROUP	Final Land Survey Control Diagram Plan Sheet		
18500 East Colfax Avenue Aurora, CO 80011 Phone: 303-757-9648 FAX: 303-757-9746 Region 1 David A. Stewart			4755 FORGE ROAD, SUITE 150 COLORADO SPRINGS, COLORADO 80907 (719) 590-9194 / (917) 590-9111 Fox	Project Number: FBR 0362-032 Project Location: SH 36 © Comanche Creek Near Strasburg, CD		
Region 1 David A. Stewart			www.f-w.com	Project Code: Lost Mod. Date Subset Sheet No. 18276 08-31-11 4.05 of 4.05 4.05		
			N 			
SW 1/4 SEC 34 T3S R62W			0' 50' 100' SCALE: 1" - 100 Ft	SE 1/4 SEC 34 T3S R62W		
SET: US 36 CM-MP 95.57 N 696556.97 E 333846.80 EL 5371.50 1002 / 1005 PP 1006 PP	1003 _O					
PP 19557 500 PP TO BYERS						
				N.		
NW 1/4 SEC 3 T4S R62W				NE 1/4 SEC 3 T4S R62W		
				DESCRIPTION ALLAND STRING		




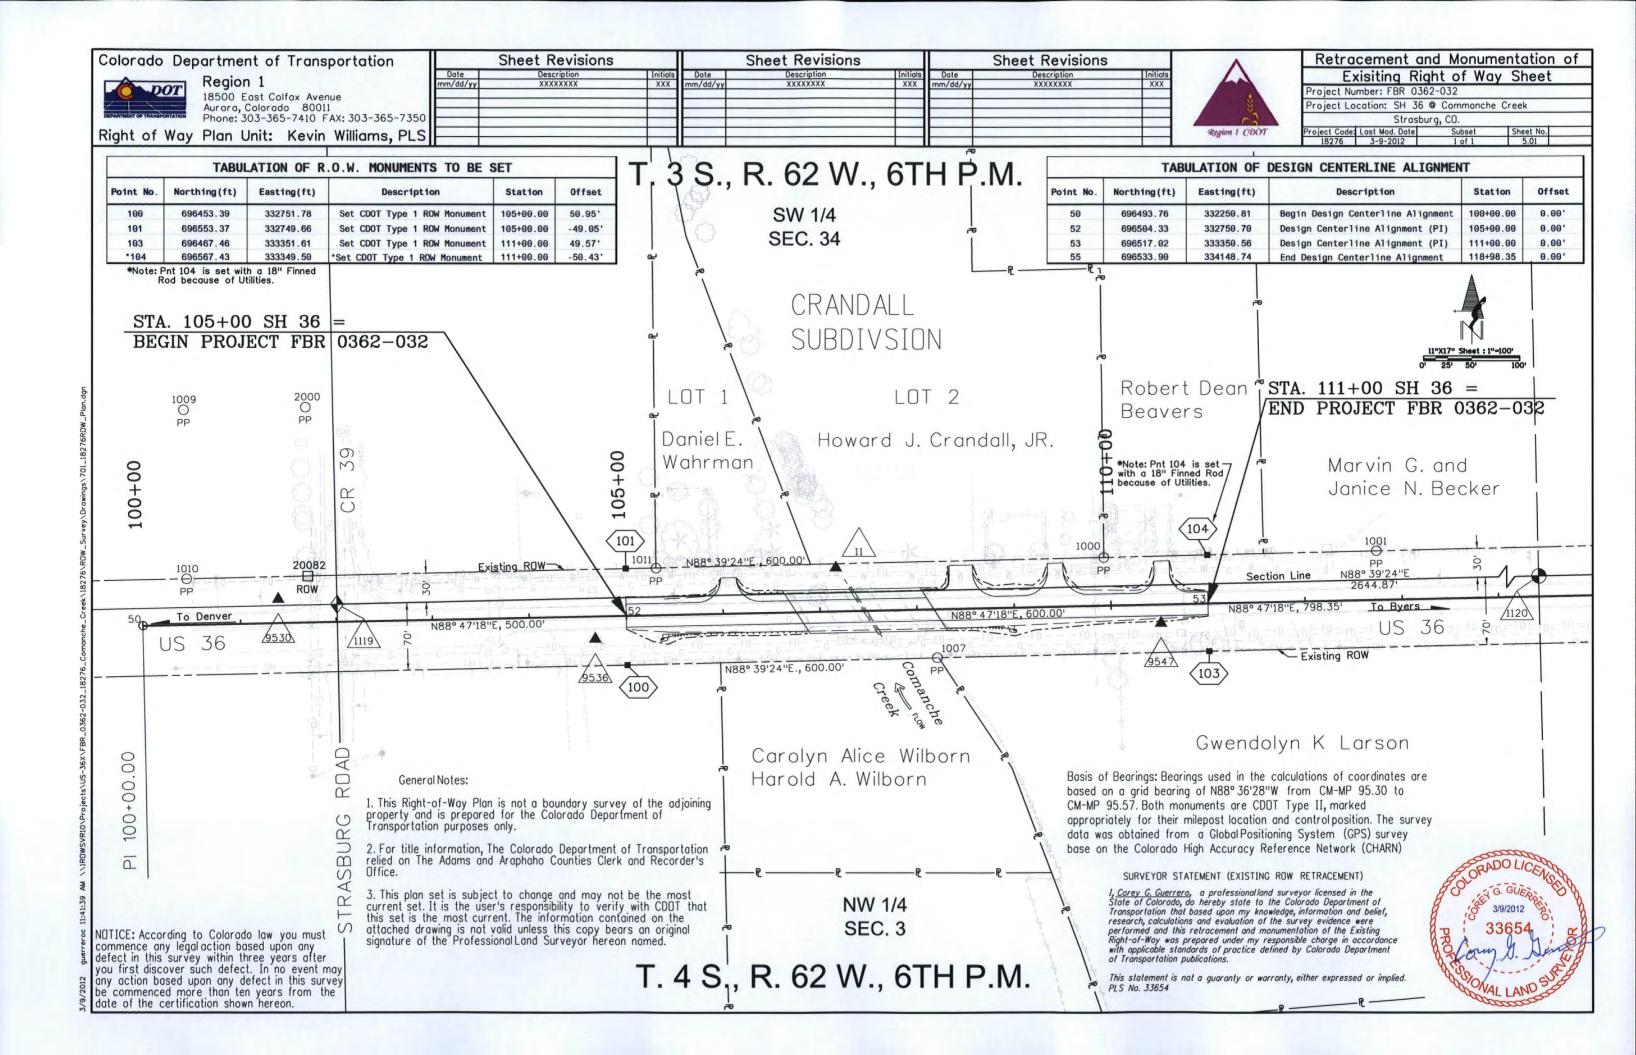

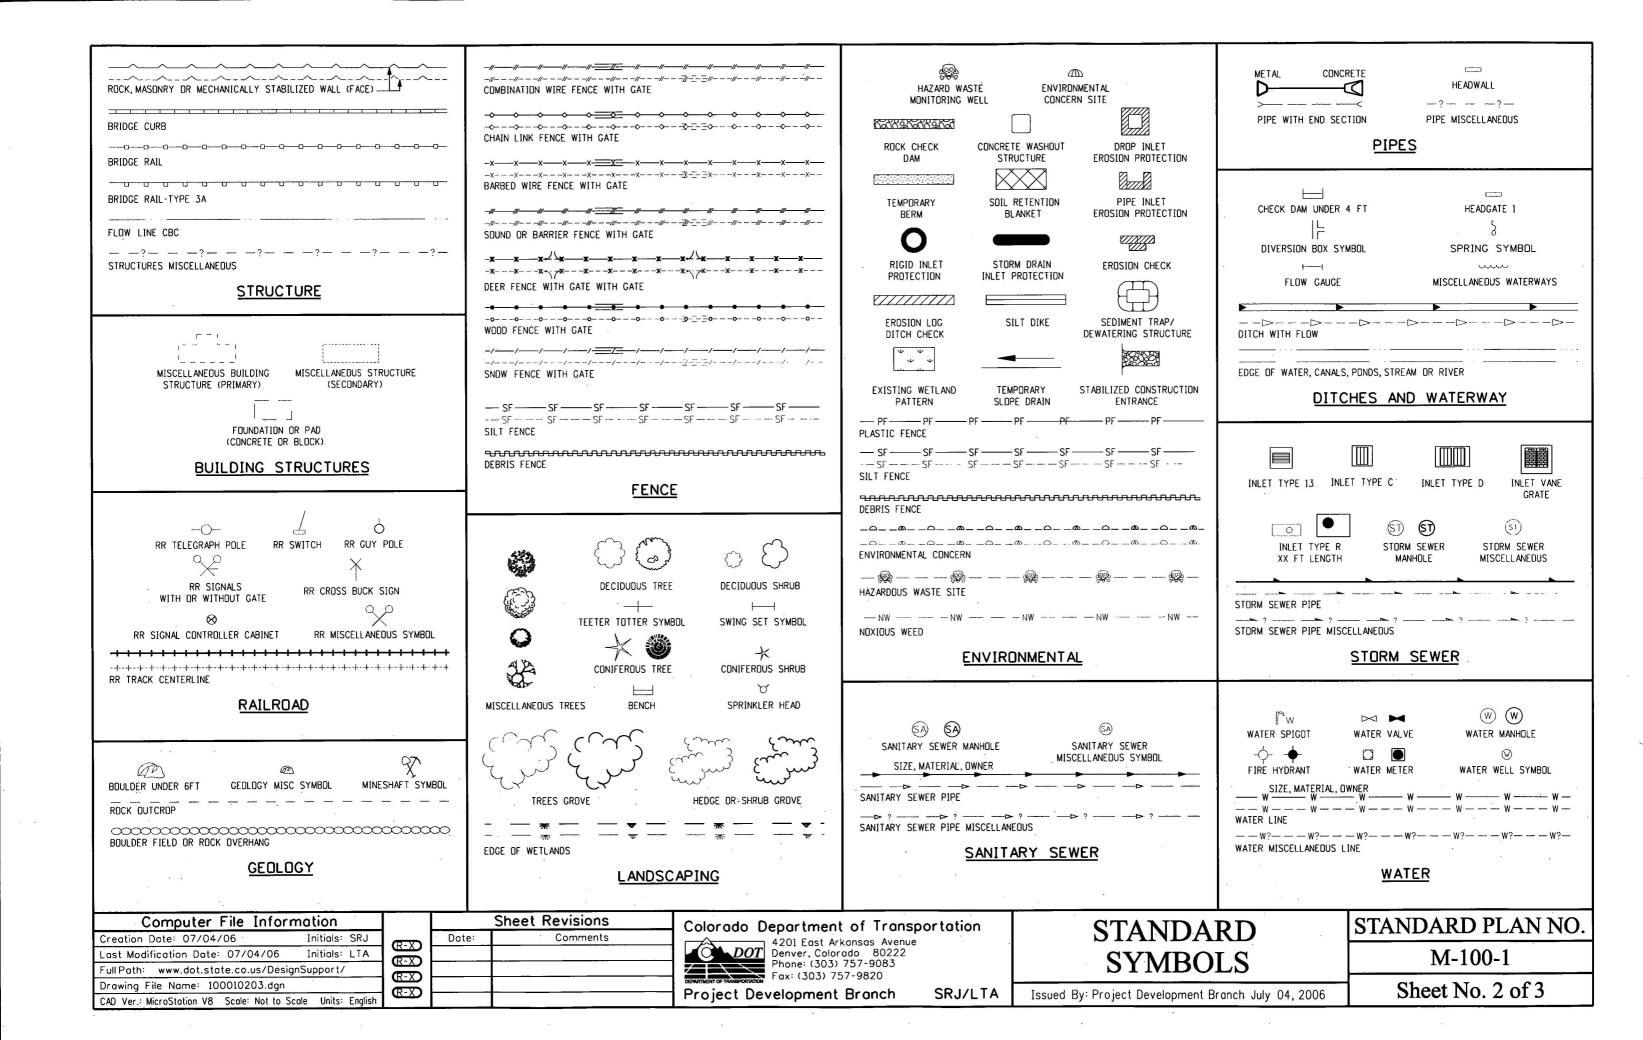


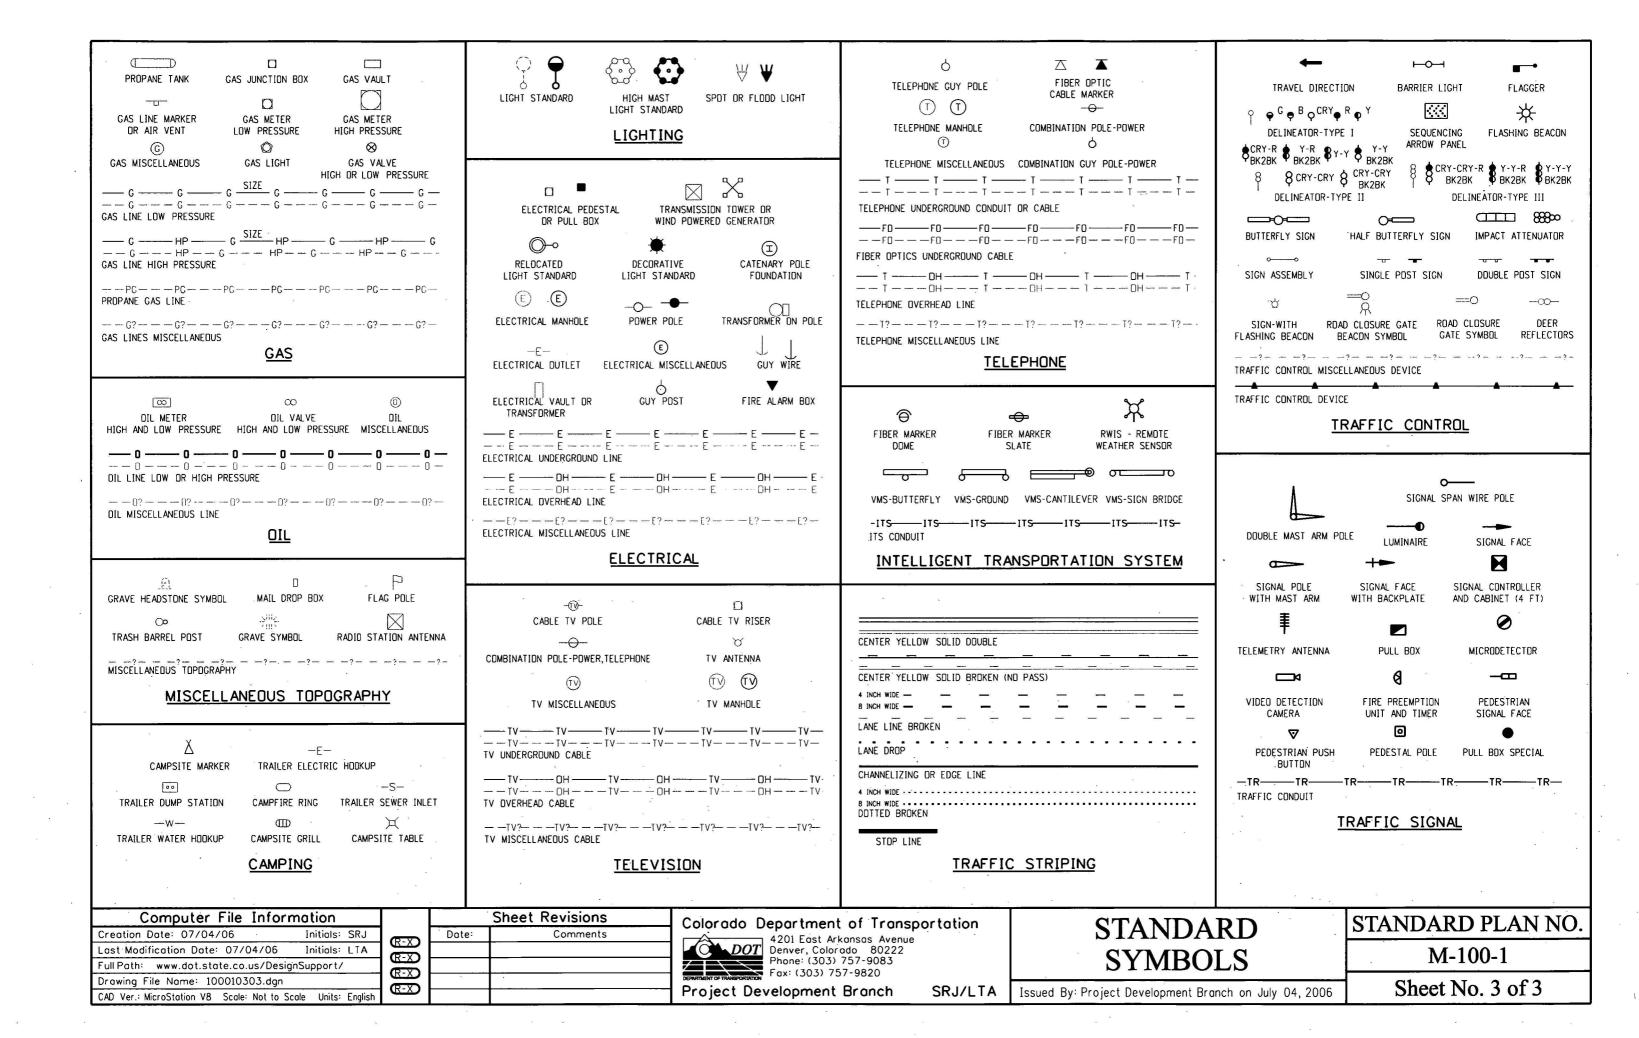


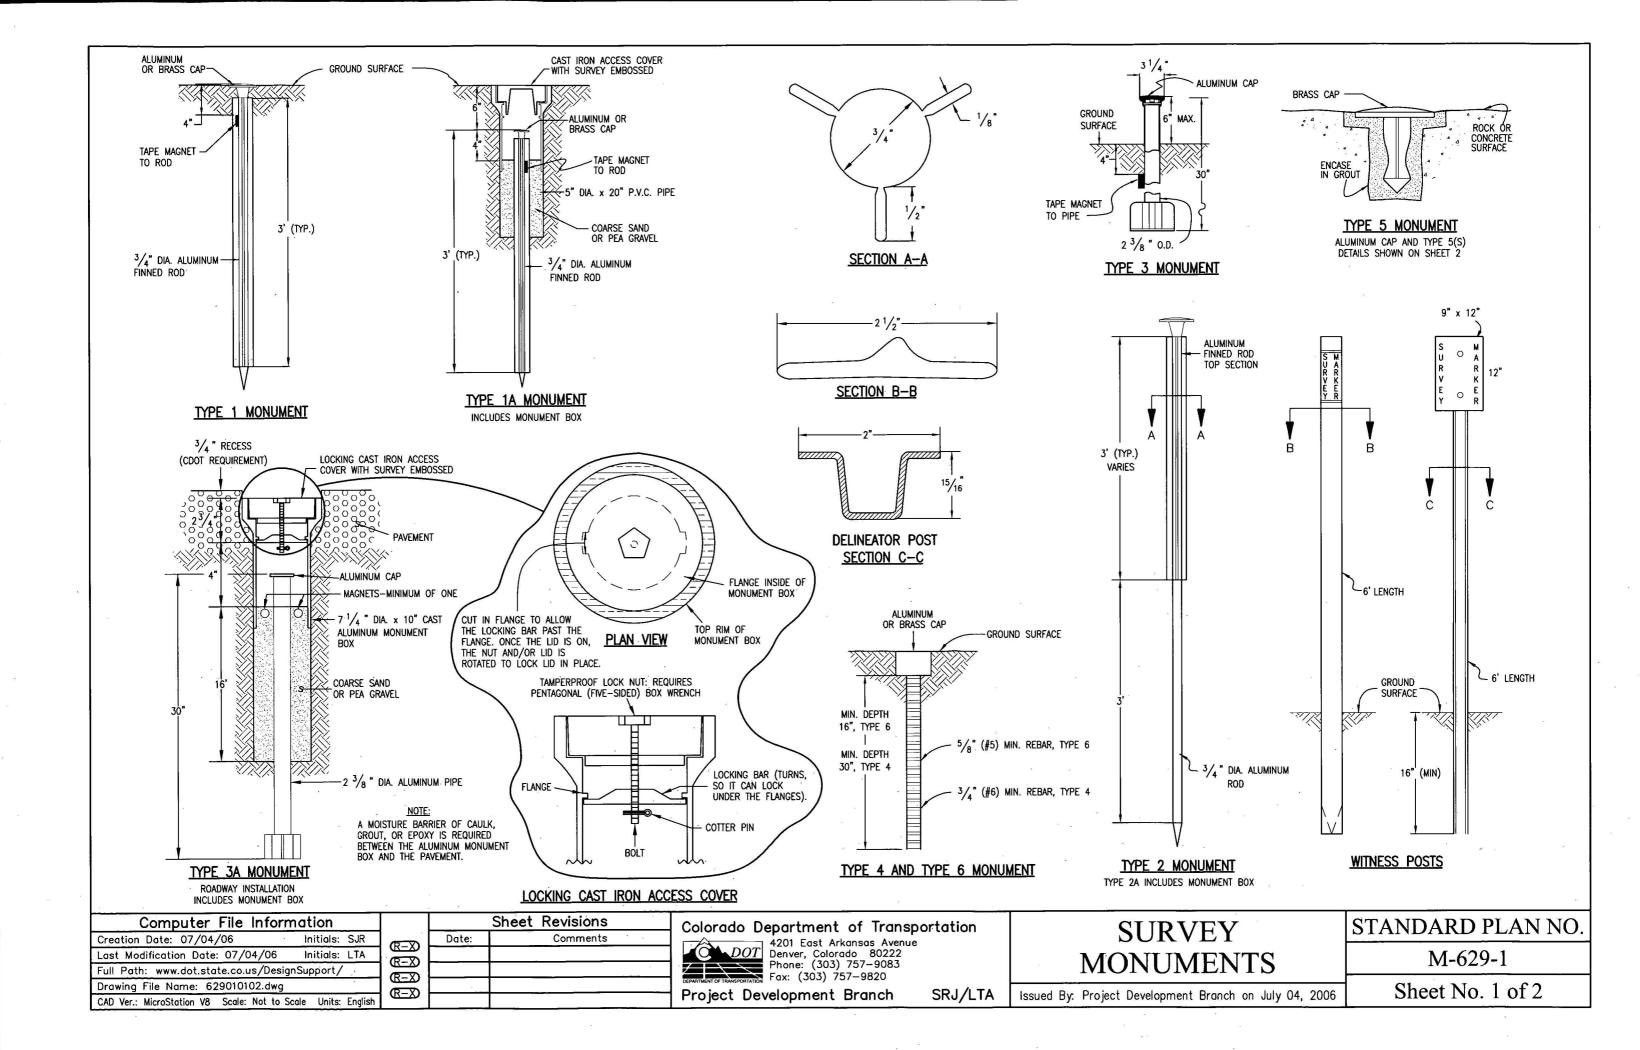

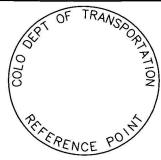



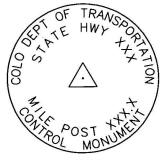

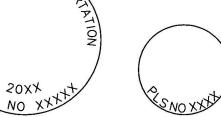

REFERENCE MONUMENT CAP


ROW MONUMENT CAP

CONTROL MONUMENT CAP

ALIQUOT CORNER MONUMENT CAP


ALUMINUM CAP


NOTE: A BLANK CAP MAY BE SUBSTITUTED IF THE APPROPRIATE CAP SHOWN ABOVE IS NOT AVAILABLE. IF A BLANK CAP IS USED, ALL INFORMATION NORMALLY INCLUDED ON THE APPROPRIATE STANDARD CAP, SHALL BE STAMPED ON THE BLANK CAP ALONG WITH SPECIFIC PROJECT INFORMATION SUCH AS PROJECT NO., DATE, POINT NO., ETC ..

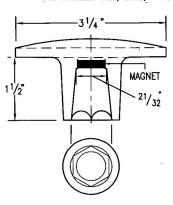


ALUMINUM CAP

USED WITH ALUMINUM ROD

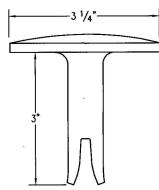

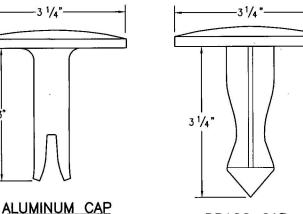

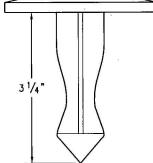



BRASS CAP TYPE 5 FOR PLACING IN EXISTING CONCRETE OR ROCK

TYPE 5 FOR PLACING IN EXISTING CONCRETE OR ROCK

	MONUMENT TYPE									
CAP TYPE	1	1A	2	2A	3	3A	. 4	5	5(S)	6
REFERENCE	х	Х						х	Х	Χ
ROW	Х	Х						Х	X	
CONTROL			Х	Х				Х	Х	
ALIQUOT CORNER	х	Х	-		Х	Х	Х	Х		
PERMANENT EASEMENT								Х	X	X
PROJECT POINTS			100					Х	X	X
		a								
WITNESS POST * (REQUIRED)	х		х	х	х			X		

MONUMENT APPLICATION

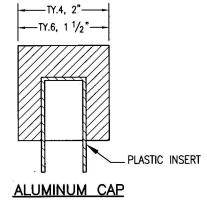

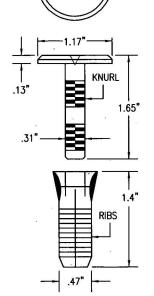

COPPER ALLOY CAP TYPE 5(S)

FOR PLACING IN EXISTING SIDEWALK, CURB, OR GUTTER

ALL MONUMENTATION MATERIALS WILL BE FURNISHED BY CDOT

THE MONUMENT TYPE SHALL MEET THE MINIMUM STANDARDS AS DETERMINED BY THE COLORADO STATE BOARD OF REGISTRATION FOR PROFESSIONAL LAND SURVEYORS RULES (STATE BOARD RULES).

THE CDOT SURVEY COORDINATOR SHALL APPROVE ALL EXCEPTIONS FOR STAMPING MONUMENTS DIFFERING FROM THE STANDARDS.

TYPE 1 AND TYPE 1A ALUMINUM FINNED ROD MONUMENTS

THIS MONUMENT SHALL BE USED FOR ROW OR REFERENCE MONUMENTS OR MAY BE USED FOR AN ALIQUOT CORNER MONUMENT. WHEN USED AS AN ALIQUOT CORNER MONUMENT, INSTALLATION AND RECORD FILING REQUIREMENTS SHALL BE AS STATED FOR TYPE 3 AND TYPE 3A MONUMENTS.

MONUMENTS SHALL BE INSTALLED BY ATTACHING THE PROPER SIZE TIP TO ONE END OF A SECTION OF FINNED ROD, AND A 3 IN. LONG X 3/4 IN. DIA. STAINLESS STEEL ADAPTER TO THE OTHER END. THE DRIVER IS THEN PLACED OVER THE STAINLESS STEEL ADAPTER FOR THE HAMMER TO CONTACT. TYPE 1 MONUMENTS SHALL USE A MINIMUM 3 FT. SECTION OF FINNED ROD. WHEN SUBSURFACE ROCK OR CONCRETE IS ENCOUNTERED LESS THAN 3 FT. BELOW THE GROUND SURFACE, THE ROD SHALL BE EMBEDDED IN THE ROCK OR IN CONCRETE AT LEAST 6 IN. AND GROUTED IN PLACE. THE ROD MAY BE SHORTENED

WHEN UNSTABLE SOIL CONDITIONS ARE ENCOUNTERED, ADDITIONAL SECTIONS OF ROD SHALL BE ADDED TO ACHIEVE STABILITY. HORIZONTAL AND VERTICAL STABILITY ARE REQUIRED.

TYPE 1A MONUMENT INCLUDES MONUMENT BOX. A LOCKING CAST IRON ACCESS COVER SHALL BE INSTALLED WHEN THE MONUMENT IS LOCATED IN THE ROADWAY PAVEMENT.

TYPE 2 AND TYPE 2A ALUMINUM FINNED ROD MONUMENTS

THIS MONUMENT SHALL BE USED FOR HORIZONTAL AND VERTICAL CONTROL MONUMENTS. WHEN UNSTABLE SOIL CONDITIONS ARE ENCOUNTERED, ADDITIONAL SECTIONS OF ROD SHALL BE ADDED TO ACHIEVE STABILITY, HORIZONTAL AND VERTICAL STABILITY ARE REQUIRED. IN MOST SOIL CONDITIONS THE TYPE 2 MONUMENT IS EMBEDDED 6 FT. INTO THE GROUND.

THE MONUMENT SHALL BE INSTALLED BY FIRST ATTACHING THE PROPER SIZE TIP TO A 3 FT. LONG X 3/4 IN. DIA. ROD, THEN DRIVING THE ROD AT LEAST 30 IN. INTO THE GROUND. ADDITIONAL 3 FT. LONG X 3/4 IN. FINNED ROD SECTIONS SHALL BE ADDED AND DRIVEN FLUSH WITH THE GROUND UNTIL THE MONUMENT IS IN A STABLE POSITION. THE FINS ARE BENT OVER USING PLIERS TO ACCOMMODATE INSTALLING THE CAP. THE CAP IS FIRMLY SEATED ONTO THE LAST FINNED SECTION OF ROD USING A DEAD BLOW SLEDGE HAMMER.

TYPE 2A MONUMENT INCLUDES MONUMENT BOX. A LOCKING CAST IRON ACCESS COVER SHALL BE INSTALLED WHEN THE MONUMENT IS LOCATED IN THE ROADWAY PAVEMENT.

TYPE 3 AND TYPE 3A ALUMINUM PIPE MONUMENTS

THIS MONUMENT SHALL BE USED FOR AN ALIQUOT CORNER MONUMENT. THE INSTALLATION OF THIS MONUMENT AND RECORD FILING SHALL BE DONE IN ACCORDANCE WITH THE STATE BOARD RULES. ALSO REFER TO THE CDOT SURVEY MANUAL AND THE BUREAU OF LAND MANAGEMENT REQUIREMENTS FOR MONUMENT INSTALLATION. THE LAND SURVEYOR'S LICENSE NUMBER AND THE YEAR SHALL BE STAMPED ON THE CAP.

TYPE 3A MONUMENT INCLUDES MONUMENT BOX. A LOCKING CAST IRON ACCESS COVER SHALL BE INSTALLED WHEN THE MONUMENT IS LOCATED IN THE ROADWAY PAVMENT.

TYPE 4 ALUMINUM MONUMENT

THIS MONUMENT MAY BE INSTALLED IN LIEU OF REPLACING THE ENTIRE MONUMENT WHEN REBAR IS IN PLACE AT AN ALIQUOT CORNER LOCATION. REFER TO THE STATE BOARD RULES. A MINIMUM 2 IN. DIA. CAP SHALL BE USED ON 3/4 IN. (#6) REBAR.

TYPE 5 BRASS/ALUMINUM CAP MONUMENT.

THIS MONUMENT MAY BE INSTALLED IN LIEU OF ALL OTHER CDOT MONUMENTS, WHEN THE POSITION IS LOCATED IN CONCRETE OR STABLE ROCK FORMATION.

TYPE 5(S) COPPER ALLOY CAP MONUMENT - SMALL

THIS MONUMENT MAY BE INSTALLED IN LIEU OF A TYPE 5 MONUMENT, WHEN THE POSITION IS LOCATED IN A CONCRETE SIDEWALK, CURB OR GUTTER, OR WHEN SETTING A TYPE 5 WOULD COMPROMISE THE INTEGRITY OF THE RECEIVING STRUCTURE.

STAMPING REQUIREMENTS:

- "RP", WHEN THE APPLICATION IS A REFERENCE POINT.
- "ROW", POINT NUMBER, "LS", AND REGISTRATION NUMBER WHEN THE APPLICATION IS A ROW POINT.
- "CP" AND A UNIQUE IDENTIFIER PROVIDED BY THE REGION SURVEY COORDINATOR, WHEN THE APPLICATION IS A CONTROL POINT.
- "PE", POINT NUMBER, "LS", AND REGISTRATION NUMBER, WHEN THE APPLICATION IS A PERMANENT EASEMENT POINT.
- "PP" AND POINT NUMBER, WHEN THE APPLICATION IS A PROJECT POINT.

TYPE 6 ALUMINUM MONUMENT

THIS MONUMENT SHALL BE USED FOR PERMANENT EASEMENTS, PROJECT BENCH MARKS, PROJECT POINTS, AND REFERENCES. AN ALUMINUM CAP WITH A MINIMUM DIAMETER OF $1\frac{1}{2}$ In., SHALL BE USED ON $\frac{5}{8}$ In. (#5) MINIMUM REBAR.

* WITNESS POSTS

THE WITNESS POST WILL BE SUPPLIED BY CDOT AND INSTALLATION SHALL BE INCLUDED IN THE WORK. IT SHALL BE DRIVEN WITHIN 1 FT. OF THE MONUMENT WHEN POSSIBLE. A DELINEATOR POST WITH A 9 IN. X 12 IN.METAL SIGN PANEL MAY BE USED IN LIEU OF THE PLASTIC POST. THIS POST SHALL CONFORM TO STANDARD PLAN S-612-1. A REQUIRED WITNESS POST MAY BE OMITTED WITH THE APPROVAL OF THE ENGINEER IF THE WITNESS POST LOCATION IS WITHIN A TRAVELED WAY, DRIVEWAY, OR ACCESS OPENING.

Computer File Information Creation Date: 07/04/06 Initials: SJR Last Modification Date: 07/04/06 Initials: LTA Full Path: www.dot.state.co.us/DesignSupport/ Drawing File Name: 629010202.dwg CAD Ver.: MicroStation V8 Scale: Not to Scale Units: English

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Colorado Department of Transportation



4201 East Arkansas Avenue DOT Denver, Colorado 80222 Phone: (303) 757-9083 Fax: (303) 757-9820

Project Development Branch

SRJ/LTA

SURVEY
MONUMENTS

STANDARD PLAN NO.

M-629-1

Issued By: Project Development Branch on July 04, 2006

Sheet No. 2 of 2