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FILING CERTIFICATION:
DEPOSITED THIS ____
IN BOOK ______ C
SURVEYS AT PAGE ____

Colorado	Department	of	Transportation

1420 2nd Street Greeley, CD 80631 Phone: 970-350-2161 FAX: 970-350-2178

 $\sqrt{1}$

SECTION CORNER

PROPERTY PIN

SET FASEMENT

MONUMEN1

FEDERAL MONUMENT

LOCAL OR PLSS MONUMENT

PROJECT CONTROL

ACCESS CONTROL LINE

BARRIER ACCESS CONTROL LINE

CITY LIMIT LINE (EXISTING)

COUNTY LINE (EXISTING)

QUARTER SECTION LINE

SIXTEENTH SECTION LINE

STATE LINE (EXISTING)

TOP OF CUT

TOE OF FILL

TOWNSHIP LINE (EXISTING)

VIRGIN RIGHT OF WAY LINE (PROPOSED)

—— III —

RIGHT OF WAY LINE

N 9.88 E 3.81 EL 0.00

BLM MARKER

1

TEMPORARY

EASEMENT POINT

WC

SECONDARY CONTROL

MONUMENT

SURVEY/ROW

TERRAIN

WITNESS CORNER

N 10.13 E 3.81 EL 0.00

DENSIFICATION

PERMANENT, PROPERTY, SLOPE, & UTILITY EASEMENT LINE

PROPERTY BOUNDARY LINE (EXISTING AND PROPOSED)

TEMPORARY EASEMENT LINE (EXISTING)

_____P ______P _____

NOAA MARKER

Region 4 Right of Way

QUARTER, SIXTEENTH,

AND SECTION CORNERS

1

RIGHT OF WAY

QUARTER, SIXTEENTH,

AND SECTION CORNERS

RIGHT OF WAY

MARKER

ROW Project

M.P.: 162.93

M.P.: 163.02 (First Section)

word (proposed).

plans, please refer to the M-100-1 Standard Symbols of the Colorado Department of Transportation M&S Standards Publication dated July

2012. Existing features are shown as screened weight (gray scale),

except as noted with the word (existing). Proposed or new features

are shown as full weight without screening, except as noted with the

BENCH MARK USGS MARKER

N 10.38 E 3.81 EL 0.00

HIGH ACCURACY REFERENCE

	Sheet Revisions			Sheet Revisions			Sheet Revisions	
Date	Description	Initials	Date	Description	Initials	Date	Description	Initials

Right	of Way Pla	ins								
Title Sheet										
Project Number: FSA 0	343-037									
Project Location: US 3	4 Signals in Fort	Morgan Phase 2								
Project Code: Last Mod. Date	Subset	Sheet No.								

SHEET NO.

2.01

3.01-3.04

4.01-4.03

5.01

6

7.01-7.04

8.01-8.03

DEPARTMENT OF TRANSPORTATION **STATE OF COLORADO**

RIGHT OF WAY PLANS OF PROPOSED PROJECT NO. FSA 0343-037 US HIGHWAY NO. 34 MORGAN COUNTY

Scales of Original 11x17 Drawings

Plan Sheets 1"=40"


Ownership Map 1"=100"

ROW Project FSA 0343-037

M.P.: 164.41

M.P.: 164.51 (Second Section)

R.D.W. Length of Project (Section 1) = 0.1 Miles Const. Length of Project (Section 1) = 0.1 Miles R.O.W. Length of Project (Section 2) = 0.1 Miles Const. Length of Project (Section 2) = 0.1 Miles

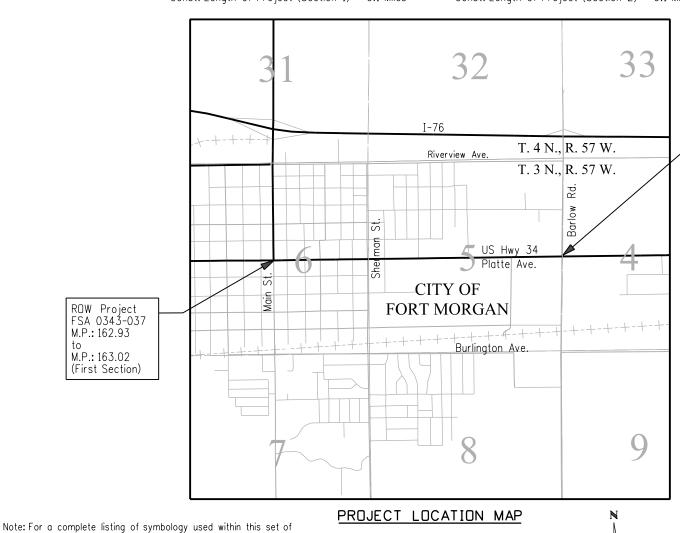

2640'

Lineal Units = U.S. Survey Feet

Basis of Bearings (Main St.): Bearings used in the calculations of coordinates are based on a grid bearing of N73° 29'58"E (284.52') from the ControlPoint "CM 6299" (CDDT Type 5 Monument, MP 162.99), Sec. 6, T3N, R57W, 6th P.M. and the ControlPoint "CM 6303" (CDDT Type 5 Monument, MP 163.03), Sec. 6, T3N, R57W, 6th P.M. as obtained from a Global Positioning System (GPS) survey based on the Colorado High Accuracy Reference Network (CHARN).

INDEX OF SHEETS Title Sheet

(4) Plan Sheets

(17) Total Sheets

(3) Ownership Map

Tabulation of Properties

Project Control Diagram

Monumentation Sheets

Land Survey Control Diagram

(NA) Tabulation of Road Approach Sheets

Basis of Bearings (Barlow Rd.): Bearings used in the calculations of coordinates are based on a grid bearing of N88° 47'10"E (968.30') from the Control Point "CM 6452" (CDDT Type 5 Monument, MP 164.52), Sec. 4, T3N, R57W, 6th P.M. and the Control Point "CM 6470" (CDDT Type 5 Monument, MP 164.70), Sec. 4, T3N, R57W, 6th P.M. as obtained from a Global Positioning System (CPS) survey based on the Colorado High Accuracy Reference Network (CHARN).

- 1. This Right-of-Way Plan is not a boundary survey of the adjoining property and is prepared for the Colorado Department of Transportation purposes only.
- 2. For title information, The Colorado Department of Transportation relied on title commitments prepared by Northern Colorado Title Services. (See Sheet 2.01 for title commitment numbers.)
- 3. This plan set is subject to change and may not be the most current set. It is the user's responsibility to verify with CDOT that this set is the most current. The information contained on the attached drawing is not valid unless this copy bears an original signature of the Professional Land Surveyor hereon named.

NOTICE: According to Colorado law you must commence any legal action based upon any defect in this survey within three years after you first discover such defect. In no event may any action based upon any defect in this survey be commenced more than ten years from the date of the certification shown hereon.



CDOT RIGHT OF WAY MANAGER

SURVEYOR STATEMENT (ROW PLAN)

I, I. Jeffrey Nading, a professional land surveyor licensed in the State of Colorado, do hereby state to the Colorado Department of Transportation that based upon my knowledge, information and belief, research, calculations and evaluation of the survey evidence were practice defined by Colorado Department of Transportation publications. This statement is not a guaranty or warranty, either expressed or implied.

PLS No. 37885

performed and this Right-of-Way Plan was prepared under my responsible charge in accordance with applicable standards of

D0T	1420 2nd Street	
	Greeley, CD 80631	
DEPARTMENT OF TRANSPORTATION	Phone: 970-350-2161	FAX: 970-350-217

	Sheet Revisions			Sheet Revisions			Sheet Revisions	
te	Description	Initials	Date	Description	Initials	Date	Description	Initials
			·					

Right of Way Plans Tabulation of Properties Project Number: FSA 0343-037
Project Location: US 34 Signals in Fort Morgan Phase 2

	Right of Way	TS									Project Code: Last Mod. Date Subset Sheet No. 18837 12-28-12 2.01 of 2.01 2.01
	R.O.W. TABULAT	TION OF PROPERTIE	ES IN MORGAN COUN	TY U.	S. HWY	NO. 3	4		Book and Page		
	Ownership Name and Mailing				Area In	Square Feet	(Acres)	1	No. And/Or	Title Commitment No.	Remarks
Parcel No.	Address	Site Address	Location	Area Of Parcel	Existing ROW	Net Area	Remainder Left	Remainder Right	Reception No.	Committalent No.	
			T. 3 N., R. 57 W., 6th P.M.	1 41 551	i.e.		2011	Kigit			
1	Sav-O-Mat, Inc.	601 Main St.	NW 1/4, Sec 6,	75			17,925		882896	NCT17266	
	7268 S. Tucson Way	Fort Morgan, CO 80701									
	Centennial, CO 80112										
				700							
TE-1	Same as above	Same as above	Same as above	730							Temporary Easement for driveway & sidewalk construction
2	BBR, LLC	1997 East Platte Ave.	NE 1/4, Sec 5,	395			43,508		881476	NCT17219	
	104 Bachar Drive	Fort Morgan, CO 80701					,				
	Fort Morgan, CO 80701										
TE-2	Same as above	Same as above	Same as above	546							Temporary Easement for road construction
TE-2A	Same as above	Same as above	Same as above	560							Temporary Easement for road construction
3	Michael Eugene &	20017 Hwy 34	NW 1/4, Sec 4,	1,302			117,103		883498	NCT17221	
	James Allen Terry	Fort Morgan, CO 80701	1444 1/4, 000 4,	1,302			117,100		000490	NOTITZZI	
	20017 Hwy 34	l commence of the commence of						+			
	Fort Morgan, CO 80701										
4	Fiebig Farm, LLC	20012 Hwy 34	SE 1/4 Sec 5,	1,725				2,291,755	886725	NCT17267	
	940 County Rd 119	Fort Morgan, CO 80701									
	Hesperus, CO 81326										
5	Same as above	Same as above	SW 1/4, Sec 4,	32,474				2,523,687	886726	NCT17277	
											NOTE: REMAINDER AREAS BASED ON
								1	1		COUNTY ASSESSOR RECORDS

Region 4

1420 2nd Street Greeley, CD 80631

Phone: 970-350-2161 FAX: 970-350-2223

	Sheet Revisions			Sheet Revisions			Sheet Revisions	
Date	Description	Initials	Date	Description	Initials	Date	Description	Initials

Project Control Diggram Title Sheet Project Number: FSA 0343-037 Project Location: US 34 Signals in Ft. Morgan phase 2

DEPARTMENT OF TRANSPORTATION **STATE OF COLORADO**

INDEX OF SHEETS SHEET NO. (1) Title Sheet

Project Code: Last Mod. Date 18837 03-14-2013

3.02

3.03

(1) Coordinate Tables

(1) Plan Sheet

(3) Total Sheets

1 1QUARTER, SIXTEENTH, SECTION CORNER AND SECTION CORNERS 1 SET EASMENT TEMPORARY RIGHT OF WAY EASMENT POINT QUARTER, SIXTEENTH, BLM MARKER PROPERTY PIN NOAA MARKER AND SECTION CORNERS O WC O FED USGS WC BENCH MARK USGS MARKER FEDERAL MONUMENT WITNESS CORNER П ROW LOCAL OR PLSS SECONDARY CONTROL MONUMENT MONUMENT MARKER N 10.13
 E 3.81
 EL 0.00 ▲N 9.88 E 3.81 EL 0.00 E 3.81 EL 0.00 PROJECT CONTROL DENSIFICATION HIGH ACCURACY REFERENCE

Note: For a complete listing of symbololgy used within this set of plans, please refer to the M-100-1 Standard Symbols of the Colorado Department of Transportation M&S Standards Publication dated July 2012. Existing features are shown as screened weight (gray scale). Proposed or new features are shown as full weight without screening.

CONTROL MONUMENT. NETWORK CONTROL MONUMENT




CM-MP - Control Point Monuments set by CDDT. They are CDDT Type 5 monuments, a 2" dia. aluminum control monument cap (as shown)

General Notes:

- 1. This Project Control Diagram is not a boundary survey of the adjoining property and is prepared for the Colorado Department of Transportation purposes only.
- 2. This plan set is subject to change and may not be the most current set. It is the user's responsibility to verify with CDOT that this set is the most current. The information contained on the attached drawing is not valid unless this copy bears an original signature of the Professional Land Surveyor hereon named.
- 3. Refer to the M-629-1 Survey Monuments of the Standard Plans dated July, 2012 found in The Colorado Department of Transportation, M & S Standards for typical survey monument descriptions.

US Highway 34 MP 62.89 to 63.00 Section 6 Township 3 North, Range 57 West of the 6th Principal Meridian County of Moraan

PROJECT CONTROL DIAGRAM

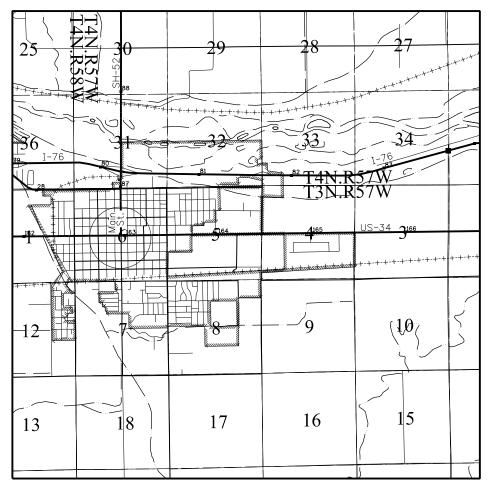

PROJECT LOCATION MAP



BASIS OF BEARINGS: Bearings used in the calculations of coordinates are based on a grid bearing of N 73° 29 '58" E (284.52') from the Control Point "CM 6299" (CDOT Type 5 Monument, MP 162.99), Section 6, Township 3 North, Range 57 West, Sixth P.M. and the Control Point "CM 6303" (CDDT Type 5 Monument, MP 163.03), Section 6, Township 3 North, Range 57 West, Sixth P.M. as obtained from a Global Positioning System (GPS) survey based on the Colorado High Accuracy Reference Network (CHARN).

Basis of Elevations: Project elevations are GPS derived, using GEDID 03, based on a NAVD 88 elevation of 1316.837m on NGS Benchmark "G 418" (Stamped "G 418 1984") NGS stainless steel deep rod in box.

COORDINATE DATUM: Project coordinates are modified Colorado State Plane North Zone NAD 83(2007) coordinates. The CHARN is based on NAD 83(2007) datum. The project seed point coordinates are: Northing = 408398.400m, Easting = 1058928.049m, and Elevation = 1318.317m. The ground scale factor used to modify the coordinates is 1.0002466992. Project Coordinates are truncated by 350,000m in the Northing and 1,000,000m in the Easting.

To get from Project to State Plane coordinates: add the truncation, subtract the seed point northing and easting, divide by the ground scale factor, then add the seed point northing and easting.

NOTICE: According to Colorado law you must commence any legal action based upon any defect in this survey within three years after you first discover such defect. In no event may any action based upon any defect in this survey be commenced more than ten years from the date of the certification shown hereon.

SURVEYOR STATEMENT (PROJECT CONTROL DIAGRAM)

I, Edward C. Warwick, a professional land surveyor licensed in the State of Colorado, do hereby state to the Colorado Department of Transportation this Project Control Diagram was prepared and the field survey it represents was performed under my responsible charge and, based upon my knowledge, information and belief is in accordance with applicable standards of practice defined by Colorado Department of Transportation publications. This statement is not a guaranty or warranty, either expressed or implied.

PLS No. 29056

set in concrete.

1420 Second Street Greeley, CO 80631 Phone: 970-350-2161 FAX: 970-350-2223 Region 4

MDG

	Sheet Revisions			Sheet Revisions			Sheet Revisions	
Date	Description	Initials	Date	Description	Initials	Date	Description	Initials
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Project Control Diagram										
Coordinate Tables										
roject Number: FSA 0343-037										
reject Legation, US 34 Signals in Fort Morgan Dhage 2										

 Project Code:
 Last Mod. Date
 Subset
 Sheet No.

 18837
 03-14-2013
 3.02 of 3.03
 3.02



GEODETIC COORDINATE TABLE (adjusted field data) (meters)


Point Name	COORDINATE	S NAD-83(2007)	ELLIP.	MAPPING	SCALE	NAD 83(2007)	ZONE 0501	Description
Point Name	LATITUDE(N)	LONGITUDE(W)	HEIGHT	ANGLE	SCALE	NORTHING	EASTING	Description
CM 6289 CM 6299 CM 6303	40ø 15' 14.84007" 40ø 15' 14.11090" 40ø 15' 14.85750"	103ø 48' 10.45369" 103ø 48' 03.77093" 103ø 48' 00.23381"	1299.204 1298.798 1298.610					CDOT Type 5 Monument MP 162.89 CDOT Type 5 Monument MP 162.99 CDOT Type 5 Monument MP 163.03
LK0368 LK0372 AG9852 CDOT	40ø 14' 45.44505" 40ø 15' 53.89872" 40ø 15' 07.72896" 40ø 16' 04.07696"	103ø 53' 37.15243" 103ø 48' 46.94798" 103ø 45' 34.21944" 103ø 49' 31.50516"	1322.407 1297.325 1290.731 1306.145	1ø 02' 16" 1ø 05' 24" 1ø 07' 29" 1ø 04' 55"	0.999956850 0.999956877 0.999956846 0.999956890	407367.585 409605.875 408270.134 409899.794	1051067.161 1057884.556 1062465.359 1056826.040	NGS Stainless steel rod (C418) NGS Stainless steel rod (G418) Brass disk in conc post (Industrial) Leica Network Receiver (Ft Morgan CDOT)



▲ PROJECT COORDINATE SUMMARY TABLE (feet)

Point Name	PROJECT CO		ELEV. (NAVD 88)	Description
	NORTHING	EASTING	(NAVD 88)	•
CM 6289	191659.283	192813.543	4326.503	CDOT Type 5 Monument MP 162.89
CM 6299	191595.416	193333.108	4325.178	CDOT Type 5 Monument MP 162.99
CM 6303	191676.227	193605.911	4324.561	CDOT Type 5 Monument MP 163.03
LK0368	188212.650	167536.481	4402.376	NGS Stainless steel rod (C418)
LK0372	195557.919	189908.737	4320.323	NGS Stainless steel rod (G418)
AG9852	191174.496	204941.295	4298.814	Brass disk in conc post (Industiral)
CDOT	196522.455	186435.065	4349.176	Leica Network Receiver (Ft Morgan CDOT)

Project Control Diagram Sheet Revisions Sheet Revisions Sheet Revisions Colorado Department of Transportation Plan Sheet Project Number: FSA 0343-037 1420 2nd Street Greeley, CD 80631 Phone: 970-350-2161 FAX: 970-350-2223 Project Location: US 34 Signals in Fort Morgan Phase 2 Region 4 MDG \bigcirc CM 6303 -MP 163.03 N.T.S. CM 6289 -MP 162.89 U.S. 34 -CM 6299 MP 162.99

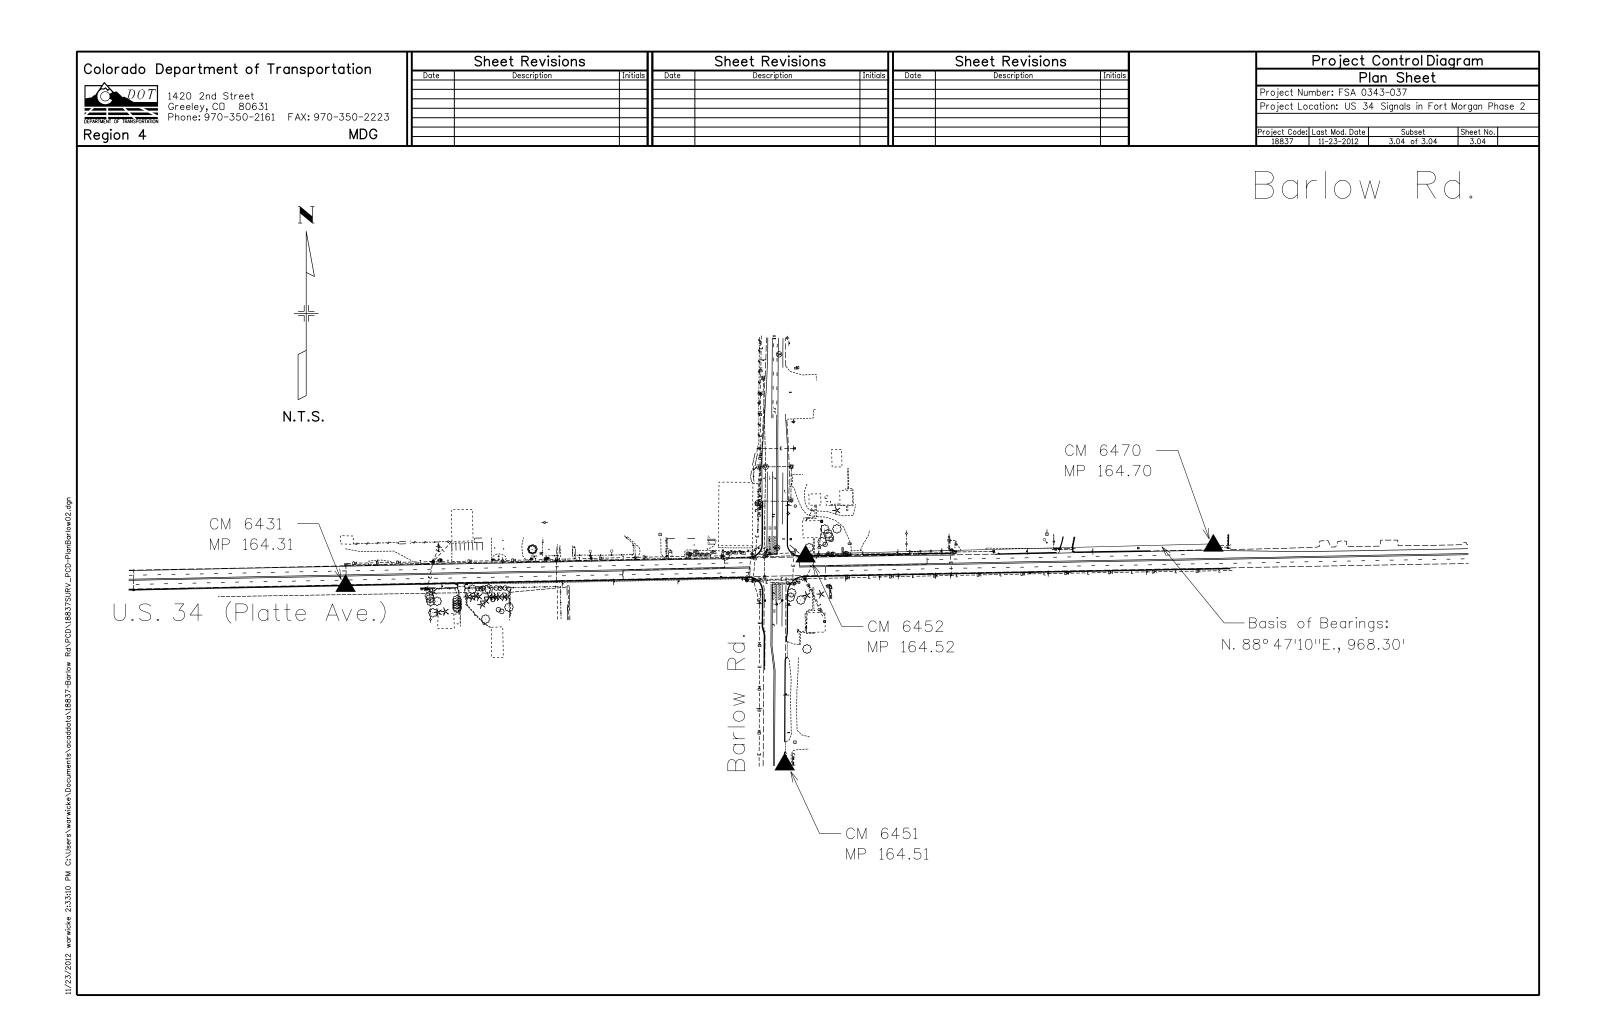

 $\bigcirc DOT$

1420 2nd Street

Greeley, CD 80631 Phone: 970–350–2161 FAX: 970–350–2178 Region 4 Right of Way PTS

	Sheet Revisions			Sheet Revisions			Sheet Revisions	
ate 💮	Description	Initials	Date	Description	Initials	Date	Description	Initials

Land Survey Control Diagram							
Title Sheet							
Project Number: FSA 0343-037							
Project Location: US 34 Signals in Fort Morgan Phase 2							
roject Code:	Last Mod. Date	Subset	Sheet No.				
18837	12-28-12	4.01 to 4.03	4.01				

Monument Coordinate Tables

INDEX OF SHEETS

(1) Title Sheet

Plan Sheet

(3) Total Sheets

$\sqrt{1}$ QUARTER, SIXTEENTH, SECTION CORNER (1) 1 SET EASEMENT TEMPORARY EASEMENT POINT RIGHT OF WAY MONUMENT MARKER O NOAA QUARTER, SIXTEENTH, NDAA MARKER AND SECTION CORNERS PROPERTY PIN BLM MARKER O FED W.C. USGS MARKER WITNESS CORNER FEDERAL MONUMENT ⊡ LOCAL OR PLSS SECONDARY CONTROL RIGHT OF WAY MONUMEN1 © N 10.13 E 3.81 EL 0.00 ●N 10.38 E 3.81 EL 0.00 E 3.81 EL 0.00


DENSIFICATION

CONTROL MONUMENT

DEPARTMENT OF TRANSPORTATION STATE OF COLORADO

LAND SURVEY CONTROL DIAGRAM

US Highway 34 MP 162.8 to 163.2 & 164.3 to 164.7 Sections 4.5. & 6 Township 3 North, Range 57 West of the 6th Principal Meridian County of Morgan

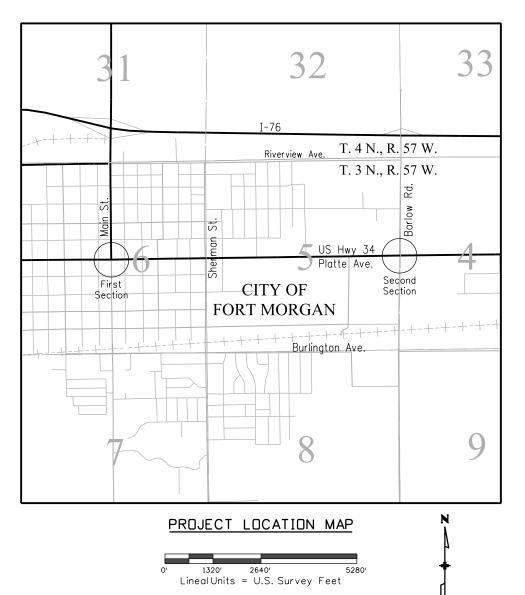

Basis of Bearings (Main St.): Bearings used in the calculations of coordinates are based on a grid bearing of N73° 29'58"E (284.52') from the Control Point "CM 6299" (CDDT Type 5 Monument, MP 162.99), Sec. 6, T3N, R57W, 6th P.M. and the Control Point "CM 6303" (CDDT Type 5 Monument, MP 163.03), Sec. 6, T3N. R57W. 6th P.M. as obtained from a Global Positioning System (GPS) survey based on the Colorado High Accuracy Reference Network (CHARN).

SHEET NO.

4.02

4.03

Basis of Bearings (Barlow Rd.): Bearings used in the calculations of coordinates are based on a grid bearing of N88° 47'10"E (968.30') from the Control Point "CM 6452" (CDOT Type 5 Monument, MP 164.52), Sec. 4, T3N, R57W, 6th P.M. and the Control Point "CM 6470" (CDDT Type 5 Monument, MP 164.70), Sec. 4, T3N, R57W, 6th P.M. as obtained from a Global Positioning System (GPS) survey based on the Colorado High Accuracy Reference Network (CHARN).

Basis of Elevations: Project elevations are GPS derived, using GEDID 03, based on a NAVD 88 elevation of 1316.837m on NGS Benchmark "G 418" (Stamped "G 418 1984") NGS stainless steel deep rod in box.

COORDINATE DATUM: Project coordinates are modified Colorado State Plane North Zone NAD 83(2007) coordinates. The CHARN is based on NAD 83(2007) datum. The project seed point corrdinates are: Northing = 408398.400m. Easting = 1058928.049m, and Elevation = 1318.317m. The ground scale factor used to modify the coordinates is 1.0002466992. Project coordinates are truncated by 350,000m in the Northing and 1,000,000m in the Easting.

NOTICE: According to Colorado law you must commence any legal action based upon any defect in this survey within three years after you first discover such defect. In no event may any action based upon any defect in this survey be commenced more than ten years from the date of the certification shown hereon.

Note: For a complete listing of symbology used within this set of plans, please refer to the M-100-1 Standard Symbols of the Colorado Department of Transportation M&S Standards Publication dated July 2012. Existing features are shown as screened weight (gray scale). Proposed or new features are shown as full weight without screening.

SURVEYOR STATEMENT (LAND SURVEY CONTROL DIAGRAM)

I, I. Jeffrey Nading, a professional land surveyor licensed in the State of Colorado, do hereby state to the Colorado Department of Transportation this Land Survey Control Diagram was prepared and the field survey it represents was performed under my responsible charge and, based upon my knowledge, information and belief is in accordance with applicable standards of practice defined by Colorado Department of Transportation publications. This statement is not a guaranty or warranty, either expressed or implied.

PLS No. 37885

General Notes:

PROJECT CONTROL

1. This Land Survey Control Diagram is not a boundary survey of the adjoining property and is prepared for the Colorado Department of Transportation purposes only.

HIGH ACCURACY REFERENCE

NETWORK CONTROL MONUMENT

- 2. Title policy, title commitment, and title research are not part of this survey, therefore easements, rights, and restrictions of record were not researched and are not shown on this diagram. The verification of the physical evidence with relation to easements, rights of ways, property boundaries, and restrictions, as described in the instruments of record, were not included in this land survey control diagram.
- 3. This plan set is subject to change and may not be the most current set. It is the user's responsibility to verify with CDDT that this set is the most current. The information contained on the attached drawing is not valid unless this copy bears an original signature of the Professional Land Surveyor hereon named.
- 4. Refer to the M-629-1 Survey Monuments of the Standard Plans dated July, 2012 found in The Colorado Department of Transportation, M & S Standards for typical survey monument descriptions.

Region 4 Right of Way

1420 2nd Street
Greeley, CD 80631
Phone: 970-350-2161 FAX: 970-350-2178

	Sheet Revisions			t Revisions Sheet Revisions			Sheet Revisions		
Date	Description	Initials	Date	Description	Initials	Date	Description	Initials	
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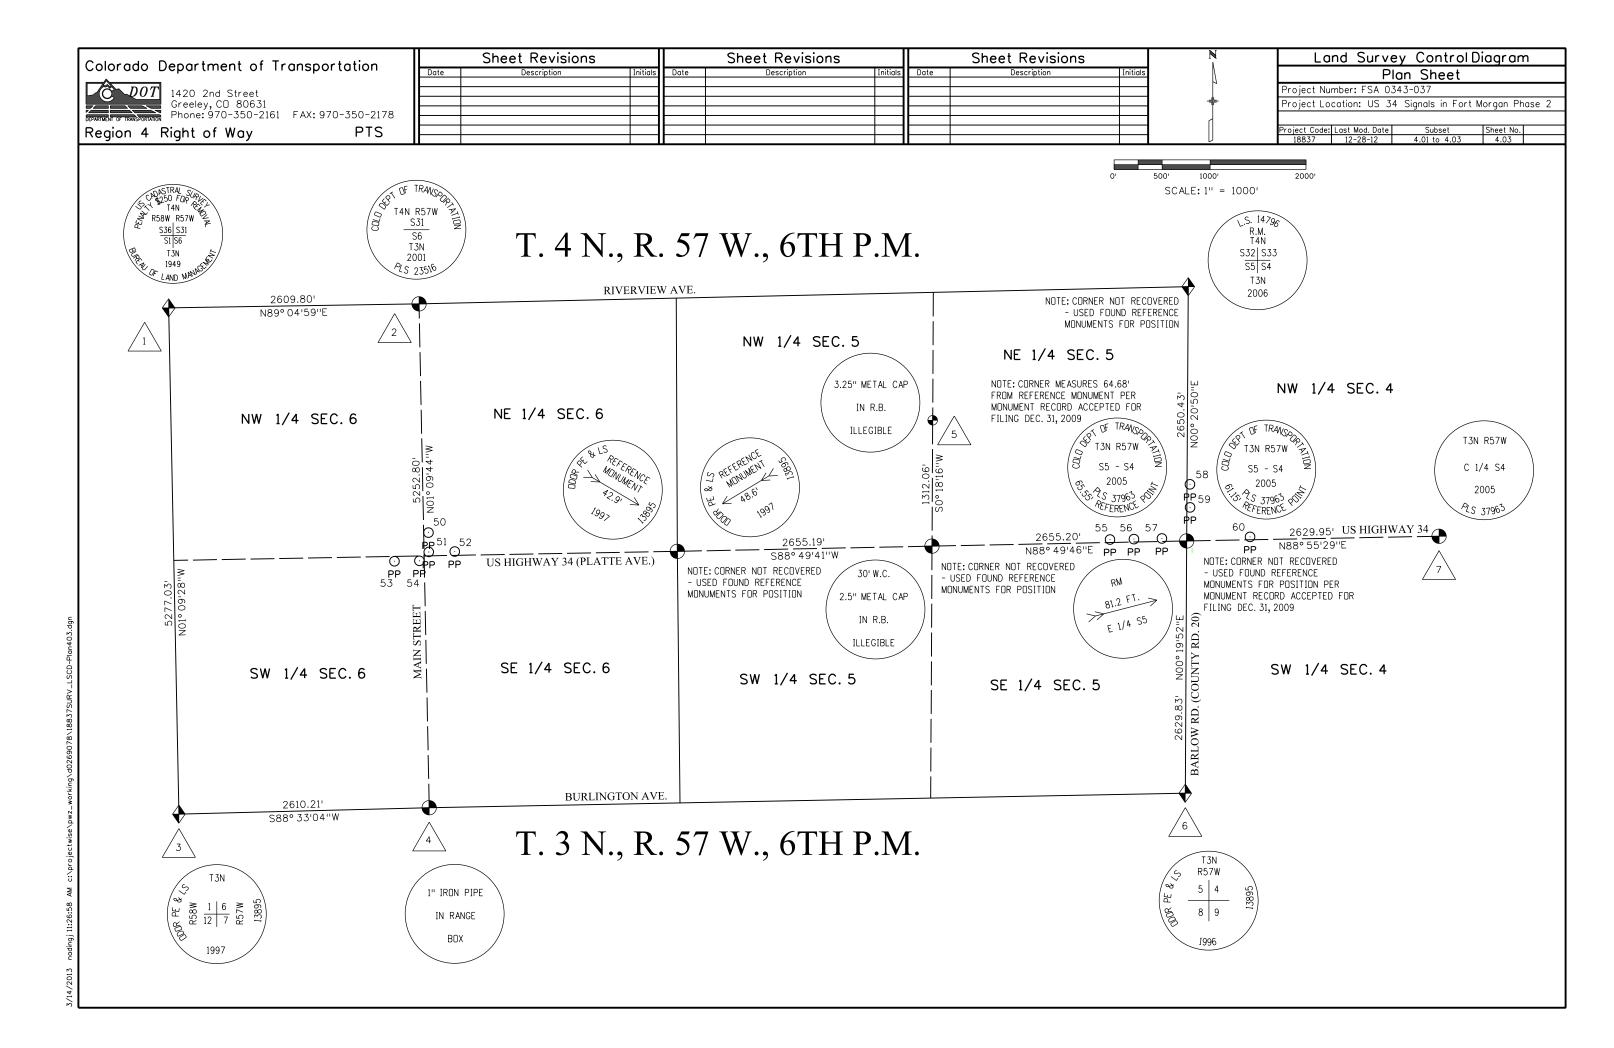
PP

Land Survey Control Diagram Monument Coordinate Tables

Project Number: FSA 0343-037
Project Location: US 34 Signals in Fort Morgan Phase 2

\Diamond	FOUND ALIQUOT MONUMENT COORDINATE TABLE							
	Point No.	Northing(ft)	Easting(ft)	Description				
	1	194209.82	190549.59	3.25" Brass Cap in Mon. Box				
	2	194251.59	193159.05	3.25" Alum. Cap in Mon. Box				
	3	188933.86	190656.22	2.5" Alum. Cap in Mon. Box				
	4	188999.87	193265.60	1" Iron Pipe in Mon. Box				
	5	193038.68	198513.17	3.25" Metal Cap in Mon. Box				
	6	189151.10	201145.65	2.5" Alum. Cap in Mon. Box				
	7	191830.23	203790.33	3.25" Alum. Cap in Mon. Box				

	FOUND BOUNDARY MONUMENT COORDINATE TABLE						
Point No.	Northing(ft)	Easting(ft)	Description				
50	191867.71	193256.90	1.5" Alum. Cap				
51	191665.77	193260.96	1.5" Alum. Cap				
52	191670.73	193530.94	1.5" Alum. Cap				
53	191569.08	192902.71	1.25" Alum. Cap				
54	191573.95	193162.95	#5 Rebar with Plastic Cap				
55	191795.15	200361.12	#4 Rebar with Plastic Cap				
56	191800.24	200610.37	Bent #4 Rebar with Plastic Cap				
57	191806.41	200901.93	#5 Rebar with Plastic Cap				
58	192371.54	201194.43	Rebar with Plastic Cap				
59	192130.54	201195.61	#4 Rebar				
60	191823.04	201821.10	Rebar with Plastic Cap				



1420 2nd Street Greeley, CD 80631 Phone: 970-350-2161 FAX: 970-350-2178

	Sheet Revisions			Sheet Revisions			Sheet Revisions	
Date	Description	Initials	Date	Description	Initials	Date	Description I	nitials

Right of Way Plans Monumentation Sheet Project Number: FSA 0343-037 Project Location: US 34 Signals in Fort Morgan Phase 2

$\langle xxx \rangle$

Region 4 Right of Way

	TABULATION OF R.O.W. MONUMENTS TO BE SET							
Point No.	Northing(ft)	Easting(ft)	Description					
100	191668.97	193160.88	ROW					
101	191653.79	193151.18	ROW					
108	191809.26	201081.04	ROW					
109	191817.30	201084.00	ROW					
110	191819.07	201108.08	ROW					
111	191845.07	201121.24	ROW					
120	191866.64	201201.37	ROW					
121	191827.05	201222.75	ROW					
122	191827.61	201252.75	ROW					
123	191812.88	201267.02	ROW					
126	191748.62	201050.68	ROW					
127	191724.53	201095.52	ROW					
128	191673.05	201120.22	ROW					
131	191687.29	201200.31	ROW					
132	191710.28	201210.14	ROW					
133	191727.47	201246.25	ROW					
134	191750.65	202481.03	ROW					
135	191775.66	202481.18	ROW					

•
XXX

T	TABULATION OF TEMPORARY EASEMENT POINTS TO BE STAKED						
Point No.	Northing(ft)	Easting(ft)	Description				
103	191653.19	193117.68	TE				
104	191671.69	193117.31	TE				
105	191672.47	193160.81	TE				
112	191808.08	201023.59	TE				
113	191819.63	201023.36	TE				
114	191817.83	201046.74	TE				
115	191817.24	201066.35	TE				
116	191875.15	201108.42	TE				
117	191875.07	201121.42	TE				



	TABULATION OF ALIQUOT MONUMENTS TO BE SET							
7	Point No.	Northing(ft)	Easting(ft)	Description				
	8	191780.88	201160.85	CDOT Type 3A Monument				

 \odot

	TABULATION OF "FOR INFORMATION ONLY" POINTS									
Point No.	Northing(ft)	Easting(ft)	Description							
102	191653.97	193161.18								
106	191825.07	201121.12								
107	191809.77	201106.03								
118	191816.64	201201.06								
119	191811.73	201206.03								
124	191749.75	201105.67								
125	191735.05	201120.58								
129	191751.90	201215.68								
130	191736.62	201200.59								

QUANTITY OF MONUMENTS TO BE SET

: 1											
5	CAP	MONUMENT TYPE									
- 7	TYPE	1	1A	2	2A	3	<i>3A</i>	4	5	5(S)	6
2	REFERENCE										
	ROW	18									
;	CONTROL										
	ALIQUOT CORNER						1				
	PERMANENT EASEMENT										
6	PROJECT POINTS										
:											
7 / /	WITNESS POST (REQUIRED)										

General Notes:

- 1. All centerline and offset stationing may not represent the centerline as constructed in the field.
- 2. Refer to the M-629-1 Survey Monuments of the Standard Plans dated July, 2012 found in The Colorado Department of Transportation, M & S Standards for survey monument descriptions.
- 3. This plan set is subject to change and may not be the most current set. It is the user's responsibility to verify with CDOT that this set is the most current. The information contained on the attached drawing is not valid unless this copy bears an original signature of the Professional Land Surveyor hereon named.


COORDINATE DATUM: Project coordinates are modified Colorado State Plane North Zone NAD 83(2007) coordinates. The CHARN is based on NAD 83(2007) datum. The project seed point corrdinates are: Northing = 408398.400m, Easting = 1058928.049m, and Elevation = 1318.317m. The ground scale factor used to modify the coordinates is 1.0002466992. Project coordinates are truncated by 350,000m in the Northing and 1,000,000m in the Easting.


NOTICE: According to Colorado law you must commence any legal action based upon any defect in this survey within three years after you first discover such defect. In no event may any action based upon any defect in this survey be commenced more than ten years from the date of the certification shown hereon.


SURVEYOR STATEMENT (R.O.W. MONUMENTS)


I, I. Jeffrey Nading, a professional land surveyor licensed in the State of Colorado, do hereby state to the Colorado Department of Transportation that based upon my knowledge, information and belief, adequate research, calculations and evaluation of survey evidence were performed and the Right-of-Way monuments depicted on this Right-of-Way Plan were set under my responsible charge in accordance with applicable standards of practice defined by Colorado Department of Transportation publications. This statement is not a guaranty or warranty, either expressed or implied.

PLS No. 37885

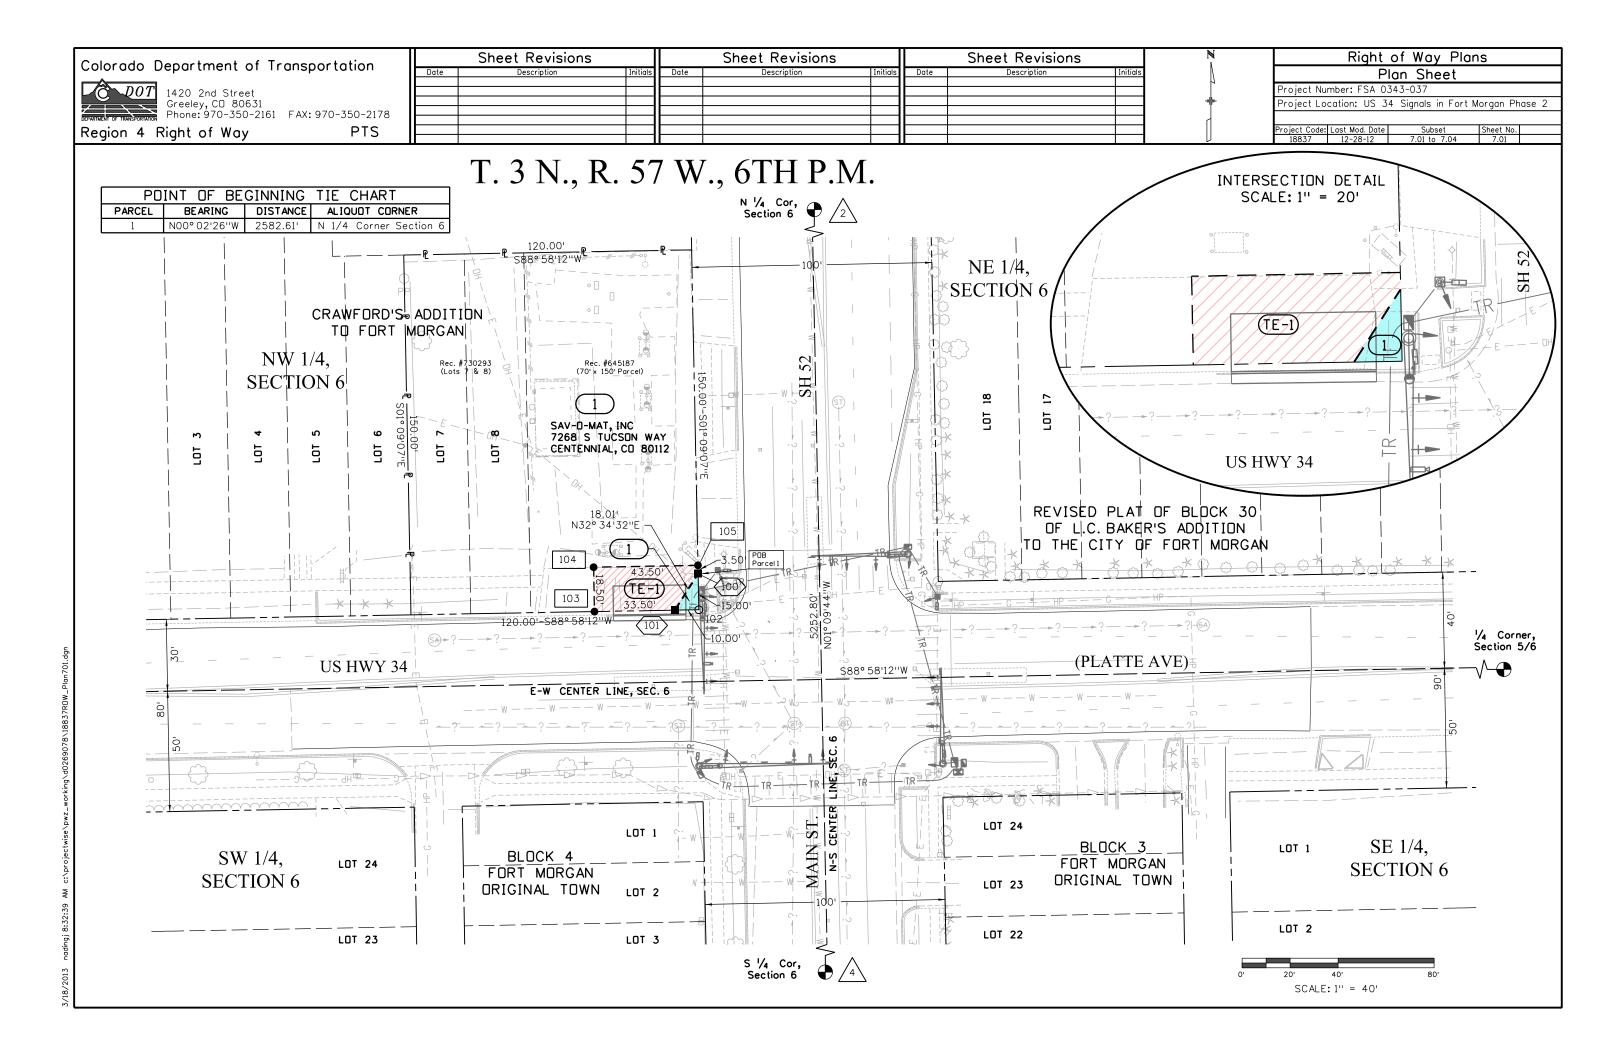

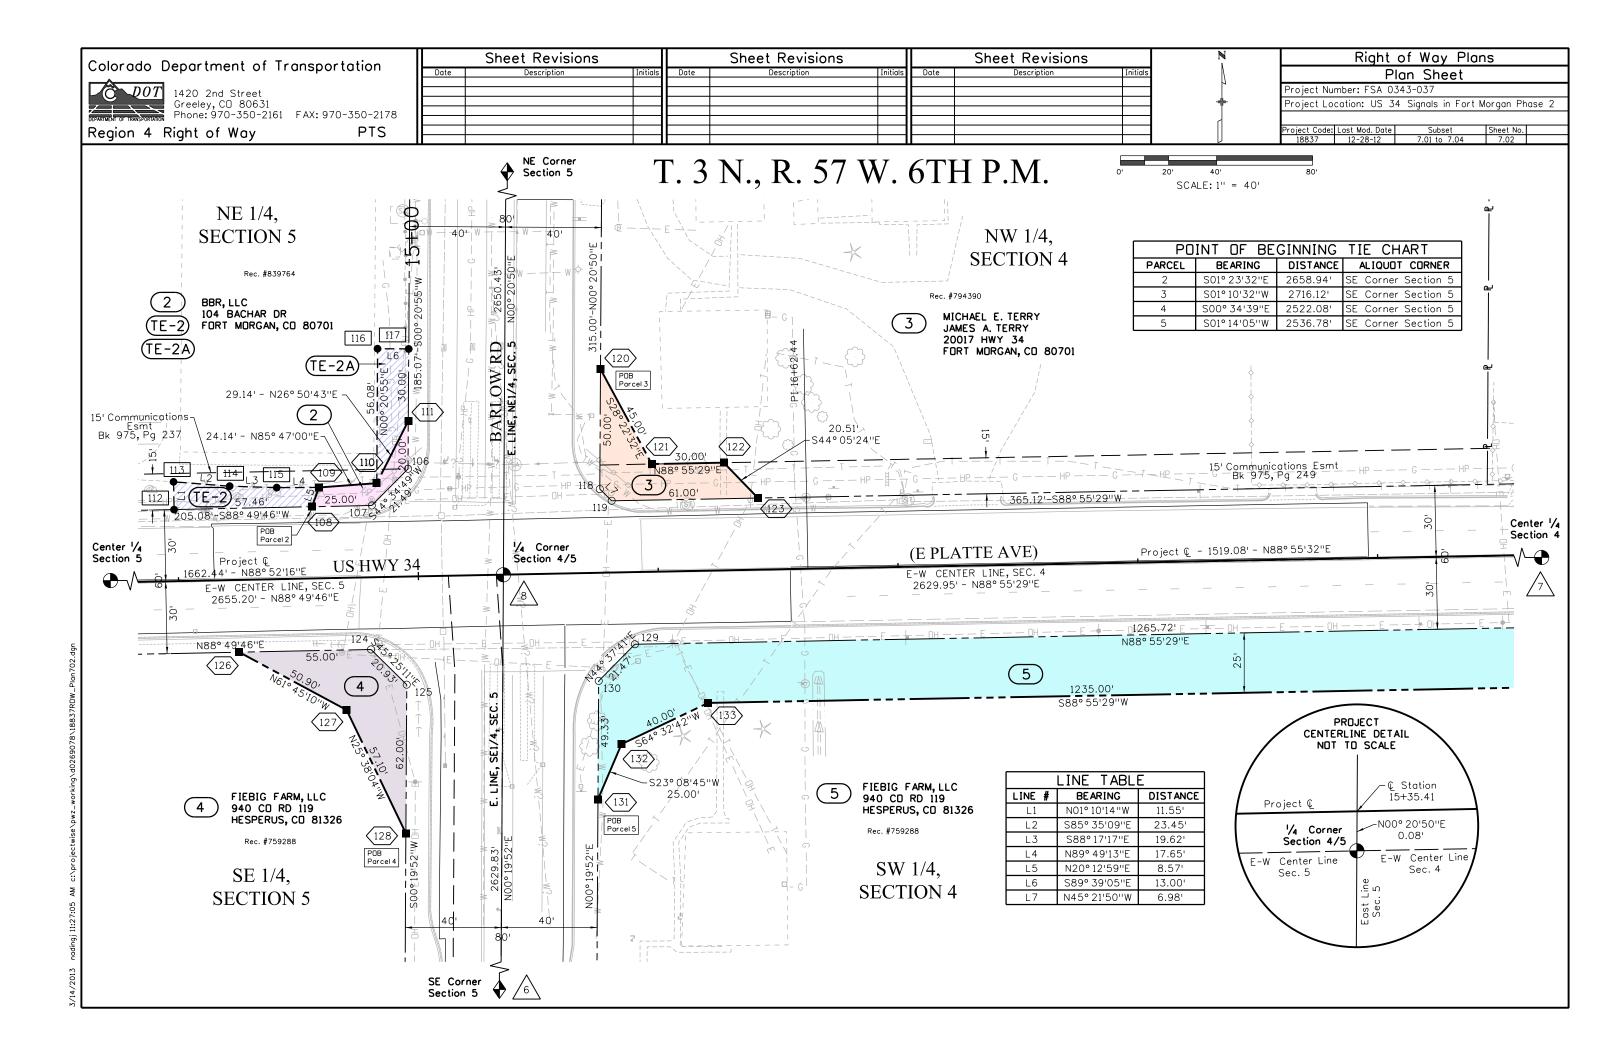

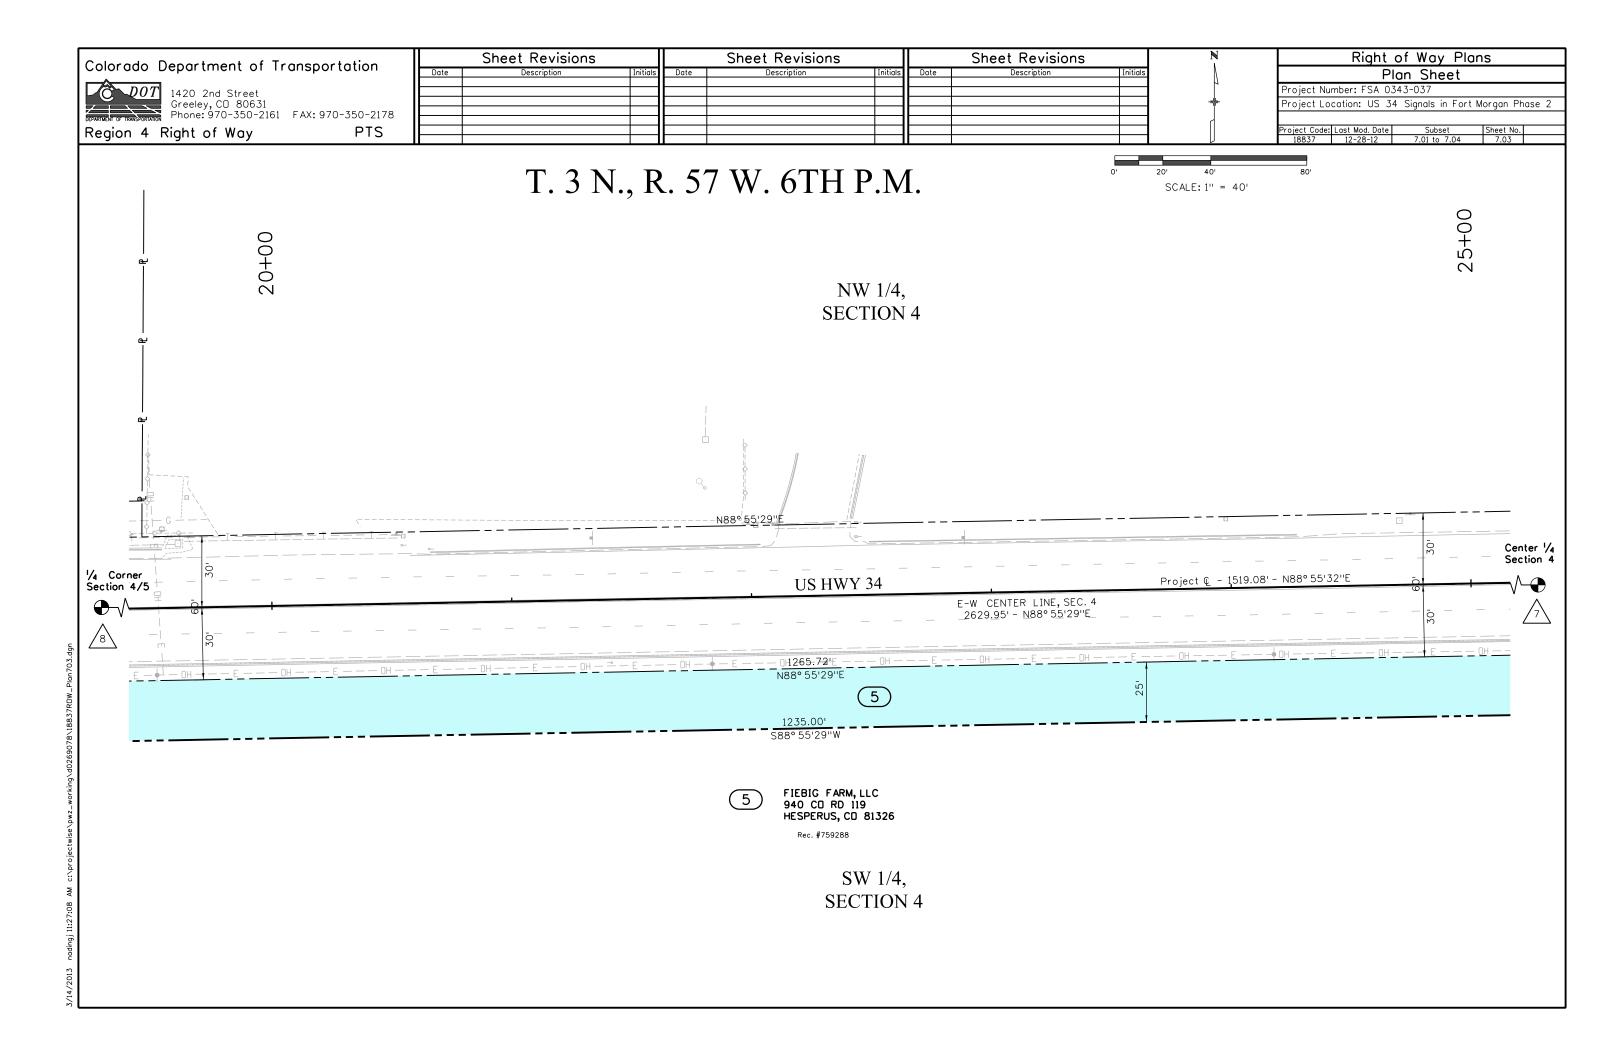

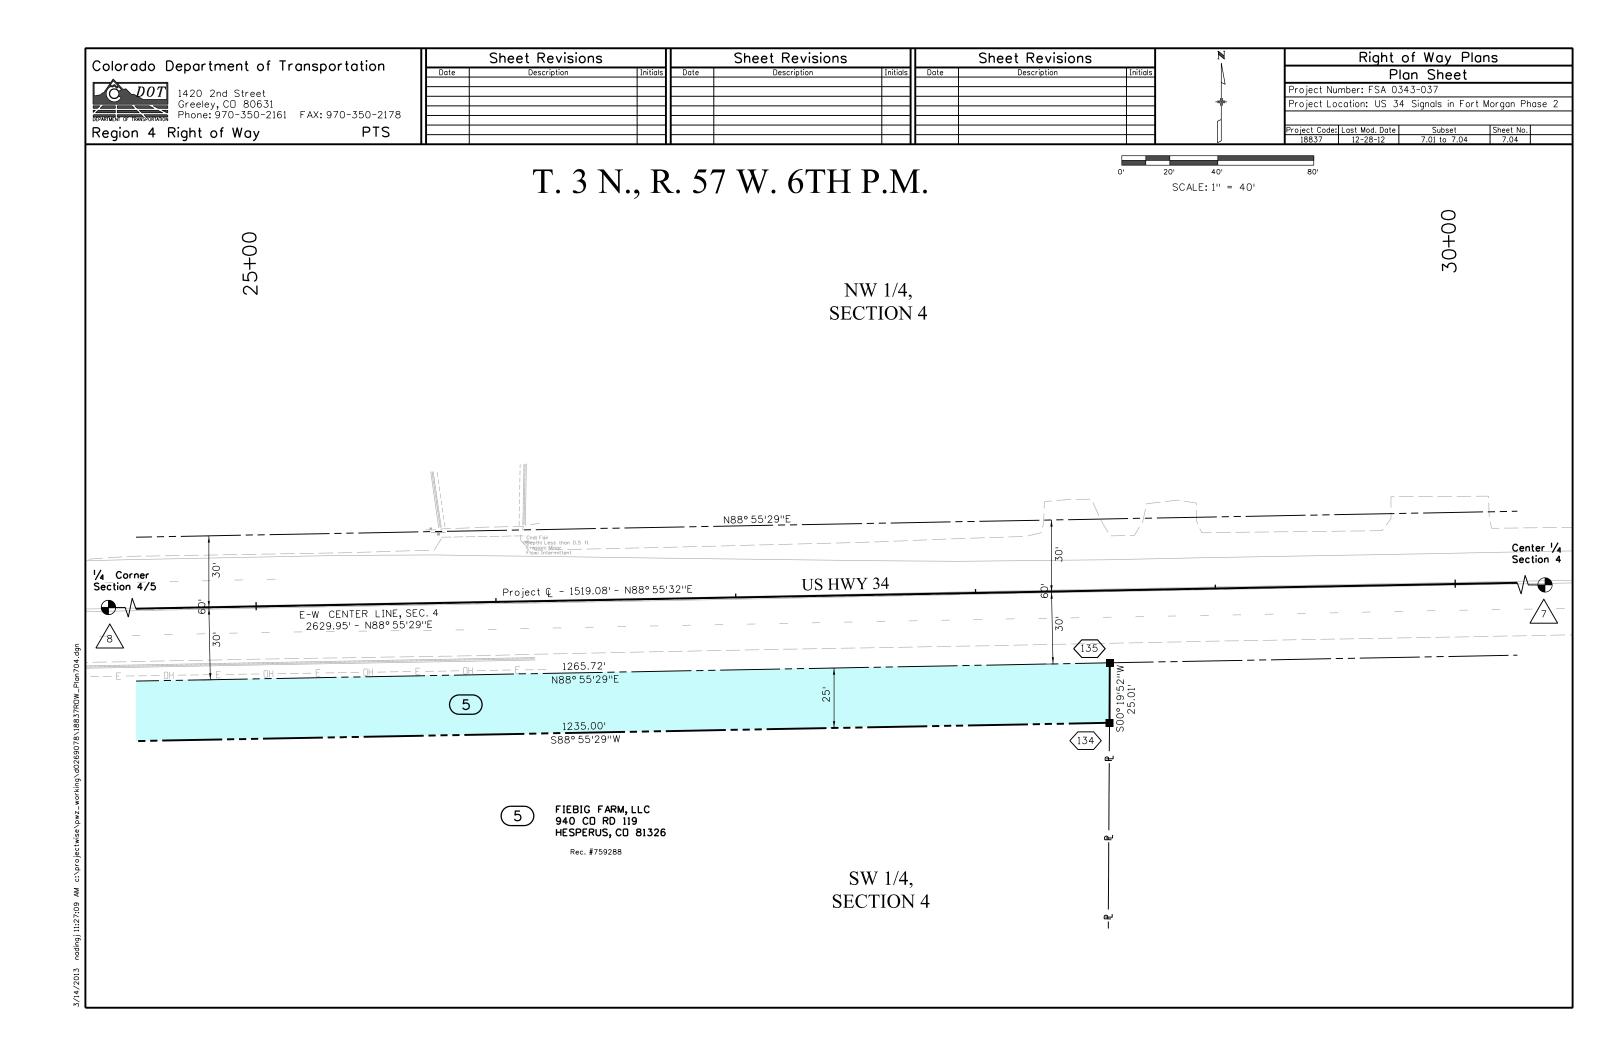

DOT

DOT 1420 2nd Street Greeley, CD 80631 Phone: 970-350-2161 FAX: 970-350-2178

Region 4 Right of Way

	Sheet Revisions			Sheet Revisions		Sheet Revisions			
Date	Description	Initials	Date	Description	Initials	Date	Description	Initials	
				<u>'</u>					

Right of Way Plans

Ownership Sheet

Project Number: FSA 0343-037

Project Location: US 34 Signals in Fort Morgan Phase 2

0' 50' 100' 200' Scale: 1''=100'

NOTE: FEMA FLOOPLAIN MAP NO. 080129 0200 C DATED SEPTEMBER 29, 1989 WAS RELIED UPON FOR INFORMATION REGARDING FLOODPLAIN BOUNDARIES. SUBJECT PROPERTY DOES NOT LIE WITHIN A FLOODPLAIN.

T. 3 N., R. 57 W., 6TH P.M.

