1

SECTION CORNER

(1)

SET EASEMENT

FED

FEDERAL MONUMENT

LOCAL OR PLSS

MONUMENT

TOE OF FILL

**TERRAIN** 

BLM MARKER

Region 5

3803 North Main Avenue Suite 300 Durango, CO 81301

1

TEMPORARY

WC

SECONDARY CONTROL

WITNESS CORNER

O N 10.13

E 3.81 EL 0.00

NOAA

Phone: 970-385-1400 FAX: 970-385-1410 TCJ

RIGHT OF WAY

0 QUARTER, SIXTEENTH,

USGS

USGS MARKER

ROW

RIGHT OF WAY

NOAA MARKER AND SECTION CORNERS

**№** N 10.38

E 3.81 EL 0.00

BENCH MARK

1

QUARTER, SIXTEENTH

AND SECTION CORNERS

	Sheet Revisions			Sheet Revisions	
Date	Description	Initials	Date	Description	Initials
m/dd/yy	XXXXXXXX	XXX	mm/dd/yy	XXXXXXX	XXX



	="	Right o	of Way Plan	ns
		Tit	le Sheet	
Project Num	ber:	NHPP 550	2-077	
Project Loca	ition:	US 550 R	ockfall Mitigation	North of Ridgwa
		M.P. 106.	11 to M.P. 106.6	6
Project Code:	Last M	od. Date	Subset	Sheet No.
19860	05-0	5-2014	1.01 of 1.01	1.01

## **DEPARTMENT OF TRANSPORTATION** STATE OF COLORADO

RIGHT OF WAY PLANS of PROPOSED STATE PROJECT NO. NHPP 5502-077 U.S. HWY, NO. 550

SEC. 4, T. 45 N., R. 8 W., N.M.P.M

SEC. 33, T. 46 N., R. 8 W., N.M.P.M

**OURAY COUNTY** 550 35 36 T46N.R8W T45N.R8W 10 Ridgway 13

Original Scale: 1"=1 Mile

Linear Units = U.S. Survey Feet

Sta. 34+11.47 End Construction Project: NHPP 5502-077 MP: 106.48

#### **INDEX OF SHEETS**

(1) Title Sheet

SHEET NO.

1.01

2.01-2.01

3.01-3.04

4.01-4.03

5.01

6.01-6.0X

7.01-7.03

- (1) Tabulation of Properties
- (4) Project Control Diagram
- Land Survey Control Diagram
- (1) Monumentation Sheets
- (NA) Tabulation of Road Approach Sheets
- (3) Plan Sheets
- (1) Ownership Sheet

(14) Total Sheets

#### Scales of Original 11x17 Drawings

Plan Sheets: 1"=100"

Project Control Diagram Sheets: 1"=400' Land Survey Control Diagram: 1"=400'

Ownership Sheet: 1"=400"

Basis of Bearings: Bearings used in the calculations of coordinates are based on a grid bearing of N16°01'33"E from CM 300 to CM 400. Both monuments are CDOT Type II, marked appropriately for their milepost location and control position. The survey data was obtained from a Global Positioning System (GPS) survey based on NGS passive marks.

- 1. This Right-of-Way Plan is not a boundary survey of the adjoining property and is prepared for the Colorado Department of Transportation purposes only.
- 2. This plan set is subject to change and may not be the most current set. It is the user's responsibility to verify with CDOT that this set is the most current. The information contained on the attached drawing is not valid unless this copy bears an original signature of the Professional Land Surveyor hereon named.
- 3. The parcels shown within these ROW plans have been determined based on Title Committments provided by H.C. Peck and Company.

NOTICE: According to Colorado law you must commence any legal action based upon any defect in this survey within three years after you first discover such defect. In no event may any action based upon any defect in this survey be commenced more than ten years from the date of the certification shown hereon.

#### COLORADO DEPARTMENT OF TRANSPORTATION STATE HIGHWAY PROJECT

ROW PLANS AUTHORIZED:

CDDT RIGHT DF WAY MANAGER

mmino

#### SURVEYOR STATEMENT (ROW PLAN)

I, Randy N. Crumbaugh, a professional land surveyor licensed in the State of Colorado, do hereby state to the Colorado Department of Transportation that based upon my knowledge, information and belief, research, calculations and evaluation of the survey evidence were performed and this Right-of-Way Plan was prepared under my responsible charge in accordance with applicable standards of practice defined by Colorado Department of Transportation publications. This statement is not a guaranty or warranty, either expressed or implied.

PLS No. 25938

Note: For a complete listing of symbology used within this set of plans, please refer to the M-100-1 Standard Symbols of the Colorado Department of Transportation M&S Standards Publication dated July 2006. Existing features are shown as screened weight (gray scale), except as noted with the word (existing). Proposed or new features are shown as full weight without screening, except as noted with the word (proposed).

PROJECT CONTROL DENSIFICATION HIGH ACCURACY REFERENCE MONUMENT CONTROL MONUMENT NETWORK CONTROL MONUMENT PERMANENT, PROPERTY, SLOPE, & UTILITY EASEMENT LINE Sta. 1198+89.64 ~ TEMPORARY FASEMENT LINE (EXISTING) Begin R.O.W. Retracement Project ~PWA 2003-B(3) PROPERTY BOUNDARY LINE (EXISTING AND PROPOSED) MP: 106.84 ACCESS CONTROL LINE End R.O.W. Project NHPP 5502-077 BARRIER ACCESS CONTROL LINE Sta. 25+54.02 MP: 106.37 RIGHT OF WAY LINE VIRGIN RIGHT OF WAY LINE (PROPOSED) Begin R.O.W. Project NHPP 5502-077 Sta. 11+76.16 MP: 106.11 COUNTY LINE (EXISTING) Sta. 1237+36.70 ~ End R.O.W. Retracement QUARTER SECTION LINE Project ~ PWA 2003-B(3) MP: 106.11 SECTION LINE SIXTEENTH SECTION LINE STATE LINE (EXISTING) TOWNSHIP LINE (EXISTING) SURVEY/ROW PROJECT LOCATION MAP

Sta. 10+00.00 Begin Construction Project: NHPP 5502-077 MP: 106.08

Region 5

3803 North Main Avenue
Suite 300
Durango, CD 81301
Phone: 970-385-1400 FAX: 970-385-1410

	Sheet Revisions			Sheet Revisions	
Date	Description	Initials	Date	Description	Initials
mm/dd/yy	XXXXXXXX	XXX	mm/dd/yy	XXXXXXXX	XXX



١	Right of Way Plans									
١	Tabulation of Properties									
١	Project Nu	mber: NHPP	5502-077							
١	Project Location: US 550 Rockfall Mitigation									
١	North of Ridgway									
-	Project Code:	Last Mod. Date	Subset	Sheet No.						
	19860	07-01-14	2.01 of 2.01	2.01						

	n.O.W. IADUL	ATION OF PROPE	TILS IN CURAT C	COUNTY U.S. NO. 550					Book and	Title	
Parcel	Our pare his Name and Mailing Address	Site Address	Location	Area In Acres ( Area Square Feet )			Page No. And/Or	Commitment	Remarks		
No.	Ownership Name and Mailing Address	S Site Address		Area Of Parcel	Existing ROW	Net Area	Remainder Left	Remainder Right	Reception No.	No.	
RW-1	Dieter Sander (deceased) and Carina Sander	SH 550 North of Ridgway	Dallas Meadows Exemp. No. 1	0.055 acres				1.16 +/-		05772A2014	Remainder is calculated from subtracting the Parcel area from the
	Mailing Address:	M.P. 106.11 Rt.	Recpt. No. 126854	(2,406)							total ownership as calculated from a combination of surveyed lin
	3609 G Road	Assessor Parcel No.	29116								and information on the Dallas Meadows Exempt. Plat No. 1
	Palisade, Colorado 81526	430504224001	SW 1/4 NE 1/4 SEC 4								Recpt. N. 126854
			T. 45 N., R. 8 W., N.M.P.M.								
RW-2	County of Ouray	SH 550 North of Ridgway	Ouray, County	5.083				11.37 +/-		05773A2014	Remainder is calculated by subtracting the parcel area from
	P.O. Box C	M.P. 106.11 Rt. To M.P. 106.42 Rt.	NW 1/4 NE 1/4 SEC. 4	(221,425)						2nd. Amended	the total area as determined by survey of found monuments.
	Ouray, CO 81427	Assessor Parcel No.	T. 45 N., R.8W., N.M.P.M.								
		430504102001	All that portion of the								
			Amended Dallas Townsite								
			Survey as recorded								
			in Bk 1 of Plats, Pg 15 Recp 24332								
			and Bk 1, Pg 20, Recpt. No. 29068	<b>†</b>							
			lying east of the existing								
			ROW of SH 550 as established								
			on Project PWA 2003-B(3) and								
			west of the new ROW line								
			shown herein.								
-											

 $\Lambda$ 

SECTION CORNER

1

SET EASEMENT

FED

FEDERAL MONUMENT

LOCAL OR PLSS

N 9.88 E 3.81 EL 0.00

PROJECT CONTROL

BLM MARKER PROPERTY PIN

Region 5

3803 North Main Avenue Durango, CO 81301 Phone: 970-385-1419 FAX: 970-385-1410

1

TEMPORARY

WC

SECONDARY CONTROL

MONUMENT

WITNESS CORNER

ON 10.13 E 3.81 EL 0.00

DENSIFICATION

NOAA

NOAA MARKER

 $\Lambda$ 

1

RIGHT DF WAY

QUARTER, SIXTEENTH,

USGS

USGS MARKER

**F** 

ROW

RIGHT OF WAY

MARKER

E 3.81 EL 0.00

HIGH ACCURACY REFERENCE

QUARTER, SIXTEENTH,

	Sheet Revisions		18	Sheet Revisions	V = 0-186	Sheet Revisions			
Date	Description	Initials	Date	Description	Initials	Date	Description	Initials	
mm/dd/yy	XXXXXXX	XXX						-0.000	
			-						
			HOCHELL !		- 12 T - 1	-		E-y H	
								***	
(4)12	THE STREET STREET	- 7 Taylor 20			1 Table 10	100000000000000000000000000000000000000		8 9	

8181 East Tufts Avenue Denver, CO 80237-2579 (303) 740-2600 Fax (303) 694-3946

### Project Control Diagram Title Sheet

Project Number: NHPP 5502-077

Project Location: U.S. 550 Rockfall Mitigation N of Ridgeway

# DEPARTMENT OF TRANSPORTATION STATE OF COLORADO

#### SHEET NO. INDEX OF SHEETS (1) Title Sheet 3.01

(1) Coordinate Tables 3.02 3.03-3.04 (2) Plan Sheet

(4) Total Sheets

## PROJECT CONTROL DIAGRAM

U.S. Highway 550 MP 106.2 to 106.6 Section(s) 4, 9, 16, 21 & 22 Township 45 North, Range 8 West of the New Mexico Principal Meridian County of Duray

End Project Control

M.P. 107.30

Note: For a complete listing of symbololy used within this set of plans, please refer to the M-100-1 Standard Symbols of the Colorado Department of Transportation M&S Standards Publication dated July 2006. Existing features are shown as screened weight (gray scale). Proposed or new features are shown as full weight without screening.



Typical Control Monument Cap Not to Scale


County Rd 24 Begin Project Control M.P. 105.50

Control


CM-MP - Control Point Monuments set by CDDT. They are CDDT Type 2 monuments, a  $3\frac{1}{4}$ " dia. aluminum control monument cap (as shown) on a  $3' \times \frac{3}{4}''$  dia. aluminum security rod on a  $3' \times \frac{3}{4}''$  dia. smooth aluminum rod.

#### General Notes:

- 1. This Project Control Diagram is not a boundary survey of the adjoining property and is prepared for the Colorado Department of Transportation purposes only.
- 2. This plan set is subject to change and may not be the most current set. It is the user's responsibility to verify with CDDT that this set is the most current. The information contained on the attached drawing is not valid unless this copy bears an original signature of the Professional Land Surveyor hereon named.
- 3. Refer to the M-629-1 Survey Monuments of the Standard Plans dated July, 2006 found in The Colorado Department of Transportation, M & S Standards for typical survey monument descriptions.

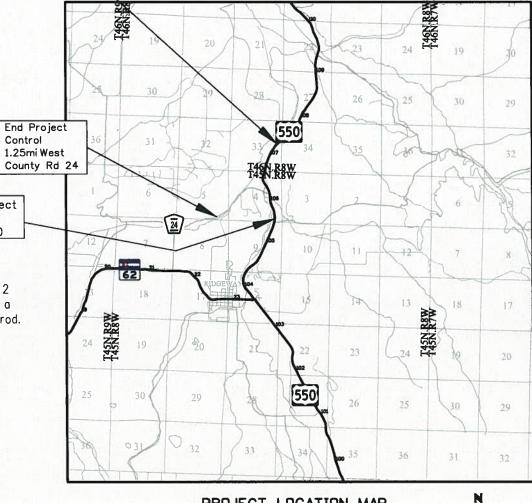

## PROJECT LOCATION MAP

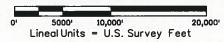

COORDINATE INFORMATION

Geodetic coordinates NAD 83 were derived from GPS observations tied to NGS Passive stations T 426 (monumented with a stainless steel deep rod in an aluminum access cover stamped "T 426 1984"), A 430 (monumented with a 3.25" Brass Cap set in Rock Dutcrop stamped "Vert. Contr. Mark A 430 1984"). State Plane Coordinates are Colorado South Zone (NAD83).

Project Coordinates are modified State Plane Coordinates in US Survey Feet. To convert Project coordinates to State Plane Coordinates, convert Project Coordinates to meters, add the "Northing reduction" and "Éasting Reduction". Then divide by the "Ground Scale Factor". Then rotate the coordinates Clockwise 1° 25'36.22928" around the 0,0 origin.

### PROJECT COORDINATE SUMMARY

Project Latitude: 38° 0'45.77263"N Project Longitude: 107° 44'35.65566"W Project Ellipsoid Height: 2109.621m Project Elevation: 6973.470'

Coordinate System: US State Plane (modified at ground)

Coordinate Zone: Colorado South 0503 Coordinate Datum: NAD83 (2007) Ground Scale Factor: 1.0003668462 Clockwise Rotation 1° 25'36.22928" Northing Reduction: 485624.8284m Easting Reduction: 681597.6095m

Basis of Bearings: Bearings used in the calculations of coordinates are based on a grid bearing of N16° 01'33"E from CM 300 to CM 400. Both monuments are CDDT Type II. The survey data was obtained from Global Positioning System (GPS) survey base on the NGS Passive Stations.

Basis of Elevations: Project elevations are based on Control Monument 400. A Typical CDOT Type II monument. Published elevation obtained from CDOT project BRF 550-2(20) With a NAVD 88 elevation of 6973.470ft

NOTICE: According to Colorado law you must commence any legal action based upon any defect in this survey within three years after you first discover such defect. In no event may any action based upon any defect in this survey be commenced more than ten years from the date of the certification shown hereon.

#### SURVEYOR STATEMENT (PROJECT CONTROL DIAGRAM)

I, Stan Vermilyea, a professional land surveyor licensed in the State of Colorado, do hereby state to the Colorado Department of Transportation this Project Control Diagram was prepared and the field survey it represents was performed under my responsible charge and, based upon my knowledge, information and belief is in accordance with applicable standards of practice defined by Colorado Department of Transportation publications. This statement is not a guaranty or warranty, either expressed or implied.



PLS No. 25381



Region 5

3803 North Main Avenue Suite 300 Durango, CO 81301 Phone: 970-385-1419 FAX: 970-385-1410

,	Sheet Revisions	8 10 10		Sheet Revisions	A NAME OF		Sheet Revisions	To ke
Date	Description	Initials	Date	Description	Initials	Date	Description	Initials
mm/dd/yy	XXXXXXX	XXX						
- 1								
					The second second			

8181 East Tufts Avenue Denver, CD 80237-2579 (303) 740-2600 Fax (303) 694-3946

Coordinate Tables Project Number: NHPP 5502-077 Project Location: U.S. 550 Rockfall Mitigation N of Ridgeway

Project Control Diagram

Project Code:	Last Mod. Date	Subset	Sheet No.	
19860	02-12-14	3.02 of 3.04	3.02	



		A H Zi L L L L L L L L L L L L L L L L L L		CHARN GEODETIC COORDINATE SUMMARY TABLE							
P	Point No.	Geodetic Coordinates NAD-83(2007) (CHARN)		Elip Height	Ortho Height	Mapping Angle	Grid Scale Factor	NAD 83(200	7) Zone 5 <del>0</del> 3	Description	
		Latitude(N)	Longitude (W)	(NAVD88) (m)	(m)		2.12.1.1 m = 2.2.5m in	SP Northing(m)	SP Easting(m)		
	618	38°06'20.36088"	-107°43'02.06341"	2178.801	2194.498	-1°21'36.02"	0.999615554	466814.74	719962.64	FOUND 3.5" BRASS NGS CAP IN ROCK OUT CROP STAMPED A430 1984	
	629	38°16'35.89212"	-107°45'56.85281"	1977.364	1993.305	-1°23'23.23"	0.999665633	485889.57	716165.98	FOUND NGS STEEL DEEP ROD WITH ACCESS COVER T426 1984	







					GEODETIC	COORDINATE TA	BLE		
Dadat Na	Geodetic Coordinates	NAD-83 (2007) (CHARN)	Elip Height	Ortho Height	M	Grid Scale Factor	NAD 83 (200	7) Zone 5 <del>9</del> 3	Description of the second of t
Point No.	Latitude(N)	Longitude (W)	(NAVD88) (m)	(m)	mapping Angle		SP Northing(m)	SP Easting(m)	Description
300	38°10'31.55176"	-107°44'30.49855"	2117.959	2133.852	-1°22'30.27"	0.999631572	474608.611	717994.662	FOUND 3.25" ALUMN. CAP CDOT TYPE II STAMPED 300
400	38°10'45.77263"	-107°44'35.65566"	2109.621	2125.518	-1°22'33.43"	0.999633289	475049.958	717879.708	FOUND 3.25" ALUMN. CAP CDOT TYPE II STAMPED 400
800	38°10'34.69174"	-107°45'40.85650"	2117.962	2133.922	-1°23'13.42"	0.999631662	474746.668	716285.076	SET CDOT TYPE II MONUMENT WITH 3.25" ALUMN. CAP STAMPED 800
895	38°11'47.14914"	-107°44'31.25145"	2084.626	2100.515	-1°22'30.73"	0.999639033	476939.215	718032.281	FOUND NGS STEEL DEEP ROD WITH ACCESS COVER B 417 RESET 1990
1063	38°11'06.15451"	-107°44'46.00317"	2099.627	2115.532	-1°22'39.78"	0.999635452	475684.245	717643.058	SET CDOT TYPE II MONUMENT WITH 3.25" ALUMN. CAP STAMPED 1063
1068	38°11'31.64606"	-107°44'41.82752"	2091.043	2106.944	-1°22'37.22"	0.999637558	476467.538	717763.533	SET CDOT TYPE II MONUMENT WITH 3.25" ALUMN. CAP STAMPED 1068
10645	38°11'13.18259"	-107°44'47.57184"	2096.229	2112.136	-1°22'40.74"	0.999636192	475901.792	717610.106	SET CDOT TYPE II MONUMENT WITH 3.25" ALUMN. CAP STAMPED 10645



	The service of the se	PROJE	CT COORDIN	IATE TABLE
Doint No.	Project Co	pordinates	Elev(ft)	
Point No.	Northing(ft)	Easting(ft)	(NAVD88)	Description
300	22619.042	80762.185	7000.81	FOUND 3.25" ALUMN. CAP CDOT TYPE II STAMPED 300
400	24057.716	80348.953	6973.47	FOUND 3.25" ALUMN. CAP CDOT TYPE II STAMPED 400
800	22932.306	75141.719	7001.04	SET CDOT TYPE II MONUMENT WITH 3.25" ALUMN. CAP STAMPED 800
895	30268.873	80695.162	6891.44	FOUND NGS STEEL DEEP ROD WITH ACCESS COVER B 417 RESET 1990
1063	26119.486	79520.667	6940.71	SET CDOT TYPE II MONUMENT WITH 3.25" ALUMN. CAP STAMPED 1063
1068	28699.330	79851.939	6912.53	SET CDOT TYPE II MONUMENT WITH 3.25" ALUMN. CAP STAMPED 1068
10645	26830.569	79394.773	6929.57	SET CDOT TYPE II MONUMENT WITH 3.25" ALUMN. CAP STAMPED 10645



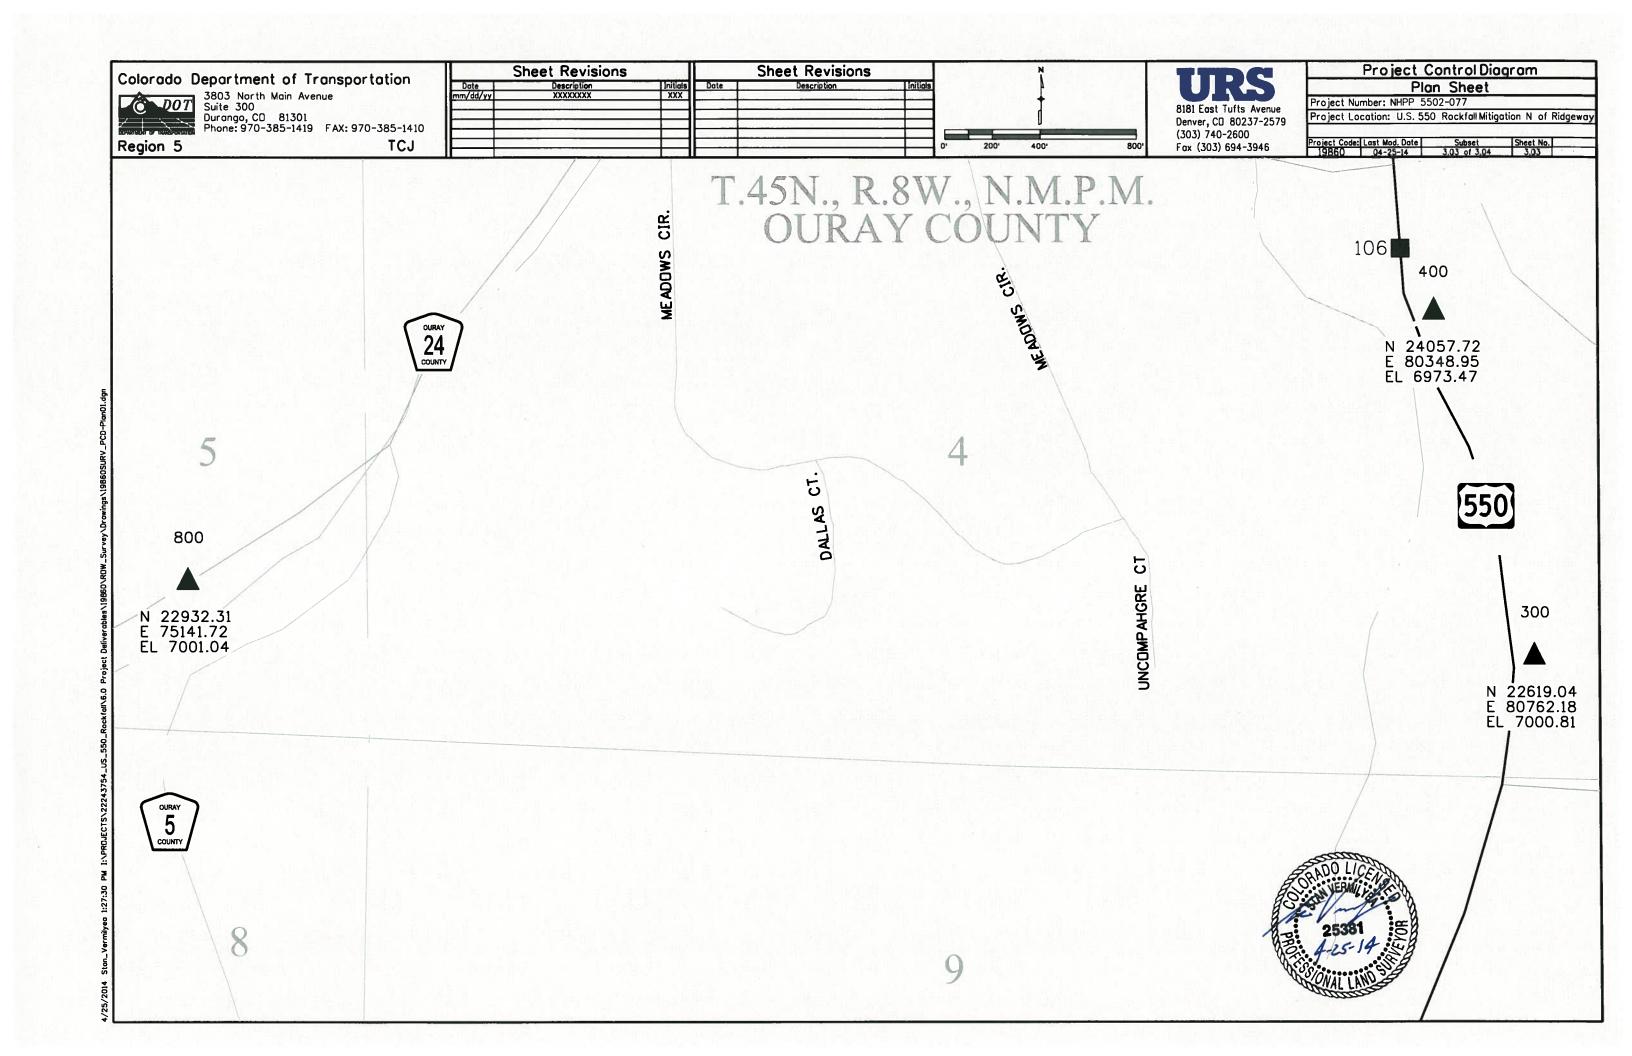

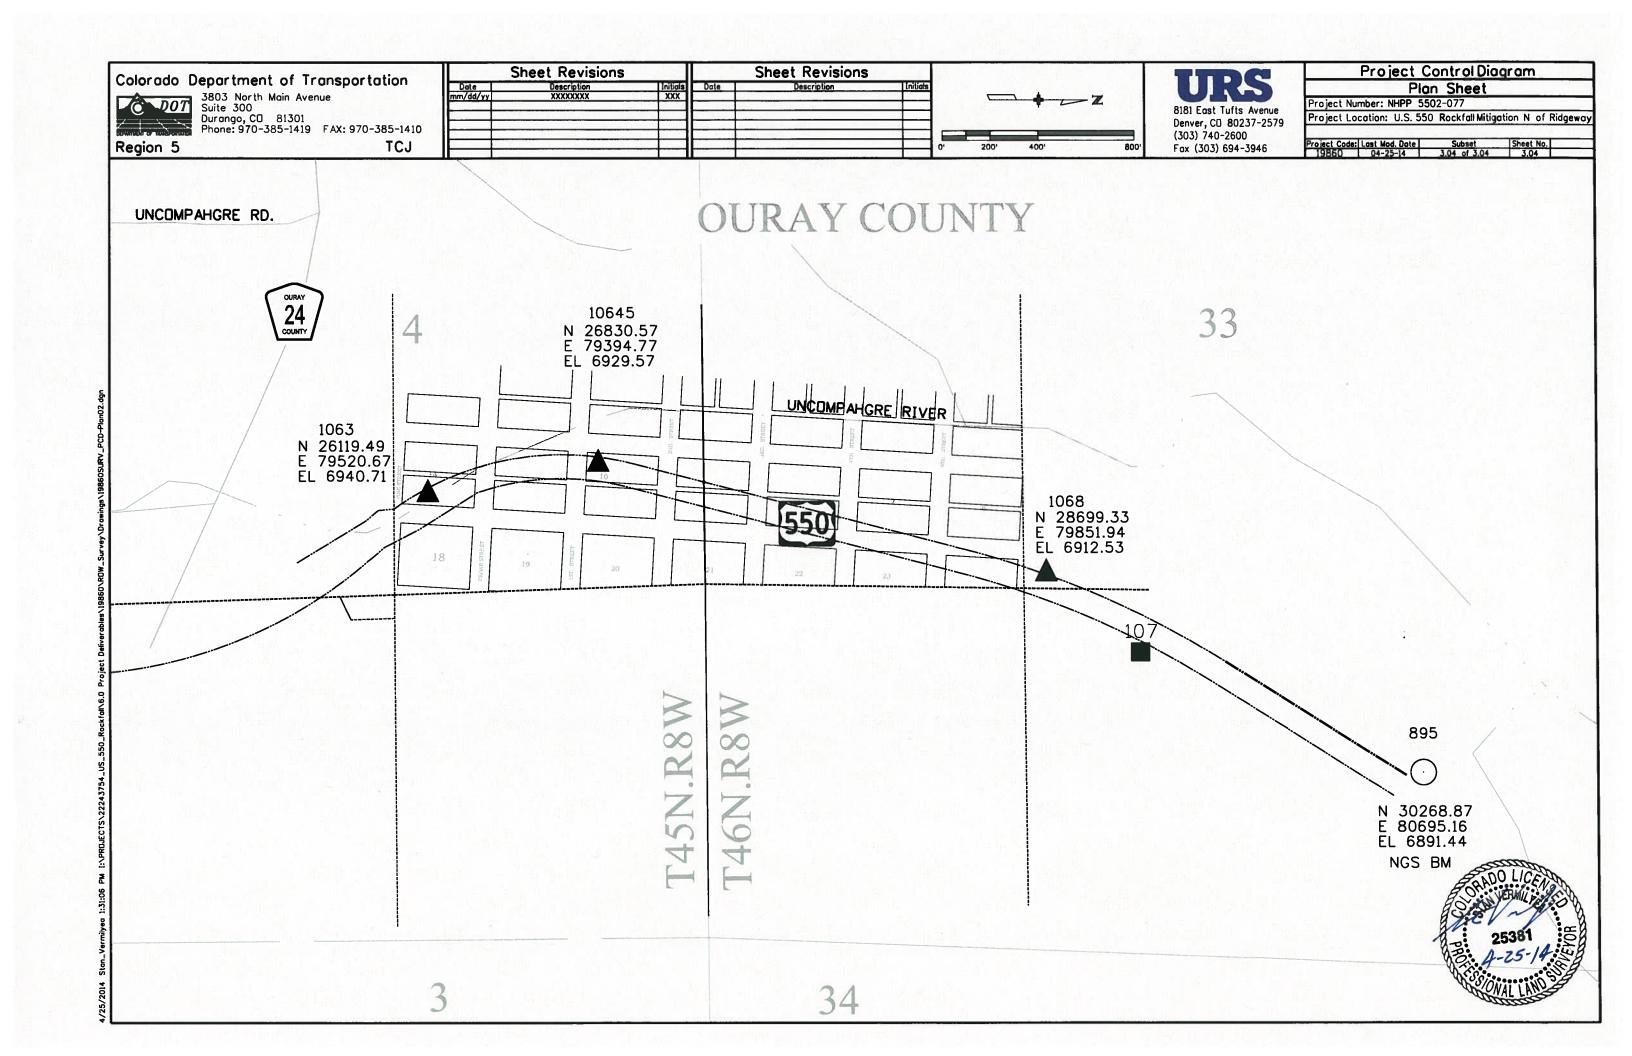



Region 5

3803 North Main Avenue Suite 300

1

SECTION CORNER

PP

PROPERTY PIN

1

TEMPORARY

EASEMENT POINT

WC

SECONDARY CONTROL

MONUMENT

WITNESS CORNER

N 10.13

E 3.81 EL 0.00

DENSIFICATION

CONTROL MONUMENT

Transportation M&S Standards Publication dated July 2006.

of record, were not included in this control survey.

PWA 2003B(3) were also recovered.

O NOAA

NOAA MARKER

Note: For a complete listing of symbololgy used within this set of plans, please

This Land Survey Control Diagram is not a boundary survey of the adjoining property

and is prepared for the Colorado Department of Transportation purposes only. No

determination has been made to determine if the found monuments as shown are in

their proper position or if they are at the corners they are intended to monument.

Easements, rights, and restrictions of record were not researched and are not shown on this diagram. The verification of the physical evidence with relation to easements,

The existing Colorado Department of Transportation Right of Way for this project was determined independently by found original FAP style monuments (reinforced concrete monument with bronze cap) as set on Project PWA 2003B(3) in 1937.

Three CDOT Type 1 Right of Way monuments (Pnts 309, 423 and WC 313) which

were set on Project BRF 50-2(20) to deliniate the ROW established on project

This retracement primarily concerns the existing Right of Way as acquired on PWA 2003B(3). Therefore, all of the found monuments have projected distances

and offsets related to the re-established alignment for PWA 2003B(3).

rights of ways, property boundaries, and restrictions, as described in the instruments

refer to the M-100-1 Standard Symbols of the Colorado Department of

BENCH MARK

(1)

SET EASEMENT

MONUMENT

O FED

FEDERAL MONUMENT

LOCAL OR PLSS

MONUMENT

PROJECT CONTROL

General Notes:

BLM MARKER

Durango, CO 81301 Phone: 970-385-1400

FAX: 970-385-1410 TCJ

RIGHT OF WAY

MARKER

OLIARTER SIXTEENTH

ID SECTION CORNERS

O USGS

ROW

RIGHT OF WAY

**●** N 10 38

EL 0.00

HIGH ACCURACY REFERENCE

NETWORK CONTROL MONUMENT

USGS MARKER

1

QUARTER, SIXTEENTH,

	Sheet Revisions			Sheet Revisions	
Date	Description	Initials	Date	Description	Initials
mm/dd/yy	XXXXXXXX	XXX	mm/dd/yy	XXXXXXXX	XXX
, and the second					
	·			·	



Land Survey Control Diagram					
	Title Sheet				
Project Number: NHPP 5502-077					
Project Location: US 550 Rockfall Mitigation					
North of Ridgway					
Project Code: Last Mod. Date Subset Sheet No.					
19860	04-28-14	4.01 of 4.03	4.01		

**INDEX OF SHEETS** 

Coordinate Tables

(1) Title Sheet

(1) Plan Sheet

(3) Total Sheets

## **DEPARTMENT OF TRANSPORTATION** STATE OF COLORADO

LAND SURVEY CONTROL DIAGRAM

U.S. Highway 550 MP 106.11 to MP 106.84 of the New Mexico Principal Meridian County of Ouray

#### General Notes Continued:

- The P.I. Stations for PWA 2003B(3) and the distance between them was held to record. The degree of curves were also held but the curve deflections and tangent distances were allowed to change to best fit the existing roadway.
- Refer to the M-629-1 Survey Monuments of the Standard Plans dated July, 2006 found in The Colorado Department of Transportation, M & S Standards for typical
- The information contained on the attached drawings is not valid unless this copy

Section 4, Township 45 North, Range 8 West

- 5. CDOT's existing ROW has been monumented at all required points as per CRS 38-51-04 and 38-53-105.
- survey monument descriptions.
- bears an original signature of the Professional Land Surveyor hereon named.

#### COORDINATE INFORMATION

Geodetic coordinates NAD 83 were derived from GPS observations tied to NGS Passive stations T 426 (monumented with a stainless steel rod in an aluminum access cover stamped "T 426 1984") and A 430 (monumented with a 3.25" Brass Cap set in Rock Outcrop stamped "Vertical Control Mark A 430 1984"). State Plane Coordinates are Colorado South Zone (NAD 83).

SHEET NO.

4.01

4.02

4.03

Project Coordinates are modified State Plane Coordinates in U.S. Survey Feet. To convert the Project Coordinates to State Plane Coordinates; Convert the Project Coordinates to meters, add the "Northing Reduction" and "Easting Reduction". Then divide by the "Ground Scale Factor". Then rotate the coordinates Clockwise 1°25'36.22928" around the 0,0 origin.

#### PROJECT COORDINATE SUMMARY

Project Latitude: 38°0'45.77263"N Project Longitude: 107°44'35.65566"W Project Ellipsoid Height: 2109.621m Project Elevation: 6973.470 US Survey Feet

Coordinate System: US State Plane (modified at ground) Coordinate Zone: Colorado South 0503

Coordinate Datum: NAD 1983 (2007) Ground Scale Factor: 1.0003668462 Clockwise Rotation 01°25'36.22928" Northing Reduction: 485624.8284m Easting Reduction: 681597.6095m

Basis of Bearings: Bearings used in the calculations of coordinates are based on a grid bearing of N16°01'33"E from CM 300 to CM 400. Both monuments are CDOT Type II. The survey data was obtained from a Global Positioning System (GPS) survey based on the NGS Passive Stations.

NOTICE: According to Colorado law you must commence any legal action based upon any defect in this survey within three years after you first discover such defect. In no event may any action based upon any defect in this survey be commenced more than ten years from the date of the certification shown hereon.

#### SURVEYOR STATEMENT (LAND SURVEY CONTROL DIAGRAM)

I, Randy N. Crumbaugh, a professional land surveyor licensed in the State of Colorado, do hereby state to the Colorado Department of Transportation this Land Survey was prepared and the field survey it represents was performed under my responsible charge and, based upon my knowledge, information and belief is in accordance with applicable standards of practice defined by Colorado Department of Transportation publications. This statement is not a guaranty or warranty, either expressed or implied.

PLS No. 25938

3803 North Main Avenue Suite 300 Durango, CD 81301 Phone: 970–385–1400 FAX: 970–385–1410 Region 5

Sheet Revisions				Sheet Revisions	
Date	Description	Initials	Date	Description	Initials
MM-DD-YY	XXXXXXXX	XXX	MM-DD-YY	XXXXXXX	XXX



Land	Surve	y Control Dia	gram
Monume	entatio	n Coordinate	Tables
Project Number	: NHPP 5	502-077	

 Project Location: US 550 Rockfall Mitigation N. of Ridgway

 M.P. 106.11 to M.P. 106.66

 Project Code: Last Mod. Date
 Subset
 Sheet No.

 19860
 04-25-14
 4.02 of 4.03
 4.02


	FOI	JND ALIQUOT N	MONUMENT COORDINATE TABLE (Controlling)
Point No.	Northing (Ft)	Easting (Ft)	Description
506	28605.91	79916.22	3.25" Alum. Cap - Mrk'd US Dept. of Int. 1987 Cor. 27 Res. Bnd SE 1/16 S33
507	25979.42	79942.99	3" Brass Cap Marked: Bureau of Land Management NE1/16 SEC 4, 1992
510	24669.73	79987.00	2.5" Alum Cap Marked :MESA SURV CE1/16 SEC 4, LS 12180
512	27276.39	79898.03	3.25" Alum. Cap - Mrk'd Bureau of Land Management E/16 Sec 33/4 1992

O PP

	FOUND BOUNDARY MONUMENT COORDINATE TABLE (Controlling)				
Point No.	Northing (Ft.)	Easting (Ft.)	Description		
502	25978.49	79724.47	1.5" Alum. Cap on #5 Rebar - Del-Mont LS 16840		
307	28605.21	79815.40	3.25" Alum. Cap on PVC pipe - US Dept of Int. 1992 Bur. Rec. Res. Bndy Cor 26 / S33		
308	27272.76	79472.77	3.25" Alum. Cap on PVC pipe - US Dept of Int. 1992 Bur. Rec. Res. Bndy S33 / S4		
505	25974.94	78772.04	3.25" Brass Cap - US Dept of Int Bur. Rec. ( no other information )		
511	25974.73	78687.86	3.5" Alum. Cap - US Dept of Int Bur. Rec Res Bndy Cor 22 - S4 1992		

⊡ ROW

	FOUND R.O.W. MONUMENT COORDINATE TABLE (Controlling)				
Point	Northing (Ft.)	Easting (Ft.)	Description		
200	26326.33	79516.55	Original Concrete ROW Marker set on PWA 2003B(3) - Leaning NW'erly		
201	25937.97	79745.65	Original Concrete ROW Marker set on PWA 2003B(3) - solid vertical position		
205	27301.64	79583.56	Original Concrete ROW Marker set on PWA 2003B(3) - solid vertical position		
WC313	26063.00	79680.79	CDOT Type 1 ROW Marker marked WC313 - 24.3' LS 12180		
309	25852.33	79817.55	CDOT Type 1 ROW Marker marked 309 LS 12180		
243	25977.89	79585.48	CDOT Type 1 ROW Marker marked 243 - LS 12180		

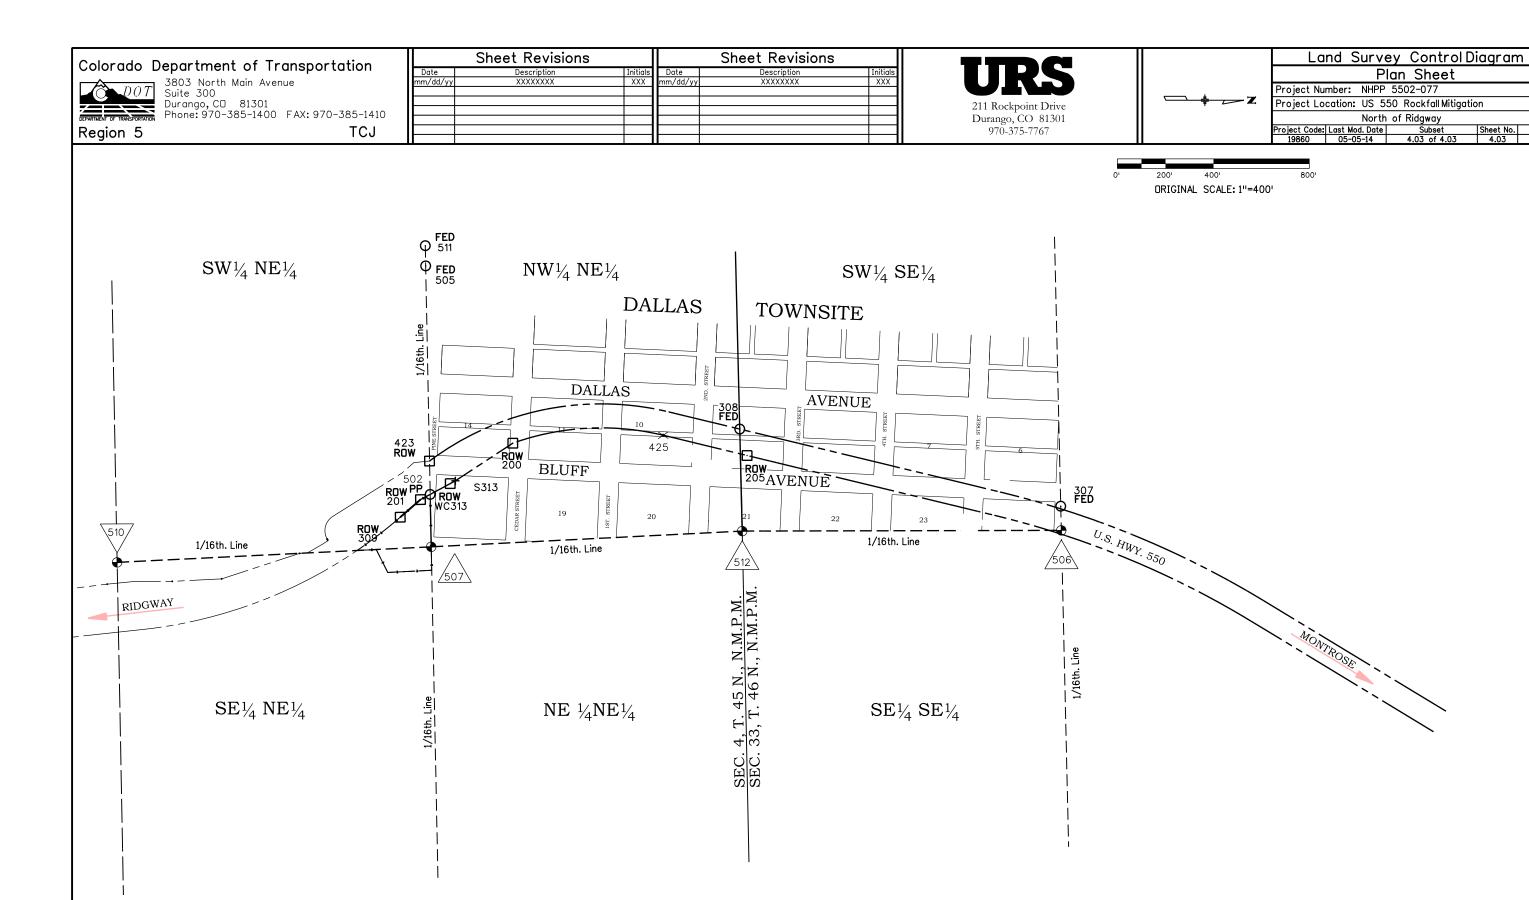

T. 45 N., R. 8 W., N.M.P.M.

T. 46 N., R. 8 W., N.M.P.M.



Region 5

3803 North Main Avenue Suite 300 Durango, CD 81301 Phone: 970-385-1400 FAX: 970-385-1410

QUANTITY OF MONUMENTS TO BE SET

17

 MONUMENT TYPE

 1
 1A
 2
 2A
 3
 3A
 4
 5
 5(S)
 6

TCJ

	Sheet Revisions			Sheet Revisions	·
Date	Description	Initials	Date	Description	Initials
nm/dd/yy	XXXXXXXX	XXX	mm/dd/yy	XXXXXXXX	XXX
	_				
	_				



Right of Way Plans
Monumentation Sheet
Project Number: NHPP 5502-077
Project Location: US 550 Rockfall Mitigation N. of Ridgway
M.P. 106.11 to M.P. 106.84

Project Code: Last Mod. Date



TABULATION OF R.O.W. MARKERS (TO BE SET)						
Point No.	Northing	Easting	Description			
425	26953.34	79493.48	Parcel Corner ( Not to be Set)			
426	26978.38	79396.66	CDOT Type 1 Aluminum Cap Stamped 25938 on 36" Finned Rod			
427	28354.14	79752.48	CDOT Type 1 Aluminum Cap Stamped 25938 on 36" Finned Rod			
428	28329.10	79849.30	CDOT Type 1 Aluminum Cap Stamped 25938 on 36" Finned Rod			
429	27449.11	79518.41	CDOT Type 1 Aluminum Cap Stamped 25938 on 36" Finned Rod			
430	29390.31	80306.71	CDOT Type 1 Aluminum Cap Stamped 25938 on 36" Finned Rod			
431	29443.50	80222.03	CDOT Type 1 Aluminum Cap Stamped 25938 on 36" Finned Rod			
432	27273.64	79576.32	CDOT Type 1 Aluminum Cap Stamped 25938 on 36" Finned Rod			
433	25978.73	79759.57	CDOT Type 1 Aluminum Cap Stamped 25938 on 36" Finned Rod			
434	25978.80	79779.70	CDOT Type 1 Aluminum Cap Stamped 25938 on 36" Finned Rod			
435	25867.60	79804.74	CDOT Type 1 Aluminum Cap Stamped 25938 on 36" Finned Rod			
436	25978.58	79724.58	Parcel Corner ( Not to be Set)			
437	26157.04	79783.39	CDOT Type 1 Aluminum Cap Stamped 25938 on 36" Finned Rod			
438	26476.46	79668.49	CDOT Type 1 Aluminum Cap Stamped 25938 on 36" Finned Rod			
439	26780.00	79682.31	CDOT Type 1 Aluminum Cap Stamped 25938 on 36" Finned Rod			
440	26984.79	79790.82	CDOT Type 1 Aluminum Cap Stamped 25938 on 36" Finned Rod			
441	27099.75	79674.47	CDOT Type 1 Aluminum Cap Stamped 25938 on 36" Finned Rod			
442	27094.76	79557.72	CDOT Type 1 Aluminum Cap Stamped 25938 on 36" Finned Rod			
443	27101.47	79531.79	CDOT Type 1 Aluminum Cap Stamped 25938 on 36" Finned Rod			

#### General Notes:

- 1. All centerline and offset stationing may not represent the centerline as constructed in the field.
- 2. Right of Way Markers set on this project by URS are CDOT Type 1 monuments, a 3.25" Aluminum Cap set on .75"x36" Aluminum Finned Rod, except as noted above.
- 3. This plan set is subject to change and may not be the most current set. It is the user's responsibility to verify with CDOT that this set is the most current. The information contained on the attached drawing is not valid unless this copy bears an original signature of the Professional Land Surveyor hereon named.

#### COORDINATE INFORMATION

Geodetic coordinates NAD 83 were derived from GPS observations tied to NGS Passive stations T 426 (monumented with a stainless steel rod in an aluminum access cover stamped "T 426 1984") and A 430 (monumented with a 3.25" Brass Cap set in Rock Dutcrop stamped "Vertical Control Mark A 430 1984"). State Plane Coordinates are Colorado South Zone (NAD 83).

Project Coordinates are modified State Plane Coordinates in U.S. Survey Feet.

To convert the Project Coordinates to State Plane Coordinates; Convert the Project
Coordinates to meters, add the "Northing Reduction" and "Easting Reduction". Then divide
by the "Ground Scale Factor". Then rotate the coordinates Clockwise 1° 25'36.22928"
around the 0,0 origin.


NOTICE: According to Colorado law you must commence any legal action based upon any defect in this survey within three years after you first discover such defect. In no event may any action based upon any defect in this survey be commenced more than ten years from the date of the certification shown hereon.


#### SURVEYOR STATEMENT (R.O.W. MONUMENTS)


I, Randy N. Crumbaugh, a professional land surveyor licensed in the State of Colorado, do hereby state to the Colorado Department of Transportation that based upon my knowledge, information and belief, adequate research, calculations and evaluation of survey evidence were performed and the Right-of-Way monuments depicted on this Right-of-Way Plan were set under my responsible charge in accordance with applicable standards of practice defined by Colorado Department of Transportation publications. This statement is not a guaranty or warranty, either expressed or implied.

PLS No. 25938

QUANTII  CAP TYPE  REFERENCE  ROW  CONTROL  ALIQUOT CORNER  PERMANENT EASEMENT  PROJECT POINTS  WITNESS POST (REQUIRED)	in ibadgi vesktop visooo ivocki dii vec	
WITNESS POST	y - C	QUANTIT
WITNESS POST	21010	CAP TYPE
WITNESS POST		REFERENCE
WITNESS POST	M	ROW
WITNESS POST	.0.50.	CONTROL
WITNESS POST	o lifini	ALIQUOT CORNER
WITNESS POST	0 10	PERMANENT EASEMENT
WITNESS POST	,- (nin	PROJECT POINTS
WITNESS POST (REQUIRED)		
	07 /0 /0	

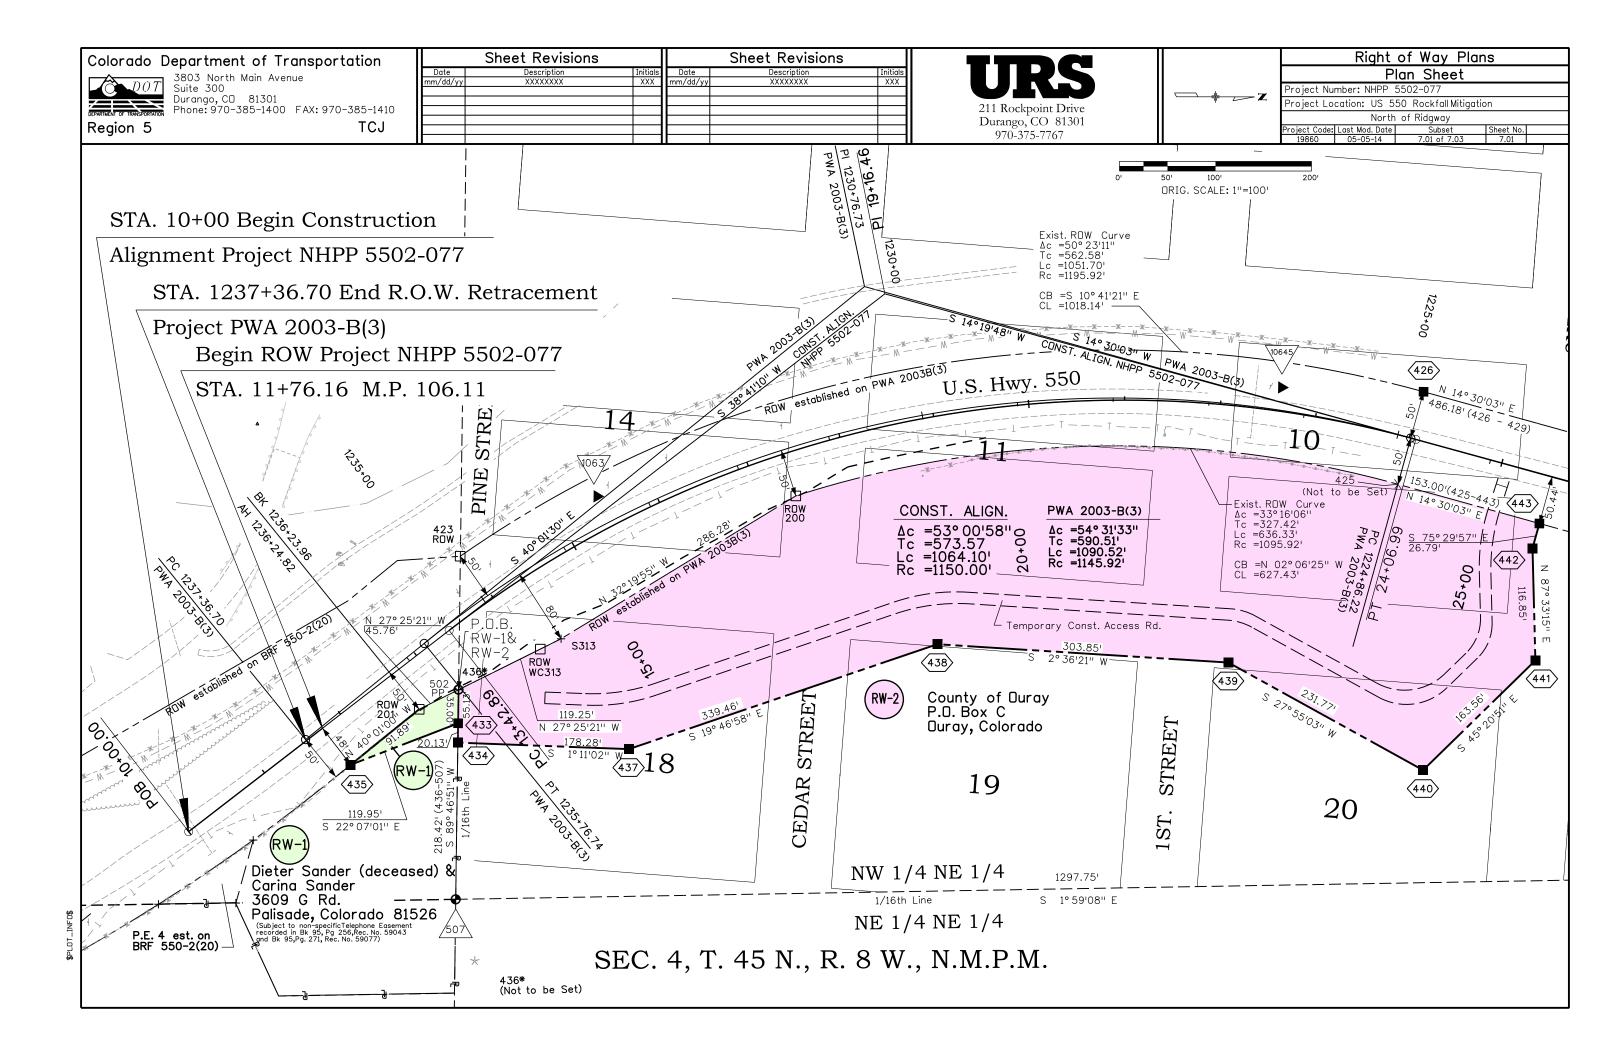

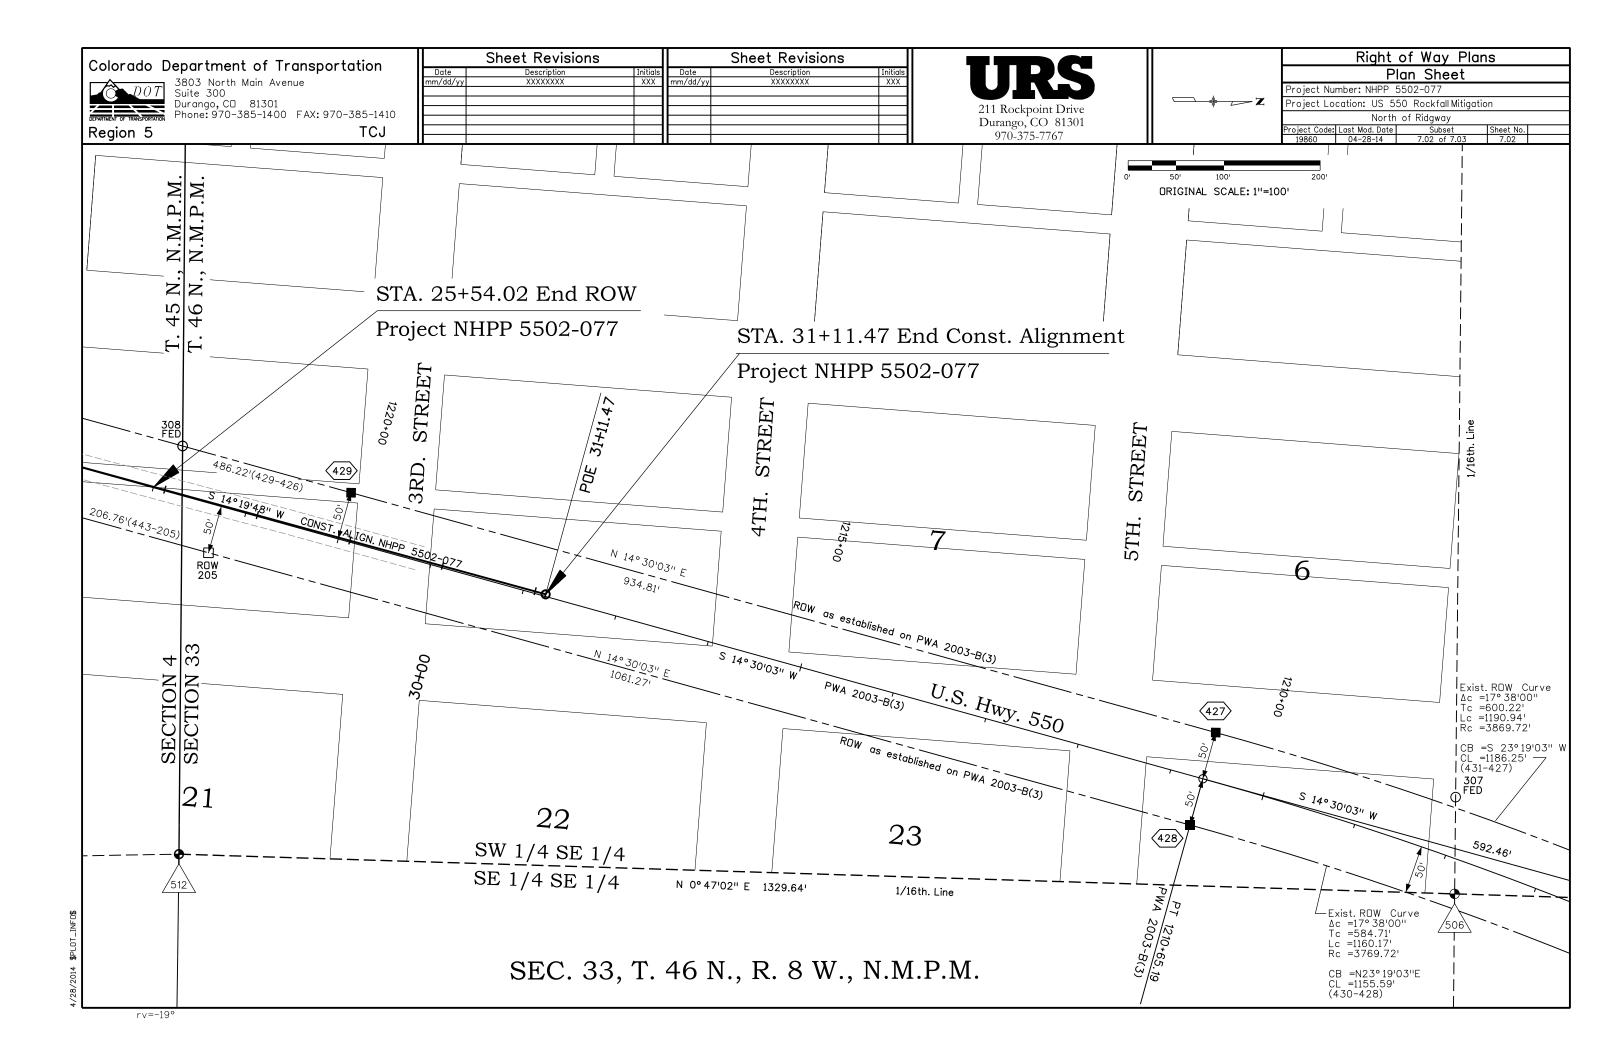

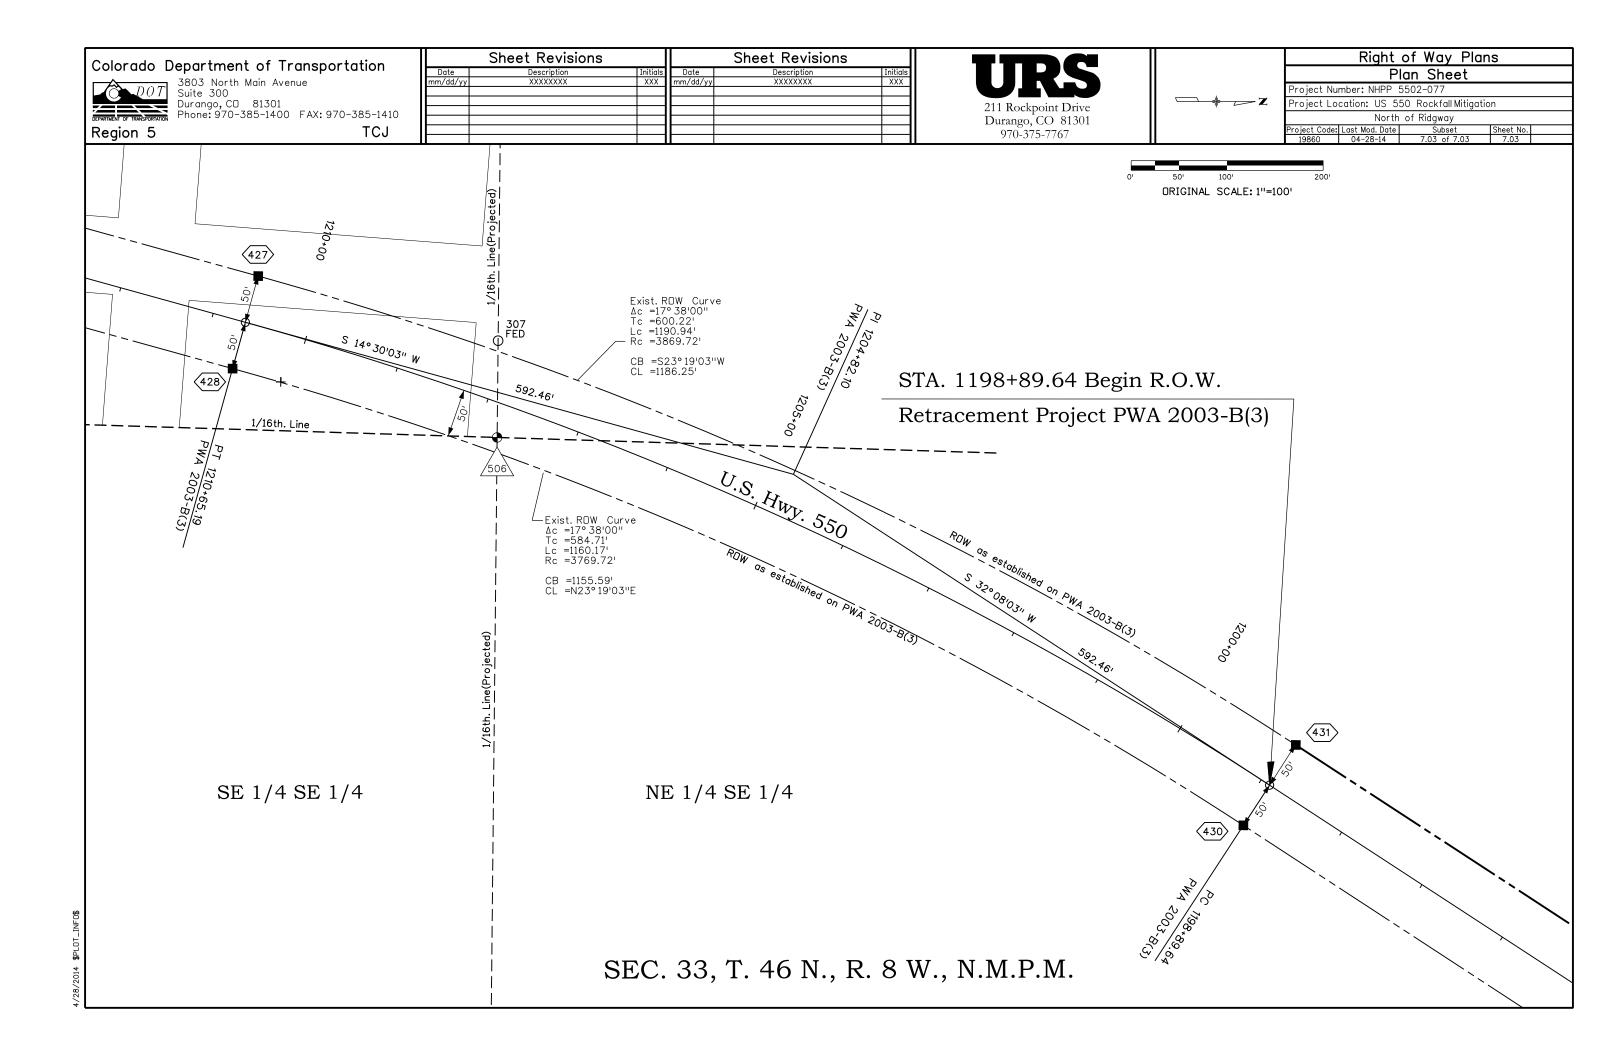

Right of Way Plans Sheet Revisions Sheet Revisions **URS** Colorado Department of Transportation Ownership Sheet Initials XXX 3803 North Main Avenue Suite 300 Durango, CO 81301 Phone: 970-385-1400 FAX: 970-385-1410 Project Number: NHPP 5502-077 Project Location: US 550 Rockfall Mitigation 211 Rockpoint Drive Durango, CO 81301 970-375-7767 North of Ridgway TCJ Region 5 ORIGINAL SCALE: 1"=400" SW1/4 SE1/4 NW1/4 NE1/4 SW1/4 NE 1/4 B.O.R. STATE PARK B.O.R. STATE PARK (Ouray Co. G.I.S.) DALLAS (Ouray Co. G.I.S.) TOWNSITE DALLAS **AVENUE** BLUFF AVENVE/ 1/16th. Line 1/16th. Line 1/16th. Line 2 COUNTY of OURAY RIDGWAY P.O. BOX C Ouray, CO. 81427 1 DIETER SANDER (deceased) & THOMAS, JANE CARINA SANDER (Ouray Co. G.I.S.) 3609 G Rd. Palisade, CO 81526 SE1/4 NE1/4  $\frac{NE}{4}NE\frac{1}{4}$ BUREAU OF LAND MANAGEMENT SE1/4 SE1/4 (Ouray Co. G.I.S.)

T. 45 N., R. 8 W., N.M.P.M.

T. 46 N., R. 8 W., N.M.P.M.