Sheet Revision	ons Sheet Revisions Sheet Revi	sions	Right of Way Plans
Colorado Department of Transportation	Initials   Date   Description   Initials   Date   Description   Descri	n Initials	Title Sheet
### 4-16-09 Remove Wilson Logo(all 4-16-09 Revised Sheets 2.01, 4.01, 5.0	01, 5.02, 6.01 AC		er: NH 2854-108
DOT 18500 East Colfax Avenue Aurora, CD 80011 Phone: 303-365-7410 FAX: 303-365-7350		Project Numbe	er: ion: US 285 at Shaffer's Crossing
Region 1 KAW		Project Code: Last	st Mod. Date Subset Sheets Sheet No.
Tregion 1		15048 0	04-16-09 1 of 1 1.01
DEPA	RTMENT OF TRANSPORTA STATE OF COLORADO RIGHT OF WAY PLAN OF PROPOSED	TION  SHEET NO.  1.01	INDEX OF SHEETS  (1) Title Sheet
	FEDERAL AID PROJECT NO. NH 2854-108	2.01	(1) Tabulation of Properties
		3.01-3.03	(3) Control Diagram
	STATE HIGHWAY NO. 285	4.01-4.03 5.01-5.02	<ul><li>(3) Monumentation Sheets</li><li>(2) Plan Sheets</li></ul>
	JEFFERSON COUNTY	6.01	(1) Dwnership Sheet
		M-100-1	(3) Standard Symbols
	RIGHT OF WAY	M-629-1	(2) Survey Monuments (16) Total Sheets
		SCALES DE DR	IGINAL 11X17 DRAWINGS
End of Construction Project No.: NH 2854-108 Project Code: 15048 Station: 516+00.0  Beginning of Construction Project No.: NH 2854-108 Project Code: 15048 Station: 490+00.0	19 20 21 22 23 30 29 28 27 26 31 8 62 33 34 35	PLAN SH OWNERSHIF	HEETS 1''=100' P MAP 1''=200' oject = 1148.0 ft (0.22 mi)
BASIS OF BEARING  BASIS OF BEARINGS: Bearings used in the calculations of coordinates are based on a grid bearing of N 49°57'38" E from US-285 CM-MP 230.7 and US-285 CM-MP 230.9. Both monuments are CDOT Type II, marked appropriately for their milepost location and contol position. The survey data was obtained from a Global Positioning System (GPS) survey based on the Colorado High Accuracy Reference Network (CHARN).		FEDERAL HIC	T OF TRANSPORTATION GHWAY ADMINISTRATION DATE ON ADMINISTRATOR

# Colorado Department of Transportation Sheet Revisions Sheet Revisions

		Sheet Revisions	
S	Date	Description	Initials
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Right of Way Plans
Tabulation of Properties
Project Number: NH 2854-108
Project Number:
Project Location: US 285 at Shaffer's Crossing
Project Code: Last Mod. Date Subset Sheet No.

Region 1	ŀ	<aw th=""  <=""><th></th><th></th><th></th><th></th><th></th><th></th><th></th><th>Project Cod 15048</th><th>e: Last Mod. Date Subset Sheets Sheet No. 04/16/09 1 of 1 2.01</th></aw>								Project Cod 15048	e: Last Mod. Date Subset Sheets Sheet No. 04/16/09 1 of 1 2.01
					Area in Square Feet (Acres)			Book and Page	Title		
Parcel No.	Owner	Site Address	Location	Area of Parcel	Existing ROW	Net Area	Remo	ninder Right	No. and/or Reception No.	Commitment No.	Remarks
			T. 6 S., R. 71 W., 6th P.M.			1	LOTE	IXIGITE			
			Jefferson County, Colorado								
1	Elk Creek Properties, LLC	12833 Elk Creek Rd	Tract in SWl∕₄Section 32	10,521 sf		<del></del>	464 <b>,</b> 588± s	1		S0187516	
	26624 N Turkey Creek Rd	Conifer, CD 80433		(0.242 ac)		(0.242 ac	(10.665±ac)				
	Evergreen, CD 80439			<u> </u>		<del> </del>					
						<u> </u>	<u> </u>				
						1					
				<u> </u>	-	+		-			
PE-1	Same	Same	Same	3,832 sf		7.832 of	464,588± st			S0187516	For the construction and maintenance
1 L 1	Sume	Sume	Sume	(0.088 ac)			(10.665 ±ac)			00107010	of a retaining wall
				(0.000 uc)		(0.000 ac	(10.005 -uc)				The recalling wan
2	Not Used										
						†	1				
AP-3	Andrew D. Nelson	13024 S.US Hwy 285	Lots 5 & 6 Shaffer's Crossing	21,081 sf		21 <b>,</b> 081 sf		O±sf	2008046088	S0187525	
	Same as site address	Pine, CO 80470	SW <sup>1</sup> / <sub>4</sub> Section 32	(0.484 ac)	)	(0.484 ac		(0±ac)			
		,									
AP-4	Dawn M. Wazny	13014 S.US Hwy 285	Lot 4 Shaffer's Crossing	4,625 sf		4,625 sf		O±sf	2008052584	S0187526	
	PO Box 80470	Pine, CO 80470	SW <sup>1</sup> / <sub>4</sub> Section 32	(0.106 ac)		(0.106 ac		(0 ±ac)			
	Golden, CD 80402										
AP-5	Dawn M. Wazny	13004 S.US Hwy 285	Lot 3 Shaffer's Crossing	3,894 sf		3,894 sf		O±sf	2008052584	S0187523	
	PO Box 80470	Pine, CO 80470	SW <sup>1</sup> / <sub>4</sub> Section 32	(0.089 ac)		(0.089 ac		(0±ac)			
	Golden, CD 80402										
6	Joshua C. Wynne & Jamie L.	12822 S Elk Creek Rd	Tract in SWI/4Section 32	42,279 sf		+	114,537±sf	1	2009021279	S0174349	
	Wynne, Glenn Ehlers & Debbie	Pine, CD 80470		(0.971 ac)		(0.971 ac)	(2.629±ac)			<u> </u>	
	Ehlers 15102 S Elk Creek Rd					<u> </u>					
				<u> </u>		+	1				
	Pine, CD 80470					1	<u> </u>		<u> </u>		
7	John Andrew Furuli	12641 Elk Haven Ln	Tract in SW <sup>1</sup> / <sub>4</sub> Section 32	31,752 sf		31.752 sf	507,521±sf		2009014849	S0174337	
/	Same as site address	Conifer, CD 80433	11 400 111 311 / 4300 (1011 32	(0.729 ac)		-	(11.651±ac)	•	200301+0+3	3017 +337	
		55111101, 00 00 100		(11, 23 40)	<u> </u>	(11, 23, 40	(======================================	<u> </u>			
TE-8	Elk Creek Land & Cattle Co., LLC	12997 S. Elk Creek Rd.	Tract in SWI/4Section 32	834 sf		834 sf		455 <b>,</b> 739 sf			Purpose: Culvert Pipe Removal
	PD Box 416, Conifer, CD 80433	Pine, CO 80470		(0.019 ac)		(0.019 ac)		(10.46 ac)			
						<u> </u>					

# COLORADO DEPARTMENT OF TRANSPORTATION

RIGHT OF WAY PLANS UNIT: KEVIN A. WILLIAMS

Region 1
Address: 18500 E. Colfax Ave.
Aurora, CO 80011
Phone: (303) 365-7410 FAX: (303) 365-7350

Sheet Revisions						

US 285 (MP 230.5 TO MP 231.1)
Located in:

Section 32, Township 6 South, Range 71 West Section 6, Township 7 South, Range 71 West of the 6th Principal Meridian, County of Jefferson State of Colorado

Survey Control Diagram								
Title Sheet								
Project Nu	Project Number: NH 02854-088							
Project Lo	cation: US 28	5 (MP 230.	5 to MP	230.9)				
Project Location: US 285 at Shaffer's Crossing								
Project Code:	Last Mod. Date	Subset Sheets	Sheet No.					
47704	05 /05 /00	4 / -	7.01					

# SUPPLEMENTAL PROJECT CONTROL DIAGRAM

#### CONSTRUCTION SURVEYING AND MONUMENTATION REQUIREMENTS:

- 1). This Control Survey Diagram represents the horizontal and vertical control for the project established by the Division. It is possible that some of the survey control monuments listed have been disturbed or obliterated. It is the Contractor's responsibility to verify the existence and stability of the control monuments before submitting a bid price.
- 2). All Type 1 and Type 2 monuments shall be set flush with the ground. Witness posts shall be installed 1 foot from and facing all Type 1 and Type 2 monuments, or as directed by the Project Engineer.
- 3). Installation of Type 3 and Type 3—A monuments shall be completed in the same day that installation is commenced. Under no circumstances shall holes in the roadway be left open overnight.
- 4). When installing Type 3—A monuments, the aluminum access cover shall be positively secured to the PVC pipe with screws or glue. The access cover shall be caulked with asphalt caulking between the cover and the edges of the roadway surface to provide a positive moisture barrier around the access cover.
- 5). Control survey procedures, statistical analysis, and accuracy obtained for horizontal and vertical control shall be documented in the field book.
- 6). Legible copies of the field books shall be submitted to the Project Engineer for review on a monthly basis.
- 7). It is ultimately the prime Contractors responsibility to insure that these requirements, as well as any contained in the CDOT specifications, project special provisions, and CDOT Survey Manual are fulfilled under this contract.
- 8). The minimum staking intervals for each item are described on the plans or in the CDOT Survey Manual. If the contractor wishes to reduce the minimum intervals, a Contract Modification Order must be negotiated and the cost of the item reduced accordingly.



Typical Control Monument Cap Not to Scale

CM — Control Point Monuments set by CDOT. All set Control Point Monuments are CDOT type 2 monuments, a 3-1/4" dia. aluminum control monument cap (as shown) on a 3' X 3/4" dia. finned aluminum security rod on a 3' X 3/4" dia. smooth aluminum rod (unless otherwise noted).

BASIS OF BEARINGS: Bearings used in the calculation of coordinates are based on a grid bearing of N11\*39'57"E from CDOT CM—MP 226.1 to CDOT CM—MP 226.3 as obtained from a Global Positioning System (GPS) survey based on the Colorado High Accuracy Reference Network (CHARN). Said grid bearing is NAD '83 (1992) Colorado State Plane (Central Zone).

BASIS OF ELEVATIONS: Project is based on Bench Mark U 305 (NGS PID KK0739), Published NAVD Height = 7855.22'. All other Control Points on this project were established by by differential leveling from said U 305, no orthometric corrections were applied to any of the differential level lines run on this project.

COORDINATE DATUM: Coordinates on this project are for the exclusive use of the CDOT for the construction of this project and are considered Project Coordinates only.

NOTE: Section lines shown herein were digitize from USGS maps and are shown for graphical reference purposes only. True aliquot corners and lines were not surveyed or established for this phase of the project survey control.

NOTE: This control survey is for the use of the Colorado Department of Transportation personnel. The survey is not a complete Boundary Survey. Title Policy, Title Commitment, and Title Research were not part of this control survey, therefore, easements, rights, and restrictions of record are not shown. The verification of the physical evidence with relation to easements, rights of way, property boundaries, and restriction, as described in the instruments of record, were not included in this control survey.

NOTE: According to Colorado law you must commence any legal action based upon any defect in this survey within three years after you first discover such defect. In no event may any action based upon any defect in this survey be commenced more than ten years from the date of the statement shown.

SURVEYORS STATEMENT: I, Cory S. Talmage—Gray, a Professional Land Surveyor in the State of Colorado, hereby state that this Supplemental Control Survey Diagram was verified under my direct supervision from a field survey performed under my supervision and checked for and on behalf of the Department of Transportation, State of Colorado. The Project Control Diagram was originally prepared under the direct supervision of Kenneth W. Carlson, PLS 24942. This survey is not a Land Survey Plat or Right—of—Way Survey Plat and to the best of my knowledge and belief this control survey, as shown, meets the minimum horizontal control tolerances of a Type B Survey as listed in the Colorado Department of Transportation Survey Manual Chapter Three (Revised 10/24/03).

Cory S.	Talmage-Gray,	P.L.S.	37940
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COLORADO DEPARTMENT OF TRANSPORTATION

Region 1
Address: 18500 E. Colfax Ave.
Aurora, CO 80011
Phone: (303) 365-7410 FAX: (303) 365-7350

US 285 (MP 230.5 TO MP 231.1)

Located in:
Section 32, Township 6 South, Range 71 West
Section 6, Township 7 South, Range 71 West
of the 6th Principal Meridian, County of Jefferson
State of Colorado

Project Control Diagram
Tabulation of Project Control

Project Number: NH 02854-088

Project Location: US 285 (MP 230.5 to MP 230.9)

Project Location: US 285 at Shaffer's Crossing

Project Code: Last Mod. Date Subset Sheets No.

15048 05/05/08 2 of 3 3.02

# GEODETIC COORDINATE SUMMARY TABLE (ADJUSTED FIELD DATA)

						SF SF	PC	SF	PC		
POINT NAME	GEODETIC COORDINATE	S NAD-83(92) (CHARN)	ELLIP. HEIGHT	MAPPING	SCALE	NAD 83/92	ZONE 0502	NAD 83/92	ZONE 0502	ELEV.	DECODIDATION
FOINT NAME	LATITUDE	LONGITUDE	(NAVD 88)(m)		FACTOR	NORTHING (m)	EASTING (m)	NORTHING (sft)	EASTING (sft)	(NAVD 88)sft	DESCRIPTION
2305	39°28'27.27664"N	105°22'28.42556"W	2453.739	0°04'44.80328"	0.99995708	486963.700	925194.640	1597646.73	3035409.41	8095.65	CM-MP 230.5
2307	39°28'37.34279"N	105°22'21.03381"W	2431.212	0°04'49.46518"	0.99995740	487274.370	925370.870	1598666.00	3035987.59	8021.76	CM-MP 230.7
2309	39°28'44.94925"N	105°22'09.31895"W	2410.464	0°04'56.85362"	0.99995764	487509.340	925650.510	1599436.91	3036905.05	7953.72	CM-MP 230.9
2311	39°28'50.08880"N	105°21'56.71214"W	2424.850	0°05'04.80461"	0.99995780	487668.280	925951.560	1599958.35	3037892.75	8001.00	CM-MP 231.1

# PROJECT COORDINATE SUMMARY TABLE (ADJUSTED FIELD DATA)

	<i>.</i>			
POINT NAME	PROJECT COOF	RDINATES US FT	ELEV.	DECODIDATION
POINT NAME	NORTHING	EASTING	(NAVD 88)	DESCRIPTION
2305	598416.60	1036872.11	8095.65	CM-MP 230.5
2307	599436.36	1037450.57	8021.76	CM-MP 230.7
2309	600207.64	1038368.47	7953.72	CM-MP 230.9
2311	600729.33	1039356.65	8001.00	CM-MP 231.1

<u>Project Coordinate Parameters</u>

RIGHT OF WAY PLANS UNIT: KEVIN A. WILLIAMS

M 14 (NGS PID KK0737)

with the following values:

Lat. 39°24'20.51087" N

Long. 105°28'35.61402" W

Ellipsoidal Height 2346.14 m

Combined Project Factor = 0.999518353

Combined Project Factor Reciprocal = 1.000481879

Conversion Meters to USFeet:

One meter equals 3937/1200 feet.


<u>Conversion Example of State Plane Coordinates to Project Coordinates:</u>

State Plane Northing in USFT x 1.000481879 - 1,000,000.00 = Project Northing in USFT

State Plane Easting in USFT x 1.000481879 - 2,000,000.00 = Project Easting in USFT

<u>M 14</u>

 $1,572,656.34' \times 1.000481879 - 1,000,000.00' = 573,414.17'$  $3,006,623.42' \times 1.000481879 - 2,000,000.00' = 1,008,072.25'$ 

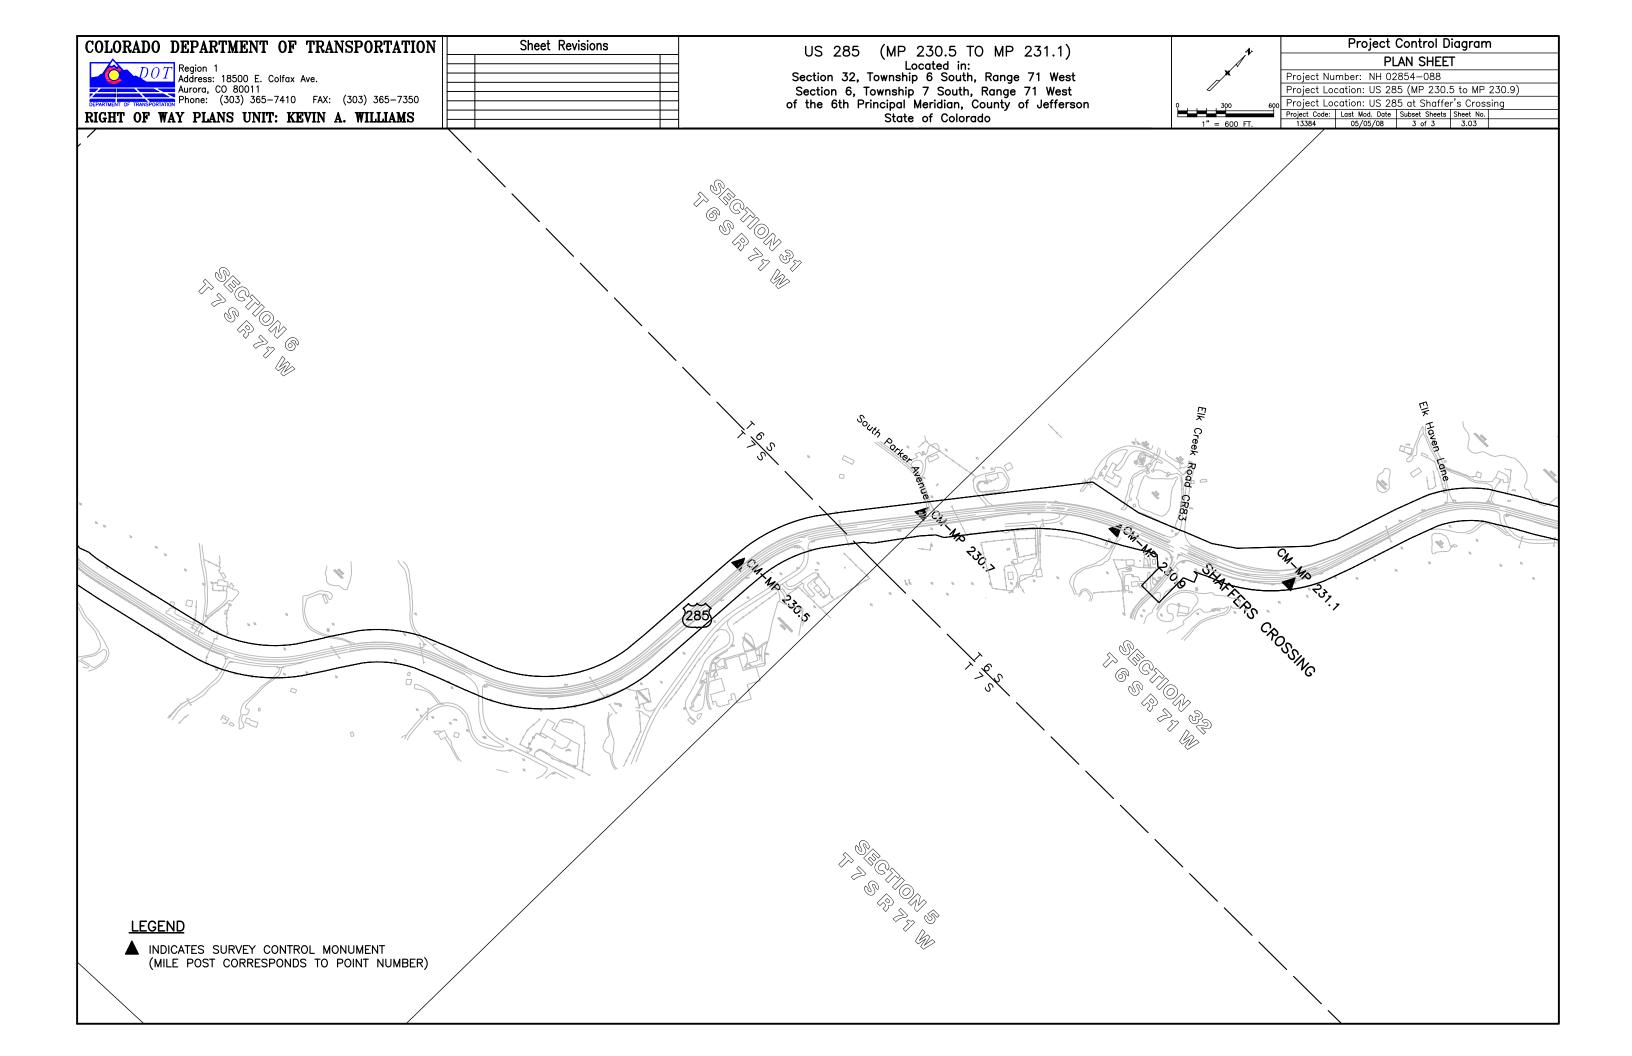

# Colorado Department of Transportation

DOT	

18500 East Colfax Avenue Aurora, CD 80011

Region 1 Phone: 303-365-7410 FAX: 303-365-7350

	Sheet Revisions		Sheet Revisions			Sheet Revisions		
c	Description	Initials	Date	Description	Initials	Date	Description	Initials
-08	Add TL=8 Points	AC	mm/yy			mm/yy		

Right of Way Plans

Monumentation Sheet

Project Number: NH 2854-108

Project Number:

Project Location: US 285 at Shaffer's Crossing

Project Code: Last Mod. Date Subset Sheets Sheet No.

# Kegion .

## TABULATION OF ALIQUOT CORNERS

$\wedge$	
<u>/xxxx</u>	

Point No.	Northing	Easting	Description
1008	599044.91	1037501.06	See Sheet RW 4.02
1055	600361.48	1038896.74	See Sheet RW 4.02
1064	600366.30	1037533.40	See Sheet RW 4.02
1065	599070.71	1040266.76	See Sheet RW 4.02
1067	600356.04	1040259.77	See Sheet RW 4.02
1068	601679.66	1038909.84	See Sheet RW 4.02

# **A**

# TABULATION OF SURVEY CONTROL POINTS

Point No.	Northing	Easting	Description
2305	598416.61	1036872.11	See Sheet RW 4.03
2307	599436.36	1037450.57	See Sheet RW 4.03
2309	600207.64	1038368.47	See Sheet RW 4.03
2311	600729.34	1039356.64	See Sheet RW 4.03



## TABULATION OF FOUND R.O.W. MARKERS

Point No.	Northing	Easting	Description
1014	599316.96	1037537.24	See Sheet RW 4.03
1015	599402.46	1037624.95	See Sheet RW 4.03
1016	599421.85	1037660.62	See Sheet RW 4.03
1017	599664.69	1037848.90	See Sheet RW 4.03
1018	599457.84	1037391.59	See Sheet RW 4.03
1021	600258.93	1038020.50	See Sheet RW 4.03
1022	600305.52	1038056.64	See Sheet RW 4.03
1026	600119.02	1038376.36	See Sheet RW 4.03
1031	600158.00	1038462.12	See Sheet RW 4.03
1033	600217.12	1038561.20	See Sheet RW 4.03
1034	600269.58	1038654.10	See Sheet RW 4.03
1035	600218.84	1038712.23	See Sheet RW 4.03
1044	600463.89	1038617.70	See Sheet RW 4.03
1045	600494.22	1038687.42	See Sheet RW 4.03
1046	600556.91	1038843.78	See Sheet RW 4.03
1047	600645.85	1038974.14	See Sheet RW 4.03
1048	601117.52	1039369.45	See Sheet RW 4.03
1049	601505.91	1039495.86	See Sheet RW 4.03
1050	601055.41	1039559.47	See Sheet RW 4.03
1052	600441.73	1039079.88	See Sheet RW 4.03
2002	600975.36	1039285.89	See Sheet RW 4.03

CAP		MONUMENT TYPE								
TYPE	1	1A	2	2A	3	3A	4	5	5(S)	6
REFERENCE										
ROW	15									
CONTROL										
ALIQUOT CORNER										
PERMANENT EASEMENT										3
PROJECT POINTS										
•										

#### ⊙ PP

## TABULATION OF FOUND PROPERTY PINS

Point No.	Northing	Easting	Description
1019	599615.81	1037515.24	See Sheet RW 4.03
1020	599888.83	1037761.62	See Sheet RW 4.03
1024	599877.74	1038031.36	See Sheet RW 4.03
1025	599859.30	1038048.91	See Sheet RW 4.03
1027	600129.93	1038400.46	See Sheet RW 4.03
1028	600084.94	1038421.83	See Sheet RW 4.03
1029	600061.96	1038366.72	See Sheet RW 4.03
1030	600076.28	1038359.59	See Sheet RW 4.03
1036	600008.88	1038604.29	See Sheet RW 4.03
1037	600130.53	1038715.00	See Sheet RW 4.03
1038	600126.86	1038719.06	See Sheet RW 4.03
1039	599807.03	1038826.36	See Sheet RW 4.03
1040	599911.33	1038785.99	See Sheet RW 4.03
1041	599971.03	1038819.69	See Sheet RW 4.03
1042	600068.41	1038823.38	See Sheet RW 4.03
1043	600445.65	1038572.99	See Sheet RW 4.03
1051	600554.42	1039249.30	See Sheet RW 4.03
1053	600395.02	1038968.65	See Sheet RW 4.03
1054	600368.53	1038913.99	See Sheet RW 4.03
1056	600357.42	1038887.96	See Sheet RW 4.03
1057	600310.97	1038935.79	See Sheet RW 4.03
1058	600357.33	1038916.63	See Sheet RW 4.03
1059	599818.95	1037520.41	See Sheet RW 4.03
1063	601343.50	1037786.21	See Sheet RW 4.03
1066	599057.62	1038886.94	See Sheet RW 4.03



# TABULATION OF R.O.W. MARKERS TO BE SET (CDOT Type 1)

	,	71	•	
Point No.	Northing	Easting	Station	Offset
402	600368.84	1038376.73	498+42.32	104.65
403	600495.99	1038562.31	500+59.57	153.72
404	600635.06	1038496.09	500+49.13	307.40
405	600675.90	1038466.34	500+36.49	356.31
406	600693.23	1038490.14	500+64.99	363.68
407	600616.04	1038575.16	501+15.73	260.69
408	600634.94	1038599.91	501+45.69	268.87
409	600546.02	1038660.02	501+68.88	164.34
410	600738.08	1038878.97	504+63.53	257.54
411	600762.72	1038913.98	505.18.64	263.32
412	600870.20	1039112.92	508+31.40	219.02
413	600915.59	1039229.23	509+63.73	150.81
414	600468.64	1038561.57	500+48.83	128.56
415	600139.86	1038428.63	497+99.77	126.42
416	600033.60	1038550.04	498+75.46	271.35



# TABULATION OF PERMANENT EASEMENT MARKERS TO BE SET (CDOT Type 6)

Point No.	Northing	Easting	Station	Offset
600	600363.42	1038349.30	498+15.75	110.11
601	600394.68	1038377.56	498+55.52	128.73
602	600469.11	1038540.06	500+29.04	137.01




# TABULATION OF TEMPORARY EASEMENT POINTS

	TO BE	STAKED	
Point No.	Northing	Easting	Description
700	600283.58	1038869.44	NW Corner of TE-8
701	600295.03	1038897.17	NE Corner of TE-8
702	600265.03	1038897.37	SE Corner of TE_8
703	600253.58	1038869.64	SW Corner of TE-8
	No. 700 701 702	Point No. Northing 700 600283.58 701 600295.03 702 600265.03	No.         Northing         Edsting           700         600283.58         1038869.44           701         600295.03         1038897.17           702         600265.03         1038897.37

# GENERAL NOTES:


- This Right-of-Way plan is not a complete boundary survey of all the adjoining property owners and is prepared for the Transportation Department purposes ONLY.
- 2. Title Commitments/Policies were supplied by Security Title Guaranty Co.
- 3. NOTICE: According to Colorado law you must commence any legal action based upon any defect in this survey within three years after you first discover such defect. In no event may any action based upon any defect in this survey be commenced more than ten years for the date of certification shown hereon.
- 4. All R.O.W. Markers set from survey control points.
- 5. All centerline and offset stationing is theoritical only and may not represent the centerline as constructed in the field.
- 6. All coordinates listed are PROJECT COORDINATES.
- 7. BASIS OF BEARING: Bearings used in the calculations of coordinates are based on a grid bearing of N 49°57'58" E from US-285 CM-MP 230.7 and US-285 CM-MP 230.9. Both monuments are CDOT Type II, marked appropriately for their milepost location and control position. The survey data was obtained from a Global Positioning System (GPS) survey based on the Colorado High Accuracy Reference Network (CHARN).

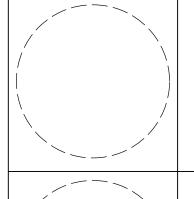

## SURVEYOR STATEMENT (ROW PLANS)

I, <u>Kevin Williams</u>, a professional land surveyor licensed in the State of Colorado, do hereby state to the Colorado Department of Transportation that based upon my knowledge, information and belief, research, calculations, and evaluation of survey evidence were performed and this Right-of-Way Plan was prepared under my responsible charge in accordance with applicable standards of practice defined by Colorado Department of Transportation publications. This statement is not a guaranty or warranty, either expressed or implied.

PLS	No.	28294

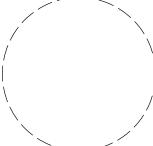

## SURVEYOR STATEMENT (ROW MONUMENTS)

I, <u>Kevin Williams</u>, a professional land surveyor licensed in the State of Colorado, do hereby state to the Colorado Department of Transportation that based upon my knowledge, information and belief, adequate research, calculations, and evaluation of survey evidence were performed and Right of Way monuments depicted on this Right-of-Way Plans were set under my responsible charge in accordance with applicable standards of practice defined by Colorado Department of Transportation publications. This statement is not a guaranty or warranty, either expressed or implied.

DIS	Ma	28294	
1 LJ	IVO.	20237	

Date

[	Sheet Revisions	Sheet Revisions Sheet Revisions	Right of Way Plans
Colorado Department of Transportation	Data Description Initials Date	Description Initials Det Description Initials	Monumentation Sheet
18500 East Colfax Avenue	C4/09 Remove Wilson Lago AC mm/yv	mm/yy	Project Number: NH 2854-108
DOT 18500 East Colfax Avenue Aurora, CD 80011 Phone: 303-365-7410 FAX: 303-365-7350			Project Number:  Project Location: US 285 at Shaffer's Crossing
Region 1 KAW			Project Code: Last Mod. Date Subset Sheets Sheet No.  15048 04/16/09 2 of 3 4.02
	<u> </u>	<u>                                     </u>	15048 04/16/09 2 of 3 4.02
	T. 6 S., R 71 W., 6th P.M.		0' 500' 1000' 2000' I'' - 1000'

Colorado Department of Transportation		Sheet Revisions			
		Description	Initial		
	04/09	Remove Wilson Logo	A.C.		
18500 East Colfax Avenue		<u> </u>			

| Date | Description | Date |

	Right	of Way	Plans	
Monumentation Sheet				
Project Nu	mber: NH 28	54-108		
Project Number:				
Project Lo	cation: US 2	85 at Shaffe	er's Crossin	g
roject Code:	Last Mod. Date	Subset Sheets	Sheet No.	
15048	04/16/09	3 of 3	4.03	

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Region 1

Fnd. 3<sup>1</sup>/<sub>4</sub>" Alum. Cap Pt. No. 1008



Fnd. 3<sup>1</sup>/<sub>4</sub>" Alum. Cap Pt. No. 1064



Sheet Revisions

Fnd. 31/4" Alum. Cap Pt. No. 1055



Sheet Revisions

Fnd. 3" Alum. Cap Pt. No. 1068



Fnd. 3<sup>1</sup>/<sub>4</sub>" Alum. Cap Pt. No. 1065




Fnd. 3" Alum. Cap Pt. No. 1067



Fnd. 3 4" Brass Cap set in 6" dia. concrete Pt. Nos. 1015 & 1018




Fnd. 3<sup>1</sup>/<sub>4</sub>" Alum. Cap Pt. Nos. 1014,1016,1017,1021, 1022,1026,1031,1033–1035,1044–1050, 1052, & 1061

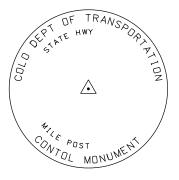

Fnd. 31/4" Alum. Cap Pt. Nos. 2305,2307,2309,2311




Fnd. 11/4" Plastic Cap Pt. No. 1019

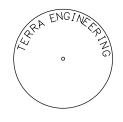


Fnd. #4 Rebar with Plastic Cap Pt. No. 1043



Fnd. 1½" Alum. Cap Pt. No. 1051

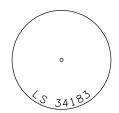


Fnd. Plastic Cap Pt. Nos. 1041, 1042, 1054 & 1056

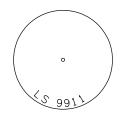



Fnd. 1½" Alum. Cap Pt. No. 1058





Fnd. #5 Rebar Pt. Nos. 1020,1024,1025,1027-1030, 1036-1040,1053,1057,1059 1063,1064, & 1066

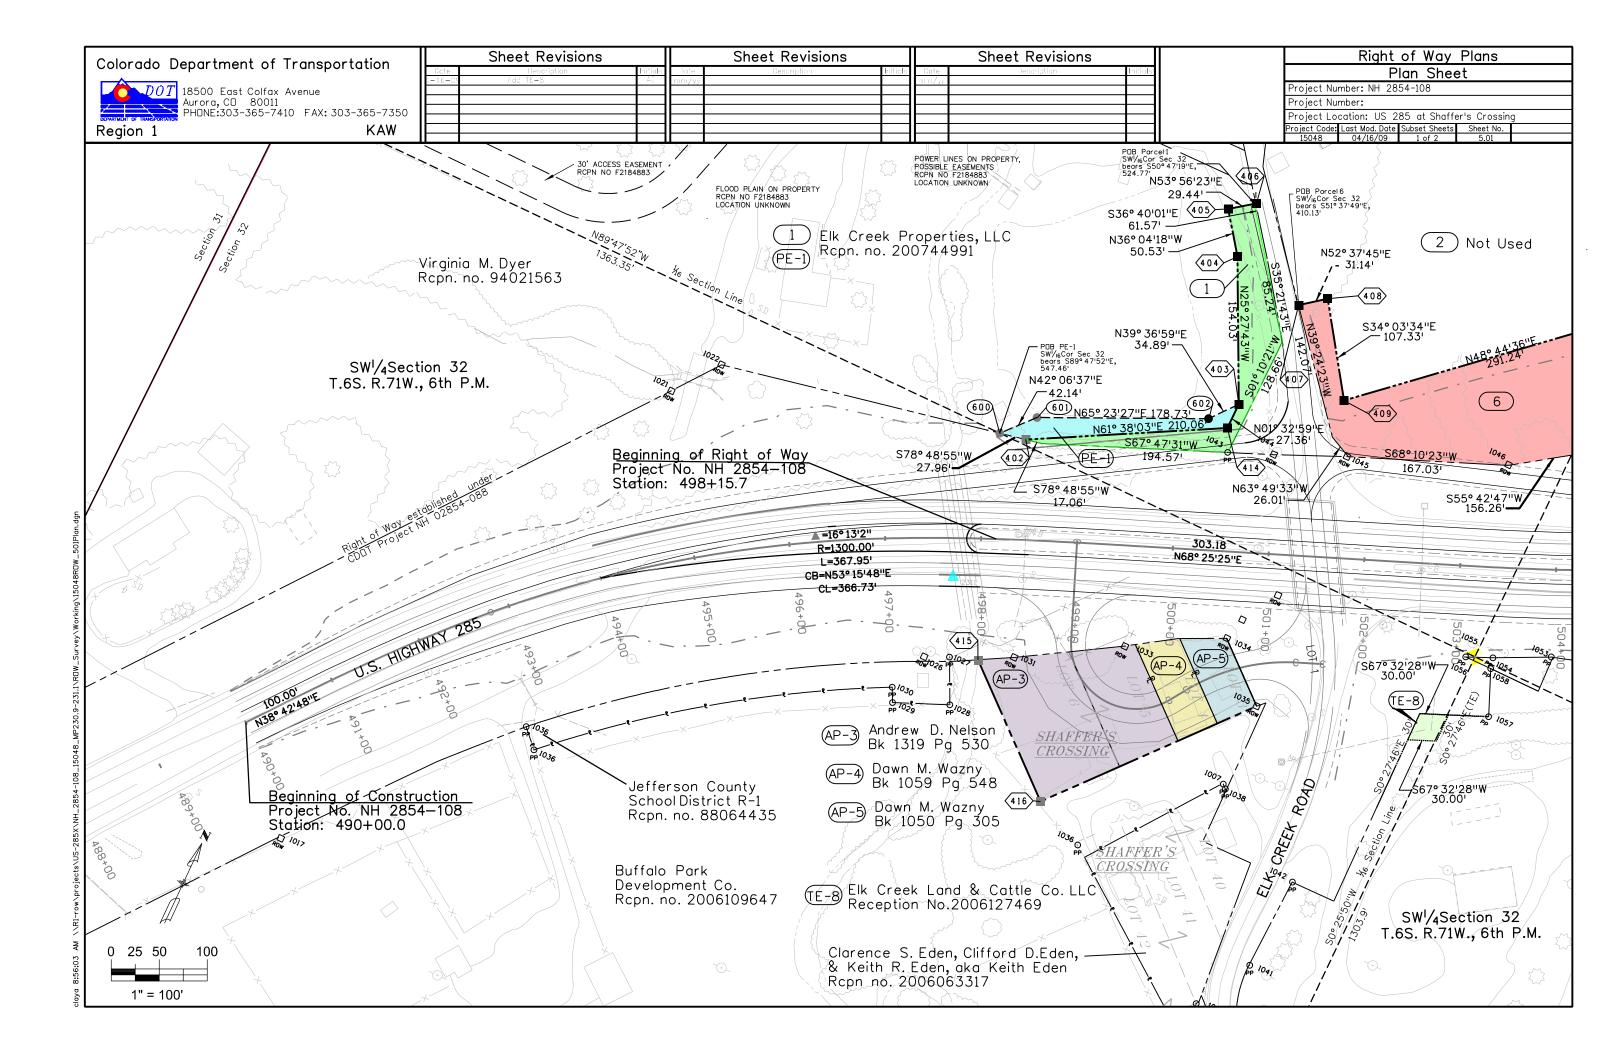


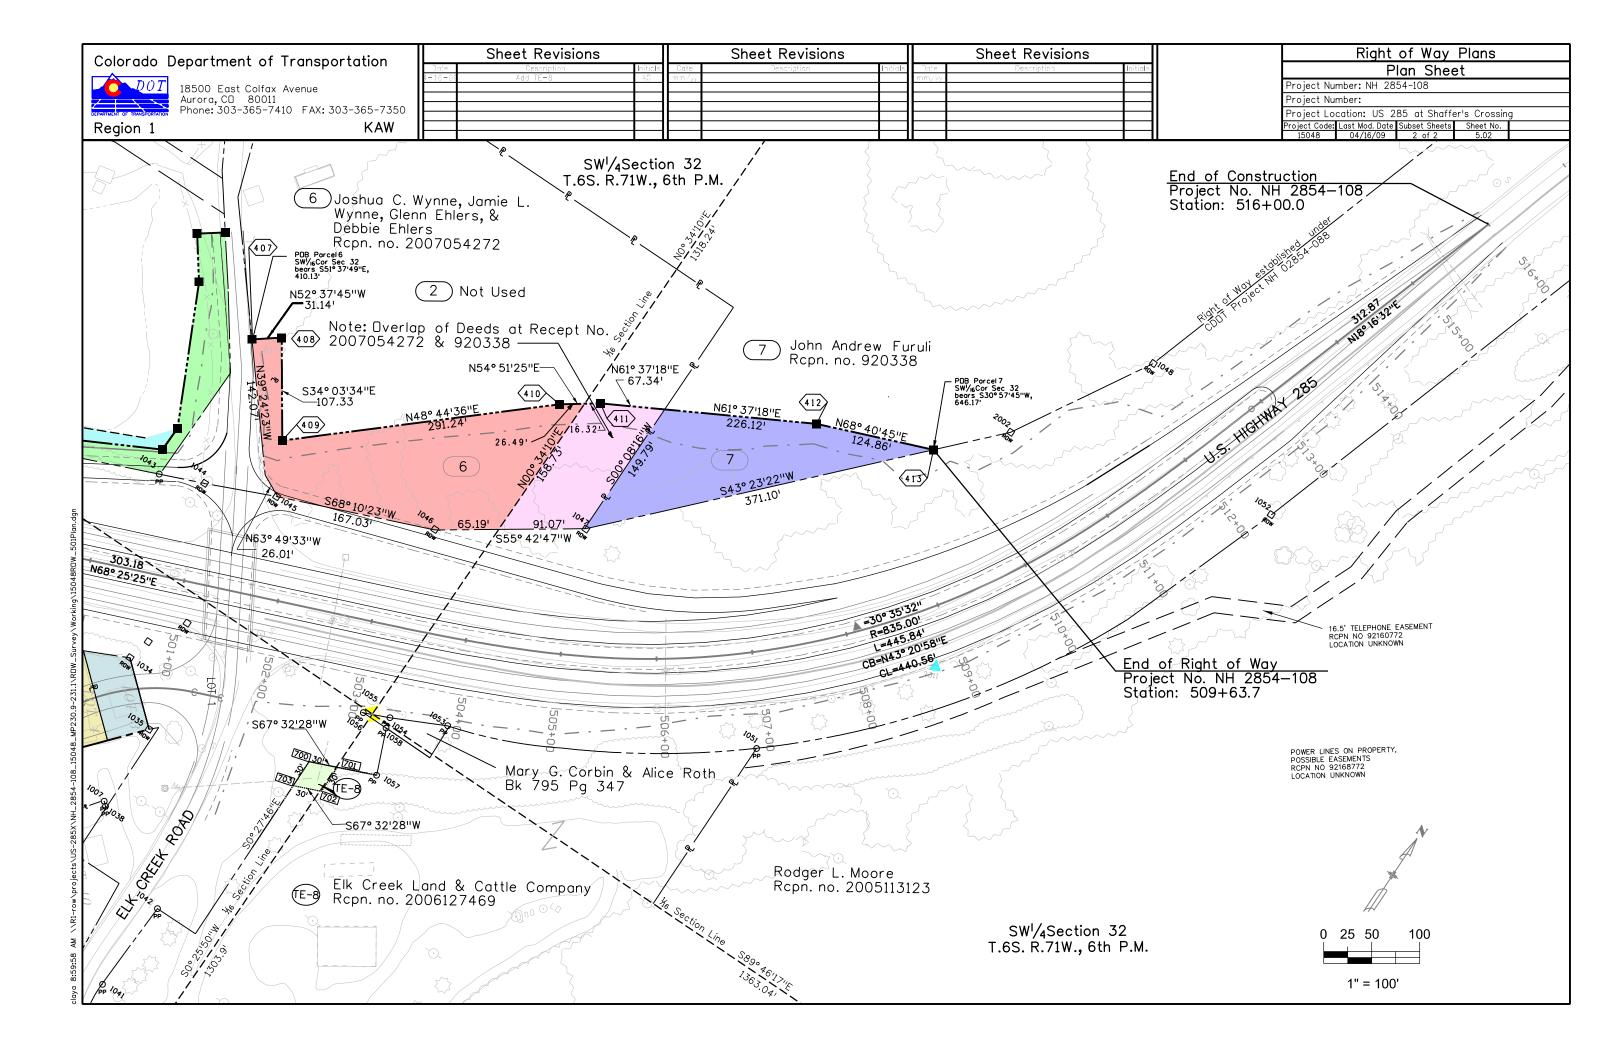


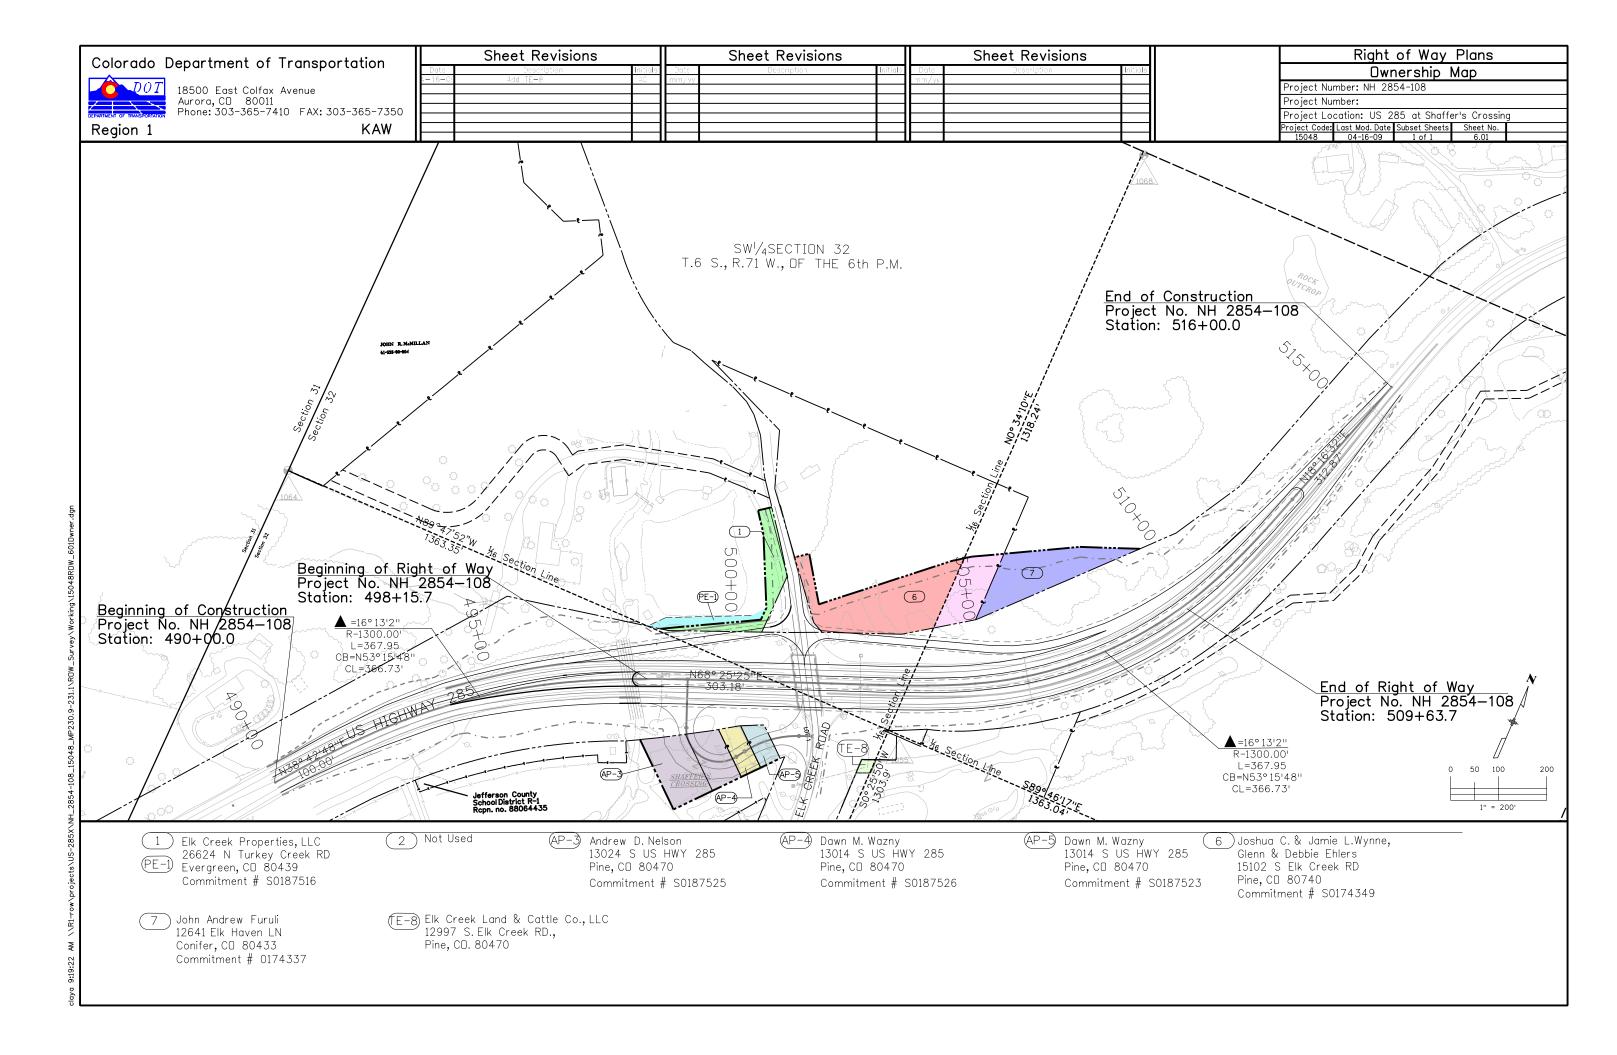


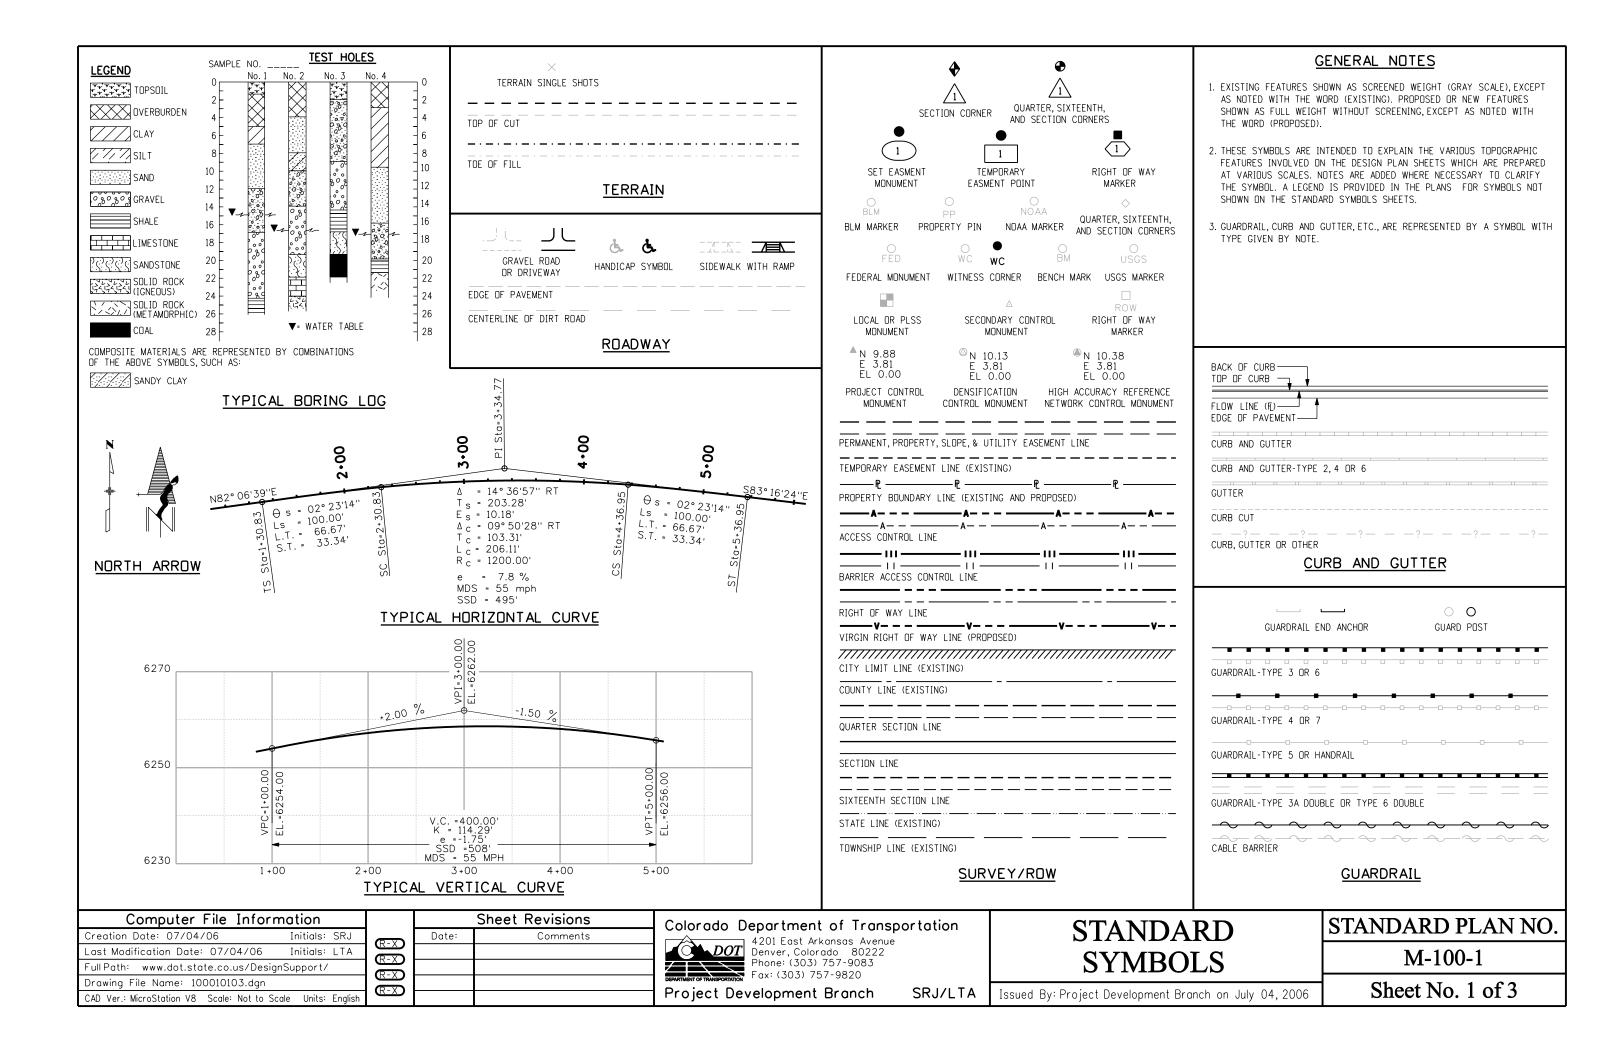


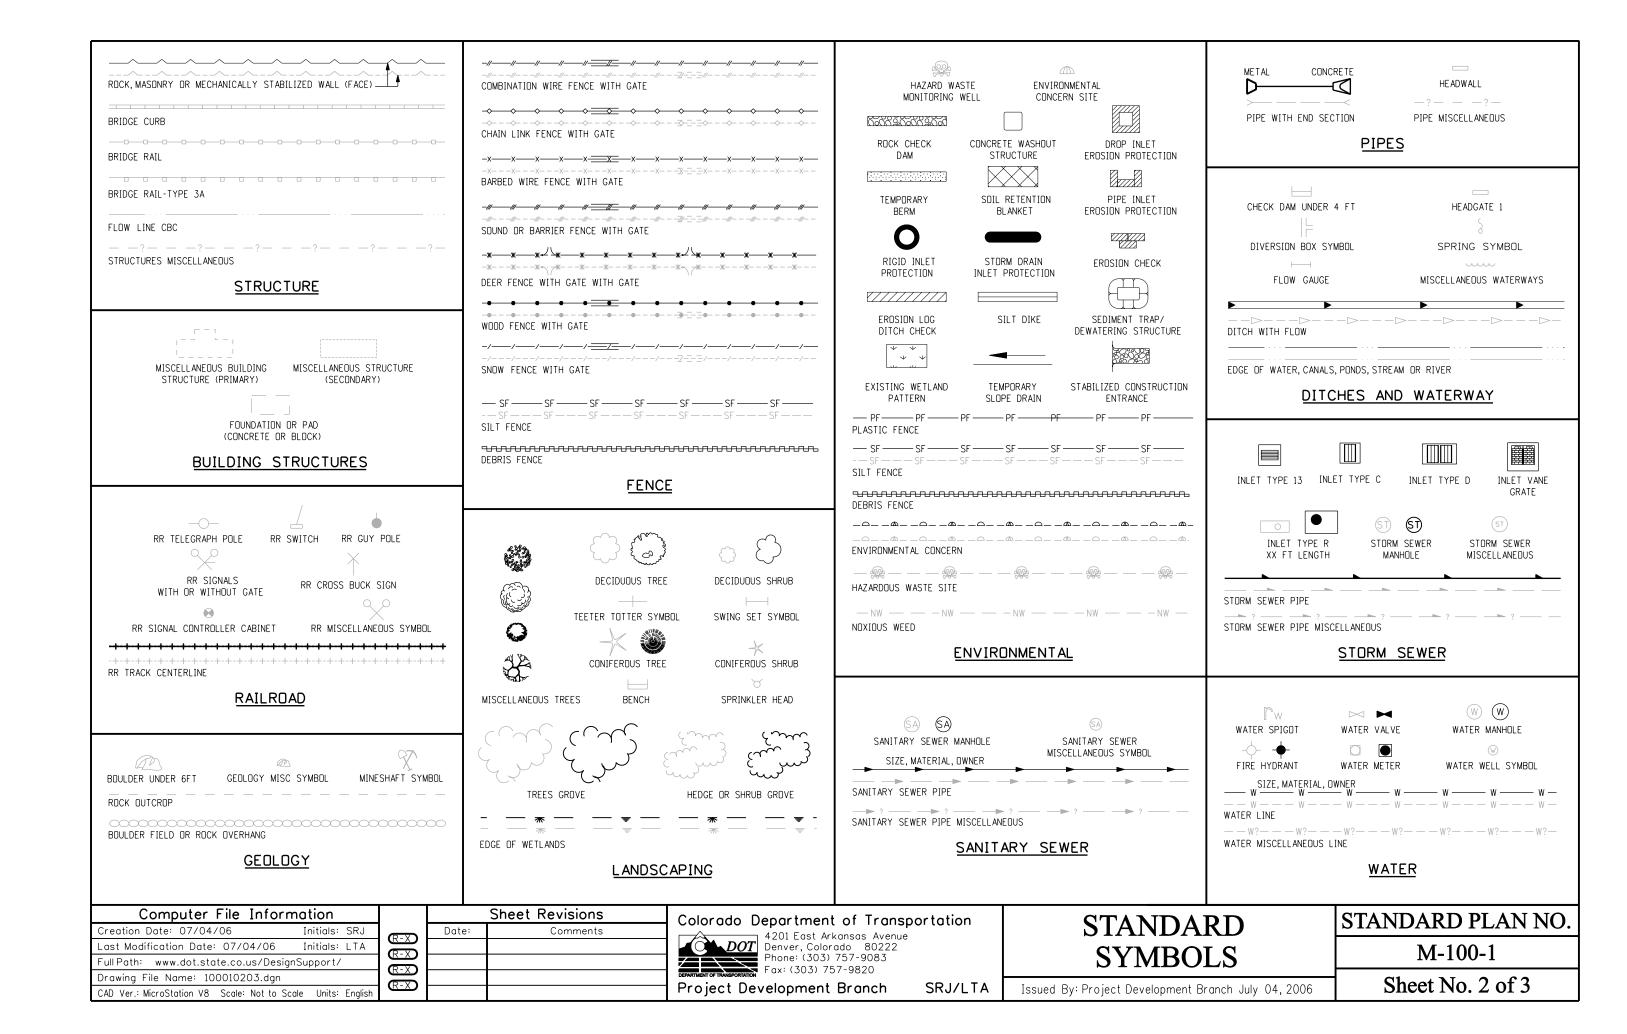


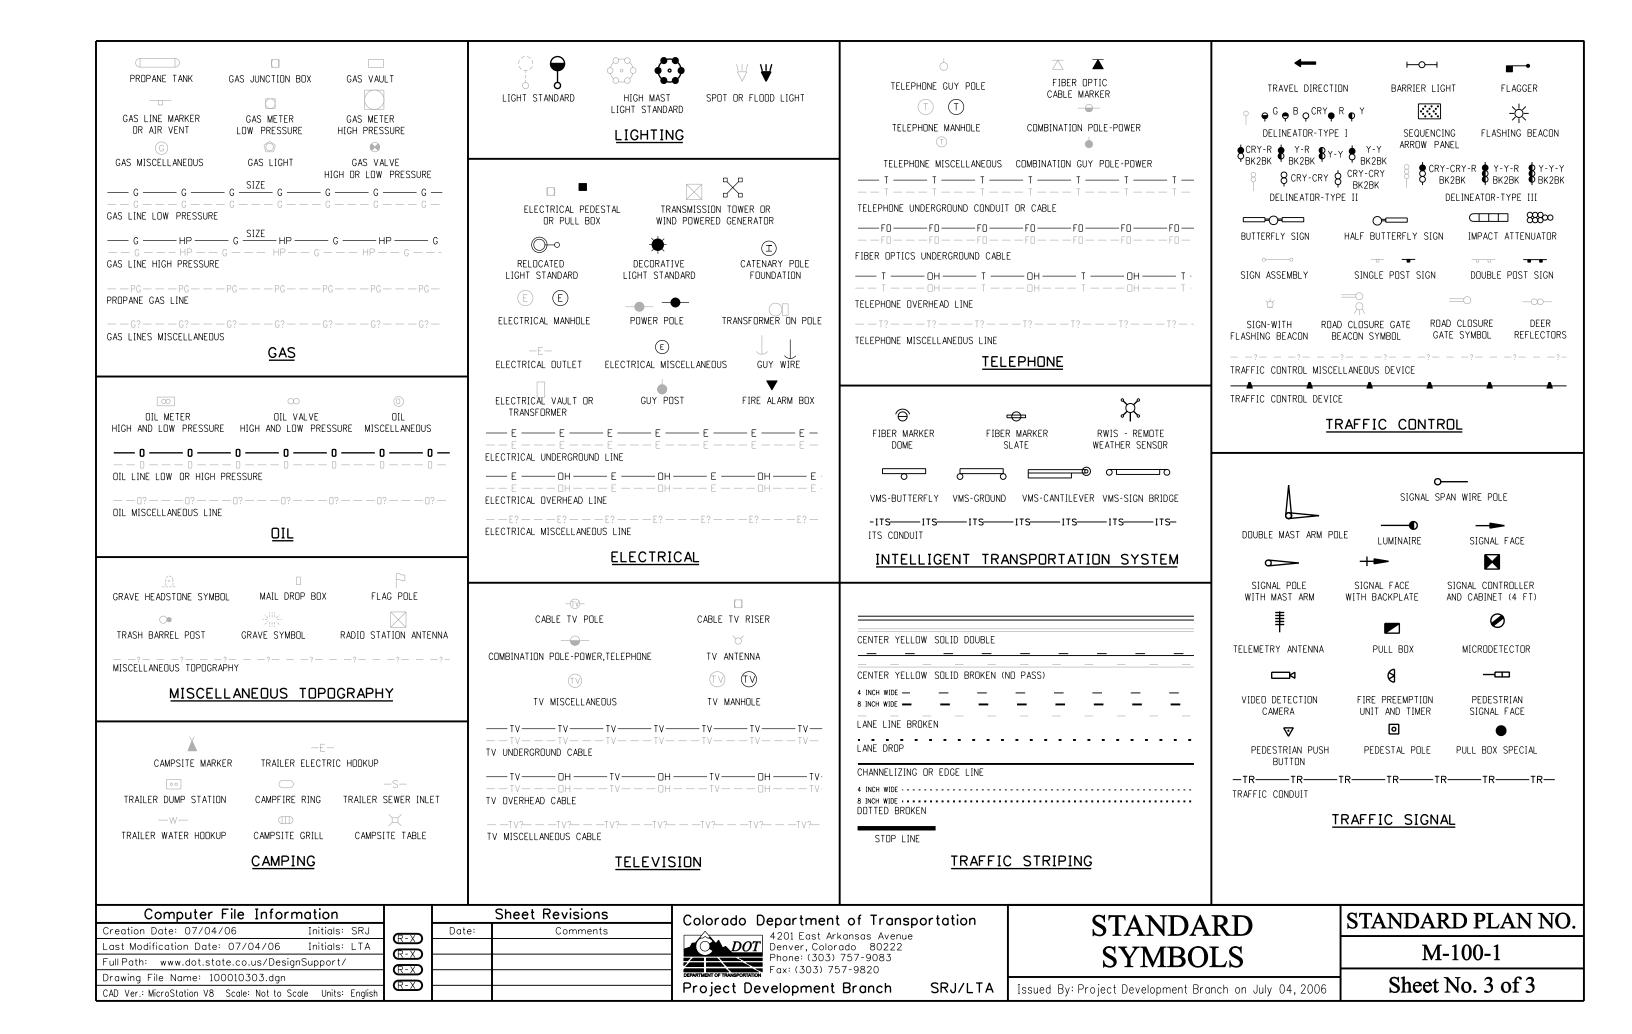


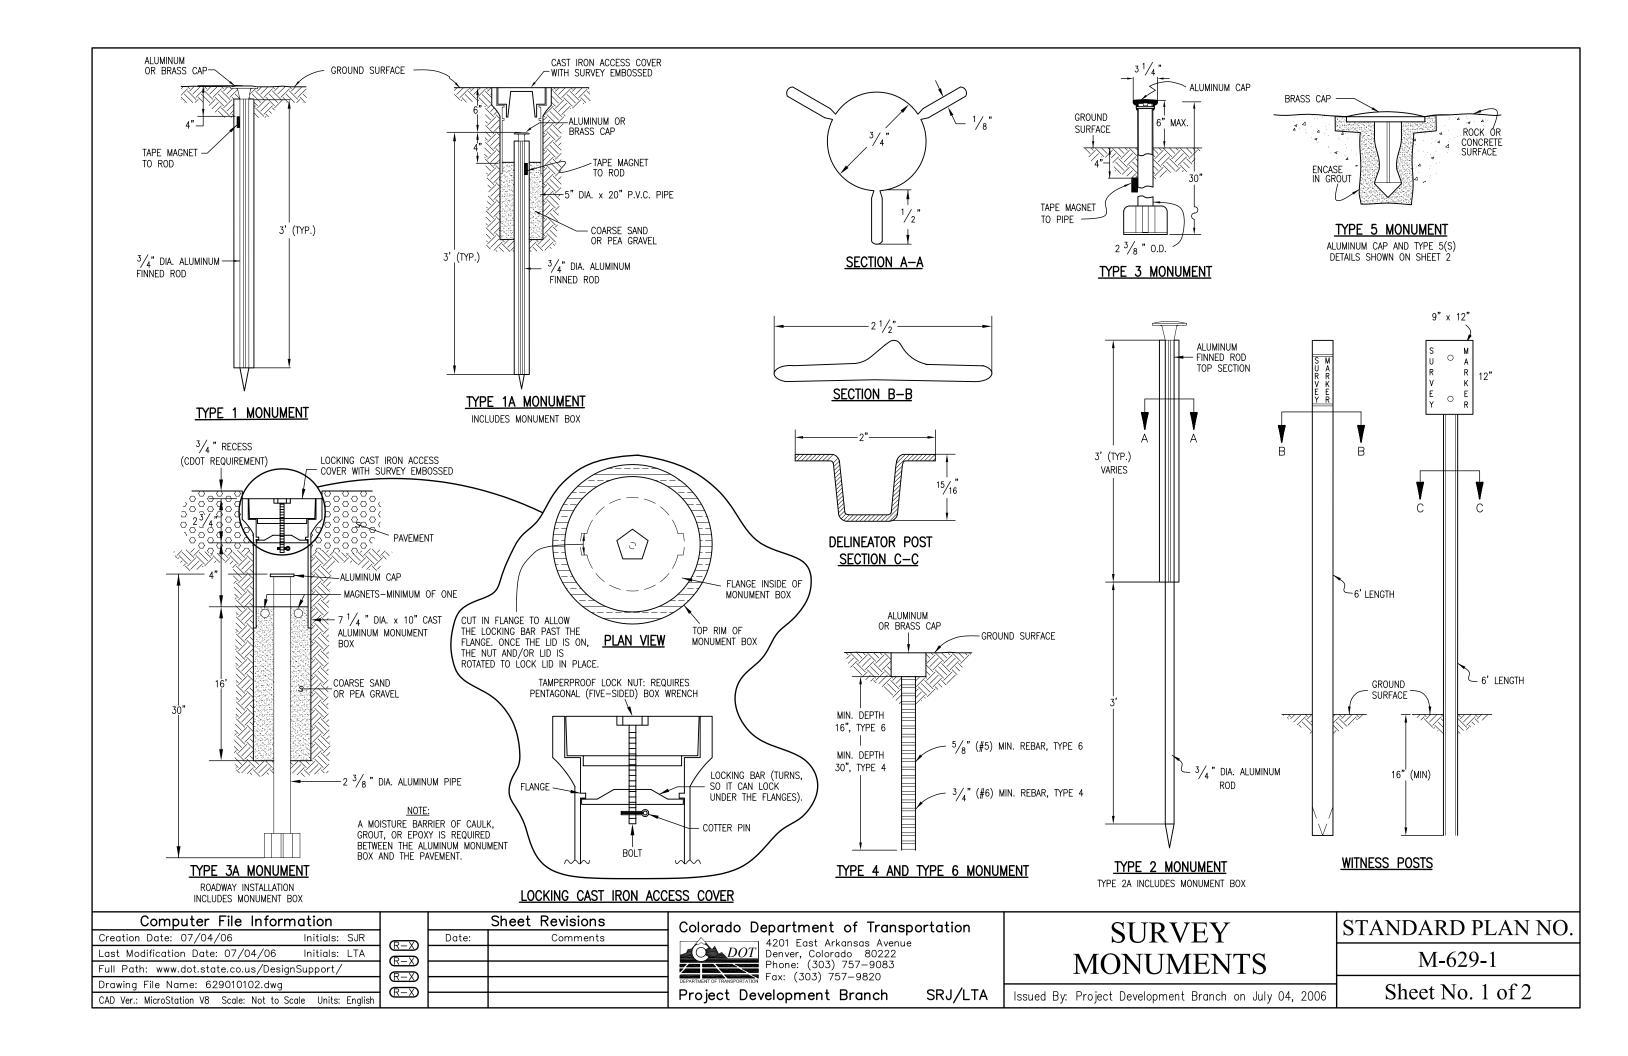

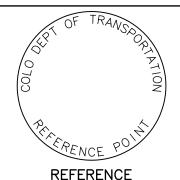

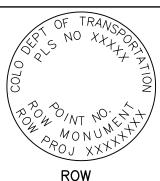

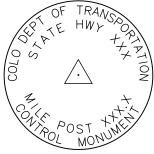

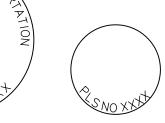

CONTROL ALIQUOT CORNER MONUMENT CAP MONUMENT CAP


50XX

NO XX


—TY.4, 2"-


ALUMINUM CAP

MONUMENT CAP MONUMENT CAP NOTE: A BLANK CAP MAY BE SUBSTITUTED IF THE APPROPRIATE CAP SHOWN ABOVE IS NOT AVAILABLE. IF A BLANK CAP IS USED, ALL INFORMATION NORMALLY INCLUDED ON THE APPROPRIATE STANDARD CAP, SHALL BE STAMPED ON THE BLANK CAP ALONG WITH SPECIFIC PROJECT INFORMATION SUCH

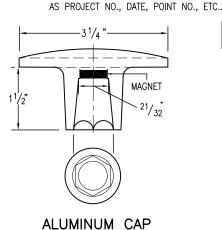

USED WITH ALUMINUM ROD

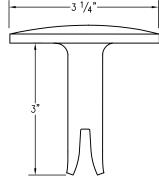

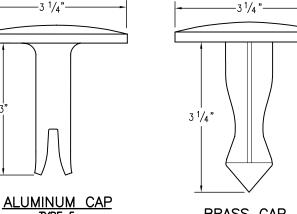



TYPE 5 FOR PLACING IN EXISTING TYPE 5 CONCRETE OR ROCK

BRASS CAP FOR PLACING IN EXISTING CONCRETE OR ROCK

# MONUMENT APPLICATION

CAP TYPE	MONUMENT TYPE									
CAP TIPE	1	1A	2	2A	3	3A	4	5	5(S)	6
REFERENCE	Х	Х						Х	Х	Х
ROW	Х	Х						Х	X	
CONTROL			Х	Х				Х	Х	
ALIQUOT CORNER	Х	Х			Х	Х	Х	Х		
PERMANENT EASEMENT								Х	Х	Χ
PROJECT POINTS								Х	Х	Χ
WITNESS POST * (REQUIRED)	Х		Х	х	х			х		

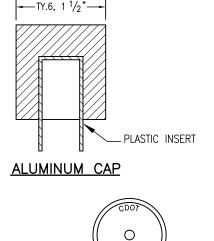

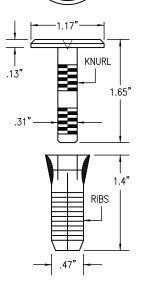

# COPPER ALLOY CAP TYPE 5(S)

FOR PLACING IN EXISTING SIDEWALK, CURB, OR GUTTER

## ALL MONUMENTATION MATERIALS WILL BE FURNISHED BY CDOT

THE MONUMENT TYPE SHALL MEET THE MINIMUM STANDARDS AS DETERMINED BY THE COLORADO STATE BOARD OF REGISTRATION FOR PROFESSIONAL LAND SURVEYORS RULES (STATE BOARD RULES).

THE CDOT SURVEY COORDINATOR SHALL APPROVE ALL EXCEPTIONS FOR STAMPING MONUMENTS DIFFERING FROM THE STANDARDS.

## TYPE 1 AND TYPE 1A ALUMINUM FINNED ROD MONUMENTS

THIS MONUMENT SHALL BE USED FOR ROW OR REFERENCE MONUMENTS OR MAY BE USED FOR AN ALIQUOT CORNER MONUMENT. WHEN USED AS AN ALIQUOT CORNER MONUMENT, INSTALLATION AND RECORD FILING REQUIREMENTS SHALL BE AS STATED FOR TYPE 3 AND TYPE 3A MONUMENTS.

MONUMENTS SHALL BE INSTALLED BY ATTACHING THE PROPER SIZE TIP TO ONE END OF A SECTION OF FINNED ROD. AND A 3 IN. LONG X 3/4 IN. DIA. STAINLESS STEEL ADAPTER TO THE OTHER END. THE DRIVER IS THEN PLACED OVER THE STAINLESS STEEL ADAPTER FOR THE HAMMER TO CONTACT. TYPE 1 MONUMENTS SHALL USE A MINIMUM 3 FT. SECTION OF FINNED ROD. WHEN SUBSURFACE ROCK OR CONCRETE IS ENCOUNTERED LESS THAN 3 FT. BELOW THE GROUND SURFACE, THE ROD SHALL BE EMBEDDED IN THE ROCK OR IN CONCRETE AT LEAST 6 IN. AND GROUTED IN PLACE. THE ROD MAY BE SHORTENED TO ACCOMMODATE THE CONDITIONS.

WHEN UNSTABLE SOIL CONDITIONS ARE ENCOUNTERED, ADDITIONAL SECTIONS OF ROD SHALL BE ADDED TO ACHIEVE STABILITY. HORIZONTAL AND VERTICAL STABILITY ARE REQUIRED.

TYPE 1A MONUMENT INCLUDES MONUMENT BOX. A LOCKING CAST IRON ACCESS COVER SHALL BE INSTALLED WHEN THE MONUMENT IS LOCATED IN THE ROADWAY PAVEMENT.

#### TYPE 2 AND TYPE 2A ALUMINUM FINNED ROD MONUMENTS

THIS MONUMENT SHALL BE USED FOR HORIZONTAL AND VERTICAL CONTROL MONUMENTS. WHEN UNSTABLE SOIL CONDITIONS ARE ENCOUNTERED, ADDITIONAL SECTIONS OF ROD SHALL BE ADDED TO ACHIEVE STABILITY. HORIZONTAL AND VERTICAL STABILITY ARE REQUIRED. IN MOST SOIL CONDITIONS THE TYPE 2 MONUMENT IS EMBEDDED 6 FT. INTO THE GROUND.

THE MONUMENT SHALL BE INSTALLED BY FIRST ATTACHING THE PROPER SIZE TIP TO A 3 FT. LONG X 3/4 IN. DIA. ROD, THEN DRIVING THE ROD AT LEAST 30 IN. INTO THE GROUND. ADDITIONAL 3 FT. LONG X 3/4 IN. FINNED ROD SECTIONS SHALL BE ADDED AND DRIVEN FLUSH WITH THE GROUND UNTIL THE MONUMENT IS IN A STABLE POSITION. THE FINS ARE BENT OVER USING PLIERS TO ACCOMMODATE INSTALLING THE CAP. THE CAP IS FIRMLY SEATED ONTO THE LAST FINNED SECTION OF ROD USING A DEAD BLOW SLEDGE HAMMER.

TYPE 2A MONUMENT INCLUDES MONUMENT BOX. A LOCKING CAST IRON ACCESS COVER SHALL BE INSTALLED WHEN THE MONUMENT IS LOCATED IN THE ROADWAY PAVEMENT.

#### TYPE 3 AND TYPE 3A ALUMINUM PIPE MONUMENTS

THIS MONUMENT SHALL BE USED FOR AN ALIQUOT CORNER MONUMENT. THE INSTALLATION OF THIS MONUMENT AND RECORD FILING SHALL BE DONE IN ACCORDANCE WITH THE STATE BOARD RULES. ALSO REFER TO THE CDOT SURVEY MANUAL AND THE BUREAU OF LAND MANAGEMENT REQUIREMENTS FOR MONUMENT INSTALLATION. THE LAND SURVEYOR'S LICENSE NUMBER AND THE YEAR SHALL BE STAMPED ON THE CAP.

TYPE 3A MONUMENT INCLUDES MONUMENT BOX. A LOCKING CAST IRON ACCESS COVER SHALL BE INSTALLED WHEN THE MONUMENT IS LOCATED IN THE ROADWAY PAVMENT.

#### TYPE 4 ALUMINUM MONUMENT

THIS MONUMENT MAY BE INSTALLED IN LIEU OF REPLACING THE ENTIRE MONUMENT WHEN REBAR IS IN PLACE AT AN ALIQUOT CORNER LOCATION. REFER TO THE STATE BOARD RULES. A MINIMUM 2 IN. DIA. CAP SHALL BE USED ON 3/4 IN. (#6) REBAR.

#### TYPE 5 BRASS/ALUMINUM CAP MONUMENT

THIS MONUMENT MAY BE INSTALLED IN LIEU OF ALL OTHER CDOT MONUMENTS, WHEN THE POSITION IS LOCATED IN CONCRETE OR STABLE ROCK FORMATION.

#### TYPE 5(S) COPPER ALLOY CAP MONUMENT - SMALL

THIS MONUMENT MAY BE INSTALLED IN LIEU OF A TYPE 5 MONUMENT, WHEN THE POSITION IS LOCATED IN A CONCRETE SIDEWALK, CURB OR GUTTER, OR WHEN SETTING A TYPE 5 WOULD COMPROMISE THE INTEGRITY OF THE RECEIVING STRUCTURE.

#### STAMPING REQUIREMENTS:

- "RP", WHEN THE APPLICATION IS A REFERENCE POINT.
- "ROW", POINT NUMBER, "LS", AND REGISTRATION NUMBER WHEN THE APPLICATION IS A ROW POINT
- "CP" AND A UNIQUE IDENTIFIER PROVIDED BY THE REGION SURVEY COORDINATOR, WHEN THE APPLICATION IS A CONTROL POINT.
- "PE", POINT NUMBER, "LS", AND REGISTRATION NUMBER,
- WHEN THE APPLICATION IS A PERMANENT EASEMENT POINT.
- "PP" AND POINT NUMBER, WHEN THE APPLICATION IS A PROJECT POINT.

#### TYPE 6 ALUMINUM MONUMENT

THIS MONUMENT SHALL BE USED FOR PERMANENT EASEMENTS, PROJECT BENCH MARKS, PROJECT POINTS, AND REFERENCES. AN ALUMINUM CAP WITH A MINIMUM DIAMETER OF 11/2 IN., SHALL BE USED ON 5/8 IN. (#5) MINIMUM REBAR.

#### \* WITNESS POSTS

THE WITNESS POST WILL BE SUPPLIED BY CDOT AND INSTALLATION SHALL BE INCLUDED IN THE WORK. IT SHALL BE DRIVEN WITHIN 1 FT. OF THE MONUMENT WHEN POSSIBLE. A DELINEATOR POST WITH A 9 IN. X 12 IN.METAL SIGN PANEL MAY BE USED IN LIEU OF THE PLASTIC POST. THIS POST SHALL CONFORM TO STANDARD PLAN S-612-1. A REQUIRED WITNESS POST MAY BE OMITTED WITH THE APPROVAL OF THE ENGINEER IF THE WITNESS POST LOCATION IS WITHIN A TRAVELED WAY, DRIVEWAY, OR ACCESS OPENING.

#### Computer File Information Creation Date: 07/04/06 Initials: SJR Last Modification Date: 07/04/06 Initials: LTA Full Path: www.dot.state.co.us/DesignSupport/ Drawing File Name: 629010202.dwg CAD Ver.: MicroStation V8 Scale: Not to Scale Units: English

		Sheet Revisions
(R-X)	Date:	Comments
R=X)		
(R-X)		
$\mathbb{R}$ -X		

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Colorado [	Department of Transportation
	4201 East Arkansas Avenue Denver, Colorado 80222
DUI	」Denver,Colorado 80222
	Phone: (303) 757–9083
DEPARTMENT OF TRANSPORTATION	Fav. (303) 757-0820

Project Development Branch

SRJ/LTA

SURVEY
MONUMENTS

OTTD TIDE

STANDARD PLAN NO

M-629-1

Issued By: Project Development Branch on July 04, 2006

Sheet No. 2 of 2