OF WAY		
OF THE COUNTY LAND SURVEYS/RIGHT OF WAY	NUMBER	nepr
COUNTY LAND	RECEPTION N	
OF THE (		
ĺ	'n	

OF   20	OF THE COUNTY LAND SUI	RECEPTION NUM	
THIS DAY OF	100	AT PAGE	
DEPOSITED THIS	IN BOOK	SURVEYS AT PAGE	

DEPOSITED THIS DAY OF, 2	IN BOOK OF THE COUNTY LANG	SURVEYS AT PAGE RECEPTION	GICHED
			ATF LPA dwg

0.0000 0.0						
COLORADO DEPARTMENT OF TRANSPORTATION		Sheet Revisions			Sheet Revisions	
	Date	Description	Initials	Date	Description	Ini
Pogr Region 4			$\neg$			$\neg$
Address: 1420 2nd Street			$\neg \neg$			$\neg$
Region 4 Address: 1420 2nd Street Greeley CO 80631						$\neg$
Greeley, CO 80631  O'ANNEDIT O' TUMBER TATAO Phone: (970) 350-2153 FAX: (970) 350-2178			-			-
COMMENTO THURSDAY PHONE. (970) 330-2133 PAX: (970) 330-2170			$\dashv$	-		_
Right of Way Plans Units: PTS			<del></del>			-
right of way flams office. 115			$\rightarrow$			-

 $\Lambda$ 

QUARTER, SIXTEENTH,

AND SECTION CORNERS

RICHT OF WAY

POINT TO BE STAKED

0

QUARTER, SIXTEENTH,

AND SECTION CORNERS

RIGHT OF WAY

MARKER

●N 10.38

E 3.81 EL 0.00

HIGH ACCURACY REFERENCE NETWORK CONTROL MONUMENT

USGS

USGS MARKER

 $\Lambda$ 

SECTION CORNER

PROPERTY PIN

O WC

TEMPORARY

WC

SECONDARY CONTROL

MONUMENT

SURVEY/ROW

**TERRAIN** 

WITNESS CORNER

E 3.81 EL 0.00

DENSIFICATION

PERMANENT, PROPERTY, SLOPE, & UTILITY EASEMENT LINE

PROPERTY BOUNDARY LINE (EXISTING AND PROPOSED)

O NOAA

NOAA WARKER

RENCH MARK

(1)

SET EASMENT

BLM MARKER

FED

FEDERAL MONUMENT

LOCAL OR PLSS

MONUMENT

E 3.81 EL 0.00

ACCESS CONTROL LINE

RIGHT OF WAY LINE

CITY LIMIT LINE (EXISTING)

COUNTY LINE (EXISTING)

QUARTER SECTION LINE

SIXTEENTH SECTION LINE STATE LINE (EXISTING)

TOWNSHIP LINE (EXISTING)

SECTION LINE

TOP OF CUT

TOE OF FILL

BARRIER ACCESS CONTROL LINE

VIRGIN RIGHT OF WAY LINE (PROPOSED)

PROJECT CONTROL

TEMPORARY EASEMENT LINE (EXISTING)



200 WEST OAK FORT COLLINS, CO 80522 Phone: (970)498-5700 Fax: (970)498-7986 PROJECT ENGINEER: JST

	Right of	Way	Plans	
	Title	Shee	et	
roject Nu	mber: SHO C060-	053		
roject Lo	cation: LCR-27			
		- 3	3 2000 30	
oject Code:	Lost Mod. Date		Sheet No.	
17569	11/23/10		1.01	

# LARIMER COUNTY STATE OF COLORADO RIGHT OF WAY PLANS OF PROPOSED

PROJECT NO. SHO C060-053 REALIGNMENT OF STOVE PRAIRIE ROAD (CR 27) AT MP 21.8 ACROSS A PORTION OF SEC. 20, T8N, R71W OF THE SIXTH PM LARIMER COUNTY RIGHT OF WAY

R.O.W. Length of Project = 918.72 Feet / 0.174 Miles Const. Length of Project = 802.56 Feet / 0.152 Miles ROUDRE CANYON **END CONSTRUCTION PROJECT END ROW PROJECT** STATION: 12+00 STATION: 10+21.50 M.P.: 21.87 M.P.: 21.84 SECTION 20-C 1/4 CORNER OF SECTION BEGIN ROW PROJECT BEGIN CONSTRUCTION PROJECT STATION: 4+00 STATION: 1+05.04 M.P.: 21.72 M.P.: 21.66 N-S\_€ OF SECTION STOVE PRAIRIE

PROJECT MAP LOCATION

INDEX OF SHEETS SHEET NO.

(1) Title Sheet 2.01 (1) Tabulation of Properties 3.01 Project Control Diagram

4:01 (NA) Land Survey Control Diagram 5.01 (1) Monumentation Sheet <del>-6:01</del> (NA) Tabulation of Road Approach Sheets

7.01 Plan Sheet 8.01 Ownership Map

(6) Total Sheets

Scales of Original 11x17 Drawings Plan Sheets 1"=80" Ownership Map 1"=800'

Bosis of Bearings: SEE "CONTROL DIAGRAM" SHEET 3.01

1. This Right—of—Way Plan is not a boundary survey of the adjoining property and is prepared for the Colorado Department of Transportation purposes only.

2. For title information, The Colorado Department of Transportation relied on (Title Policy), (Title Commitments), (Memorandums of Ownership) prepared by (Title Co. or individual) for (Title Insurance Co. or consultant)

3. This plan set is subject to change and may not be the most current set. It is the user's responsibility to verify with CDOT that this set is the most current. The information contained on the attached drawing is not valid unless this copy bears an original signature of the Professional Land Surveyor hereon named.

NOTICE: According to Colorado law you must commence any legal action based upon any detect in this survey within three years after you first discover such defect. In no event may any action based upon any defect in this survey be commenced more than ten years from the date of the certification shown hereon.


DEPARTMENT OF TRANSPORTATION STATE OF COLORADO

RIGHT OF WAY MANAGER

#### SURVEYOR STATEMENT (ROW PLAN)

I, DALE Y. GREER, a professional land surveyor licensed in the State of Colorado, do hereby state to the Colorado Department of Transportation that based upon my knowledge, information and belief, research, calculations and evaluation of the survey evidence were performed and this Right-of-Way Plan was prepared under my responsible charge in accordance with applicable standards of practice defined by Colorado Department of Transportation publications. This statement is not a guaranty or warranty, either expressed or implied

PLS No. 16404

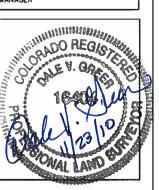

Note: For a complete listing of symbololgy used within this set of plans, please refer to the M-100-1 Standard Symbols of the Colorado Department of Transportation M&S Standards Publication dated July 2006. Existing features are shown as screened weight (gray scale), except as noted with the word (existing). Proposed or new features are shown as full weight without screening, except as noted with the word (proposed).

# COLORADO DEPARTMENT OF TRANSPORTATION

	$\Delta$		OT	ì
	$\mathbf{C}$	V	OT	l
1	11	1		ľ
		A 100	W. Marr	l

Region 4 Address: 1420 2nd Street Greeley, CO 80631 Phone: (970) 350-2153 FAX: (970) 350-2178 Right of Way Plans Units: PTS

	Sheet Revisions			Sheet Revisions	
Dote	Description	Initials	Date	Description	Initi
$\overline{}$	<del></del>		<u> </u>		



COUNTY FORT COLLINS, CO 80522
Phone: (970)498-5700
Fax: (970)498-7986
PROJECT ENGINEER: JST

Right o	of Way Pla	ons
Tabulation	n of Prop	erties
Project Number: SHO C06	0-053	
Project Location: LCR-27	,	
Project Code: Last Mod. Date	Subset	Sheet No.
17569 11/23/10	2.01 to 2.01	2,01

	R.O.W. TABULATION OF PROPERTIES IN LARIMER COUNTY LCR-27										
					Area In	Square Feet	(Acres)		Book and Page No.	Title	Remarks
Parcel No.	Ownership Name and Mailing Address	Site Address	Location	Area Of Parcel	Existing ROW	Net Area	Remainder Left	Remainder Right	And/Or Reception No.	Commitment No.	
			SEC 20, T 8 N, R 71 W								
PE-1	COLLINS, SHAUN D. & CARRIE	6211 STOVE PRAIRIE RD. BELLVUE, CO 80512	NW 1/4 SEC. 20	0.44 ac	0.25 ac	0.19 ac					CONSTRUCTION \ MAINTENANCE FOR ROADWAY
		BELLEVOE, CO 60312					-				
TE-1	(SAME AS ABOVE)	(SAME AS ABOVE)	(SAME AS ABOVE)	0.09 ac							CONSTRUCTION OF ROADWAY
PE-2	ARMSTRONG, HOWARD & ELEANOR LEE	26501 FORDHAM DR.	E 1/2 SEC. 20	1.46 ac	0.91 ac	0.55 ac					CONSTRUCTION \ MAINTENANCE FOR ROADWAY
		SUN CITY, CA 92586-2552									
					_						

Right of Way Plans Units: MDG

DOT Region 4
Address: 1420 2nd Street
Greeley, CO 80631
Phone: (970) 350-2153 FAX: (970) 350-2178

	Sheet Revisions			Sheet Revisions	
ote	Description	Initials	Date	Description	Initi
		┼─┤	<b>—</b>		+
$\overline{}$		+-+	<b>—</b>		+-
		$\vdash$			-



200 WEST OAK FORT COLLINS, CO 80522 Phone: (970)498-5700 Fax: (970)498-7986 PROJECT ENGINEER: JST

Right of Way Plans Control Diagram Project Number: SHO C060-053 Project Location: LCR-27 Project Code: Last Mod. Date 17569 11/23/10

## SURVEYOR NOTES

NOTE: THIS CONTROL SURVEY IS FOR THE USE OF THE COLORADO DEPARTMENT OF TRANSPORTATION AND LARIMER COUNTY PERSONNEL. THE SURVEY IS NOT A COMPLETE BOUNDARY SURVEY. TITLE POLICY, TITLE COMMITMENT, AND TITLE RESEARCH WERE NOT PART OF THIS CONTROL SURVEY, THEREFORE, EASEMENTS, RIGHTS, AND RESTRICTIONS OF RECORD ARE NOT SHOWN. THE VERIFICATION OF THE PHYSICAL EVIDENCE WITH RELATION TO EASEMENTS, RIGHTS OF WAY, PROPERTY BOUNDARIES, AND RESTRICTION, AS DESCRIBED IN THE INSTRUMENTS OF RECORD, WERE NOT INCLUDED IN THIS CONTROL SURVEY.

NOTE: NO GUARANTEE AS TO THE ACCURACY OF THE INFORMATION CONTAINED ON THE ATTACHED DRAWING IS EITHER STATED OR IMPLIED UNLESS THIS COPY BEARS AN ORIGINAL SIGNATURE OF THE PROFESSIONAL LAND SURVEYOR HEREON NAMED.

SURVEYORS STATEMENT: I, BRIAN J. BARNES, A PROFESSIONAL LAND SURVEYOR IN THE STATE OF COLORADO, HEREBY STATE THAT THIS SURVEY CONTROL DIAGRAM WAS PREPARED UNDER MY DIRECT SUPERVISION \_\_\_FROM A FIELD SURVEY PERFORMED \_DAY OF \_\_\_ UNDER MY SUPERVISION AND CHECKING FOR AND ON BEHALF OF THE LARIMER COUNTY, STATE OF COLORADO, AND IS NOT A LAND SURVEY PLAT OR RIGHT-OF-WAY SURVEY PLAT AND TO THE BEST OF MY KNOWLEDGE AND BELIEF THIS CONTROL SURVEY, AS SHOWN, MEETS THE MINIMUM HORIZONTAL CONTROL TOLERANCES OF A TYPE B SURVEY AS LISTED IN THE COLORADO DEPARTMENT OF TRANSPORTATION SURVEY MANUAL CHAPTER THREE (REVISED

NOTICE: ACCORDING TO COLORADO LAW YOU MUST COMMENCE ANY LEGAL ACTION BASED UPON ANY DEFECT IN THIS SURVEY WITHIN THREE YEARS AFTER YOU FIRST DISCOVER SUCH DEFECT. IN NO EVENT, MAY ANY ACTION BASED UPON ANY DEFECT IN THIS SURVEY BE COMMENCED MORE THAN TEN YEARS FROM THE DATE OF THE CERTIFICATION SHOWN HEREON.

### SURVEYOR CERTIFICATE (FIELD) Control Survey and Monumentation was done under my supervision and checking.

NAME BRIAN J. BARNES P.L.S. NO. 29407

## BASIS OF PROJECT CONTROL


Project Control coordinates are based on geodetic bearing from Point 9 "CN 1/16 Corner of Section 20, Township 8 North, Range 71 West" having coordinate: Northing 79657.932, Easting 35406.486. And bearing N00°20'34"W to Point 12 "North Quarter Corner Section 20, Township 8 North, Range 71 West.


#### BASIS OF ELEVATIONS

Elevations are based on CP-BASE. Elevation 1029.41' Assumed Doturn. All other Project Control Points were then tied in by a differential level loop.



# PROJECT CONTROL DIAGRAM LARIMER COUNTY ROAD 27, SECTION 20, T8N, R71W OF THE 6TH PM, MP 21.66 TO MP 21.87

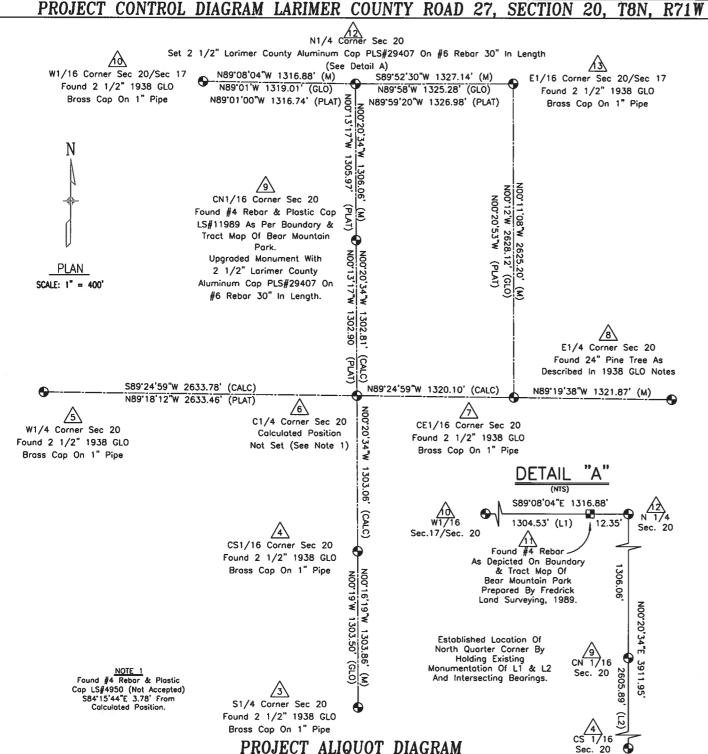

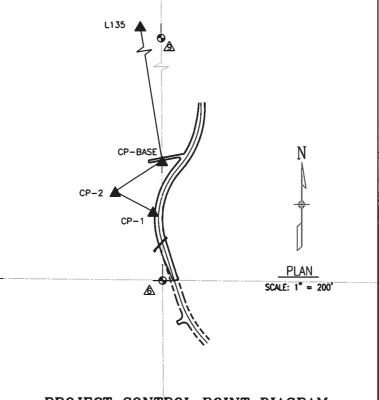


## PROJECT CONTROL POINT DIAGRAM

## **LEGEND**

SYMBOL	DESCRIPTION
	Section Line
<b>◆</b>	Section Corner
•	Section Quarter Corner, 1/16 Corner
	Vertical and Horizontal Control Point
A	High Accuray Reference Network Point (Harn)
	#4 Rebar
(M)	Measured
(GLO)	1938 GLO PLAT
(PLAT)	Boundry & Tract Map Bear Mountain Park

#### BASIS OF BEARINGS

Bearings used in the calculation of coordinates are based on a geodetic bearing of S0977'43"E from Colorado HARN Control Point "L135" to Larimer County Project Control Point "CP-BASE" as obtained from a Global Positioning System (GPS) Survey.

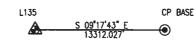

## PROJECT CONTROL POINT TABULATION

POINT	NORTHING	EASTING	ELEVATION	DESCRIPTION OF MONUMENTS
CP-BASE	78856.676	35412.344	1029.41	SET 1.5" ALUMINUM CAP ON #5 REBAR, CAP STAMPED "LARIMER COUNTY CP BASE"
CP-1	78644.763	35374.137	1000.00	SET 1.5" ALUMINUM CAP ON #5 REBAR, CAP STAMPED "LARIMER COUNTY CP 1"
CP-2	78728.323	35214.595	1015.46	SET 1.5" ALUMINUM CAP ON \$5 REBAR, CAP STAMPED "LARIMER COUNTY CP 2"

## GPS COORDINATE SUMMARY TABLE

(ADJUSTED FIELD DATA)

	GEODETIC COORDI	NATES NAD-83(92)	(NAVD 88)	NAD 83(92)	ZONE 0501
POINT	LATITUDE (N)	LONGITUDE (W)	ELLIPSOID	NORTHING	EASTING
L135	40'41'01.80006"	105'22'48.48350"	5972.264	1491993.908	3033262.184
CP-BASE	40'38'52.03366"	105'22'20.58382"	7131.511	1478856.676	3035412.344

A GPS Observation Was Conducted At CP-BASE To Connect To HARN Station L135. A HARN Value Was Derived For CP-BASE. All Other Horizontal Values On The Project Are Ground Length Coordinates. The Base Point For These Coordinates Is CP-BASE State Plane Coordinate Truncated To Show A Value Five Places Left Of The Decimal Point To Avoid Confusion With True State Plane Coordinates.

# COLORADO DEPARTMENT OF TRANSPORTATION

Address: 1420 2nd Street
Greeley, CO 80631
Phone: (970) 350-2153 FAX: (970) 350-2178

Right	of	Way	Plans	Units:	PTS

	Sheet Revisions			Sheet Revisions	
Date	Description	Initials	Date	Description	Initials
		$\dashv$			
		$\blacksquare$			



COUNTY
FORT COLLINS, CO 80522
Phone: (970)498-5700
Fox: (970)498-7986
PROJECT ENGINEER: JST

_	Right	of Way	Plans	
	Monum	entation	Sheet	
Project Nu	mber: SHO C	060-053	-	
Project Lo	cation: LCR-	27		•
Project Code:	Last Mod. Date	Subset	Sheet No.	
17569	11/23/10	5.01 to 5.01	5.01	



TABUL	ATION OF PERMAN	ENT EASEMENT
	POINTS TO BE	STAKED
Point No.	Northing(ft)	Easting(ft)
14	78071.863	35575.388
15	78219.509	35474.122
6	78355.127	35414.282
16	78937.930	35520.519
17	78819.020	35411.510
18	78879.147	35411.123
19	78895.862	35498.460
20	78937.930	35520.519
21	78922.809	35578.582
22	78846.217	35558.635
23	78751.893	35498.931
24	78642.866	35459.193
25	78521.947	35446.404
26	78404.040	35483.940
27	78290.370	35531.170
28	78214.880	35556.230
29	78131.710	35607.500
30	78117.892	35621.287


NOTE: POINTS TO BE STAKED ARE NOT PERMANENT MONUMENTS.

_

Point No. Northing(ft)		t No. Northing(ft) Easting(ft) Description	
32	78812.996	35311.540	Temporary Construction Easement
33	78860.400	35311.257	Temporary Construction Easement
18	78879.147	35411.123	Temporary Construction Easement
31	78849.718	35411.322	Temporary Construction Easement

	TABULATION OF FOUND ALIQUOT CORNER CONTROL						
Point No.	Northing (ft)	Easting(ft)	Description				
3	75748.251	35428.268	FOUND 2 1/2" 1938 GLO BRASS CAP ON 1" PIPE				
4	77052.086	35422.079	FOUND 2 1/2" 1938 GLO BRASS CAP ON 1" PIPE				
5	78381.958	32780.642	FOUND 2 1/2" 1938 GLO BRASS CAP ON 1" PIPE				
7	78341.679	36734.312	FOUND 2 1/2" 1938 GLO BRASS CAP ON 1" PIPE				
8	78326.160	38056.090	FOUND 24" PINE TREE AS DESCRIBED IN 1938 GLO NOTES				
9	79657.932	35406.486	FOUND#4 REBAR & PLASTIC CAP LS 11989				
10	80983.862	34081.940	FOUND 2 1/2" 1938 GLO BRASS CAP ON 1" PIPE				
13	80966.864	36725.811	FOUND 2 1/2" 1938 GLO BRASS CAP ON 1" PIPE				

TABULATION OF SET ALIQUOT CORNER CONTROL					
Point No.	Northing (ft)	Easting(ft)	Description		
9	79657.932	35406.486	SET 2 1/2" LARIMER COUNTY ALUMINUM CAP PLS#29407 ON #6 REBAR 30" IN LENGTH CN 1/16 COR SEC 20		
12	80963.967	35398.671	SET 2 1/2" LARIMER COUNTY ALUMINUM CAP PLS#29407 ON #6 REBAR 30" IN LENGTH N 1/4 COR SEC 20		

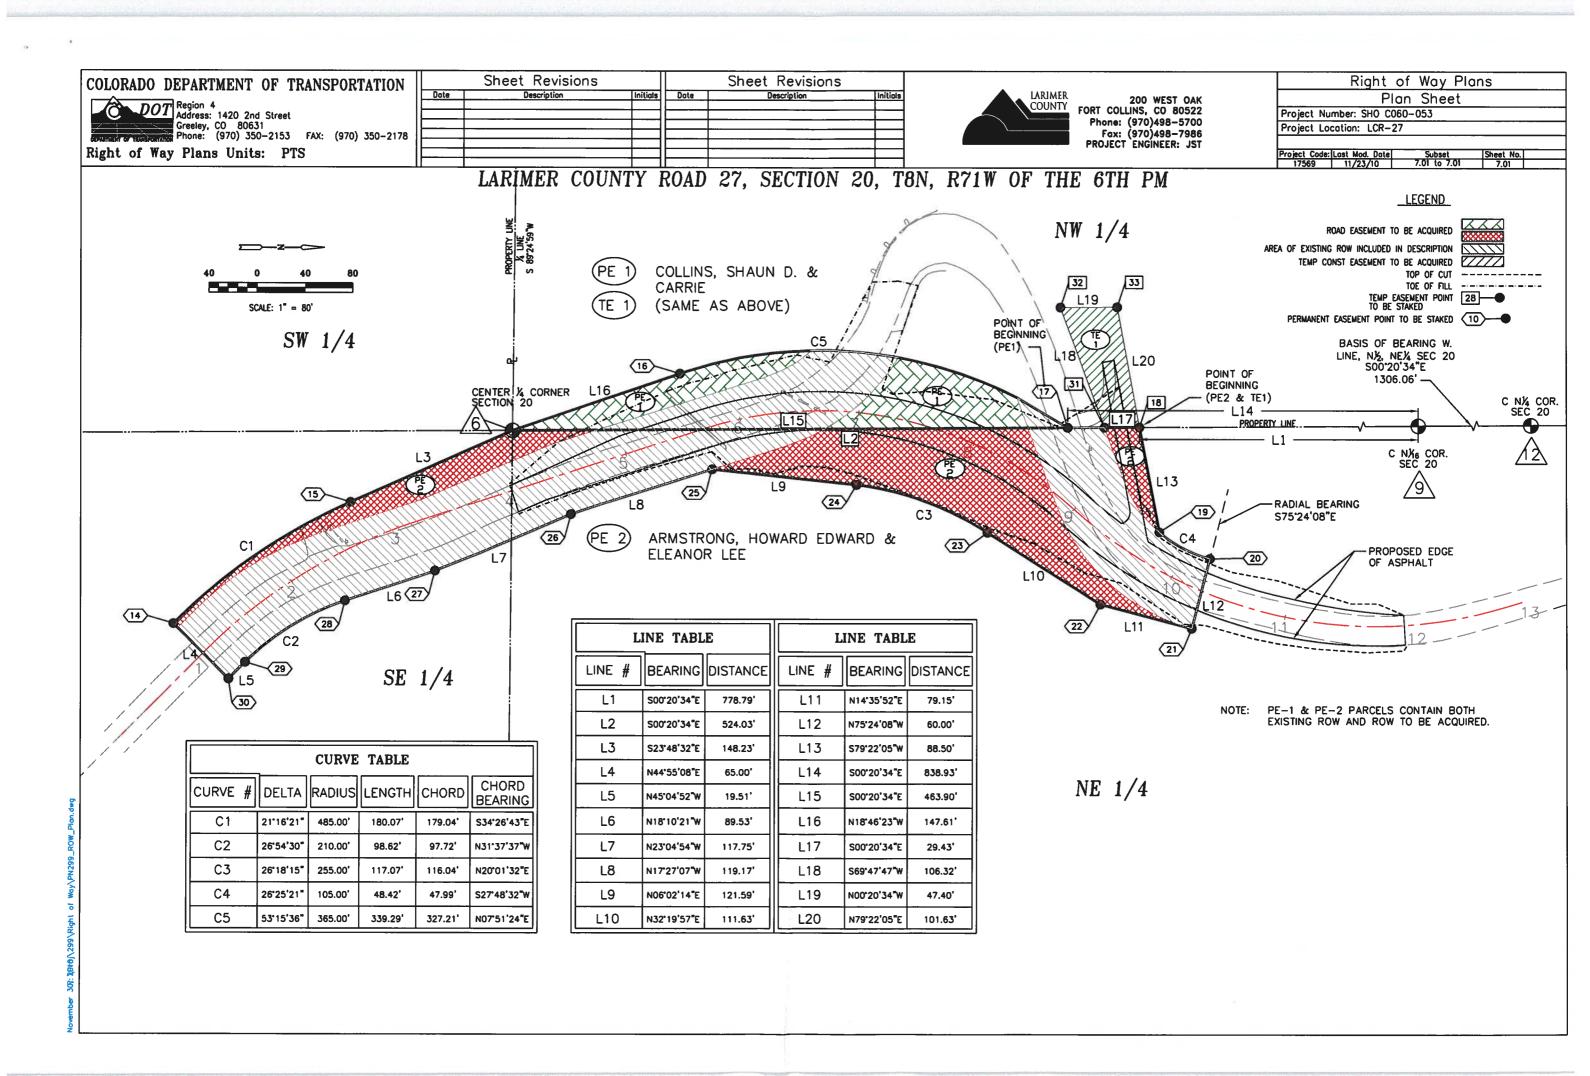

## COLORADO DEPARTMENT OF TRANSPORTATION

Region 4
Address: 1420 2nd Street
Greeley, CO 80631
Phone: (970) 350-2153 FAX: (970) 350-2178

Right of Way Plans Units: PTS

I		Sheet Revisions		Sheet Revisions		
l	Date	Description	Initiols	Date	Description	Initia
١						
l	<del></del>		1			
ı			$\bot$			
	<u> </u>		+		<u> </u>	$\dashv$




200 WEST OAK FORT COLLINS, CO 80522 Phone: (970)498-5700 Fax: (970)498-7986 PROJECT ENGINEER: JST

Right o	of Way Pla	ons
Owner	ship Shee	et
Project Number: SHO C06	0-053	
Project Location: LCR-27	7	
Project Code: Lost Mod. Date	Subset	Sheet No.
17569 11/23/10	8.01 to 8.01	8.01

SCALE: 1" = 800'

PLAN SCALE: 1" = 800'

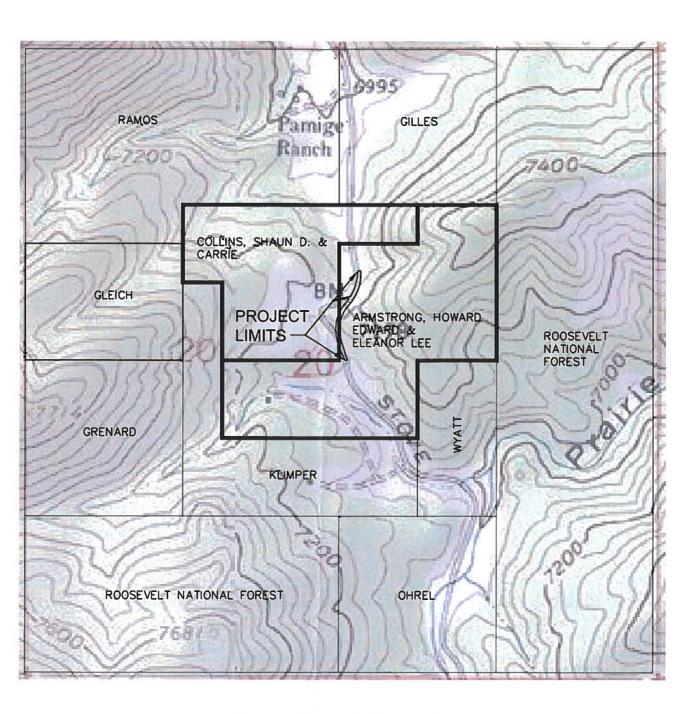

SEC. 20, T7N, R71W