DOT Region 1 18500 E. Colfax Avenue Aurora, CO 80011

Survey Unit: Joseph Conway

Phone: (303) 757-9744 FAX: (303) 757-9746

	Sheet Revisions	
/yy	XXXXX	XXX

INTERSTATE 70 MP 180.0 to MP 196.0

SITUATE IN THE WHITE RIVER NATIONAL FOREST IN THE COUNTY OF SUMMIT AND THE COUNTY OF EAGLE. STATE OF COLORADO.

Project Control Diagram

Title Sheet

Project Number: STA R100-104

Project Location: INTERSTATE 70 - VAIL PASS

Project Location: MILEPOST 180 TO MILEPOST 196 Project Code: Last Mod. Date Subset Sheets Sheet No. Total No. of Sheets

10-27-04 XXX of XXX 1 repared By

mountain surveying & Mapping. Inc.

8751 E. HAMPDEN AVE. SUITE B-1 DENVER, COLORADO 80231 (303) 306-1858



Typical Control Monument Cap Not to Scale

BASIS OF BEARINGS: All bearings are grid bearings of the Calorado State Plone Coordinate System, Central Zone, North American Datum1983/92. The basis of grid bearing is the line between NSRS horizontal station "Vail Pass", a horizontal control disk set in a boulder, and I-70 CM-MP 190.00, a CDOT Type II monument. Said line bears N 37*40'07" E.

BASIS OF ELEVATIONS: Project is based on a elevation of 3234,238m on NSRS Station VAIL PASS", a horizontal cantrol disk set in a boulder. Elevations are relative to NAVD88. The control monuments from milepost 180.00 to 190.00 were tied in by means of running a closed bench loop.

COORDINATE DATUM: Coordinates on this project are for the exlusive use of the CDOT for the construction of this project and are considered Project Coordinates only.



CP - Control Point Monuments set by MSM, Inc.. They were CDOT type 2 monuments, a 3-1/4" dia. aluminum control monument cop (as shown) on a 3' X 3/4" dia. finned aluminum security rod on a 3' X 3/4" dia. smooth

NOTE: This cantrol survey is for the use of the Colorado Department of Transportation personnel. The survey is not a complete Boundary Survey. Title Policy, Title Commitment, and Title Research were not part of this contral survey, therefore, easements, rights, and restrictions of record are not shown. The verification of the physical evidence with relation to easements, rights of way, property boundaries, and restriction, as described in the instruments of record, were not included in this control survey.

NOTE: According to Calorado law you must commence any legal action based upon any defect in this survey within three years ofter you first discover such defect. In no event may any action based upon any defect in this survey be commenced more than ten years from the date of the statement shown.

NOTE: No guarantee as to the accuracy of the information contained on the attached drawing is either stated or implied unless this copy bears an original signature of the professional land surveyor hereon named.

SURVEYORS STATEMENT: I, Michael D. Heimbuck, a Professional Land Surveyor in the State of Colorado, hereby state that this Control Survey Diagram was prepared under my direct supervision this _____day of ______, from a field survey performed under my supervision and checking for and on behalf of the Department of Transportation, State of Colorado, and is not a Land Survey Plat or Right-of-Way Survey Plat and to the best of my knowledge and belief this control survey, as shown, meets the minimum horizantal control tolerances of a Type B Survey and this topographic survey, as shown, meets the minimum horizontal control tolerances of a Type D Survey as listed in the Colorado Department of Transportation Survey Manual Chapter Three (Revised 4/29/92).

CONSTRUCTION SURVEYING AND MONUMENTATION REQUIREMENTS:

- 1). This Cantral Survey Diagram represents the horizontal and vertical control for the project established by the Division. It is possible that same of the survey control manuments listed have been disturbed or obliterated. It is the Contractor's responsibility to verify the existence and stability of the control manuments before
- All Type 1 and Type 2 monuments shall be set flush with the ground. Witness
 posts shall be installed 1 fact from and facing all Type 1 and Type 2 monuments, or as directed by the Project Engineer.
- Installation of Type 3 and Type 3-A monuments shall be completed in the same day that installation is commenced. Under no circumstances shall hales in the roadway be left open overnight.
- 4). When installing Type 3-A monuments, the aluminum access cover shall be positively secured to the PVC pipe with screws or glue. The access cover shall be caulked with asphalt caulking between the cover and the edges of the roadway surface to provide a positive moisture barrier around the access cover.

- 5). Cantrol survey pracedures, statistical analysis, and accuracy obtained for harizantal and vertical cantrol shall be documented in the field book
- 6). Legible copies of the field books shall be submitted to the Project Engineer review on a monthly bosis.
- 7). It is ultimately the prime Cantroctors responsibility to insure that these requirements, as well as any contained in the CDOT specifications, project special provisions, and CDOT Survey Manual are fulfilled under this contract.
- 8). The minimum staking intervals for each item are described on the plans or in the CDOT Survey Manual. If the contractor wishes to reduce the minimum intervals, a Contract Madification Order must be negotiated and the cost of the item reduced accordingly.

Michael D. Heimbuck PLS 17488

Plot/Edited By: 054\PCD\ 1486 2004 07:50 Dote: 27 OCT

DOT Region 1 18500 E. Colfax Avenue Auroro, CO 80011 Phone: (303) 757–9744 FAX: (303) 757–9746

Survey Unit: Joseph Conway

	Sheet Revisions	
/уу	XXXXX	XXX

INTERSTATE 70 MP 180.0 to MP 196.0

SITUATE IN THE WHITE RIVER NATIONAL FOREST IN THE COUNTY OF SUMMIT AND THE COUNTY OF EAGLE, STATE OF COLORADO.

Project Control Diagram Monumentation Sheet Project Number: STA R100-104 Project Location: INTERSTATE 70 - VAIL PASS Project Location: MILEPOST 180 TO MILEPOST 196 Project Code: Lost Mod. Date Subset Sheets Sheet No. Total No. of She 14861 10-27-04 XXX of XXX 2 14

> mountain surveying & Mapping, inc. 8751 E. HAMPDEN AVE. SUITE B-1 DENVER, COLORADO 80231 (303) 306-1858

GEODETIC COORDINATE SUMMARY TABLE (ADJUSTED FIELD DATA)

		(AD0031LD					
DOINT NAME	GEODETIC COORDINATE	S NAD-83(92) (CHARN)	ELLIP.	MAPPING	COALE	NAD 83(92)	ZONE 0502
POINT NAME	LATITUDE(N)	LONGITUDE(W)	(NAVD88)m	ANGLE	SCALE	NORTHING (m)	EASTING (m)
POINT NAME I-70 CM-MP 180.00 I-70 CM-MP 180.30 I-70 CM-MP 180.60 I-70 CM-MP 180.70 I-70 CM-MP 180.90 I-70 CM-MP 181.20 I-70 CM-MP 181.20 I-70 CM-MP 181.70 I-70 CM-MP 181.90 I-70 CM-MP 182.20 I-70 CM-MP 182.20 I-70 CM-MP 182.40 I-70 CM-MP 182.40 I-70 CM-MP 182.50 I-70 CM-MP 183.30 I-70 CM-MP 183.30 I-70 CM-MP 183.30 I-70 CM-MP 183.50 I-70 CM-MP 183.70 I-70 CM-MP 184.10 I-70 CM-MP 184.10 I-70 CM-MP 184.10 I-70 CM-MP 184.50 I-70 CM-MP 184.50 I-70 CM-MP 184.70 I-70 CM-MP 185.00	LATITUDE(N) 39° 38′ 36.98336″ N 39° 38′ 24.11894″ N 39° 38′ 18.35358″ N 39° 38′ 12.08107″ N 39° 38′ 12.08107″ N 39° 37′ 54.92789″ N 39° 37′ 47.36386″ N 39° 37′ 42.62646″ N 39° 37′ 31.75849″ N 39° 37′ 10.58319″ N 39° 37′ 10.58319″ N 39° 37′ 10.58319″ N 39° 37′ 10.58319″ N 39° 36′ 52.01765″ N 39° 36′ 41.90301″ N 39° 36′ 31.58792″ N 39° 36′ 31.58792″ N 39° 36′ 11.46503″ N 39° 36′ 11.46503″ N 39° 36′ 11.46503″ N 39° 35′ 41.28130″ N 39° 35′ 42.70883″ N 39° 35′ 41.28130″ N 39° 35′ 40.47255″ N 39° 35′ 34.22923″ N 39° 35′ 34.22923″ N	LONGITUDE(W) 106 18' 17.62556" W 106 18' 00.07262" W 106 17' 48.80407" W 106 17' 42.08819" W 106 17' 30.98158" W 106 17' 18.60960" W 106 17' 18.60960" W 106 16' 48.32521" W 106 16' 44.76010" W 106 16' 44.76010" W 106 16' 45.19225" W 106 16' 45.19225" W 106 16' 45.19225" W 106 16' 37.36001" W 106 16' 37.36001" W 106 16' 37.36001" W 106 16' 37.386001" W 106 16' 37.386001" W 106 16' 37.386001" W 106 16' 40.63024" W 106 16' 37.386001" W 106 16' 37.386001" W 106 16' 37.386001" W 106 16' 37.386001" W 106 16' 38.2846" W 106 16' 38.3846" W 106 16' 39.38480" W 106 16' 39.384880" W 106 16' 39.38480" W 106 15' 30.82465" W 106 15' 31.3301" W 106 15' 31.3301" W 106 15' 31.71330" W 106 14' 51.71330" W 106 14' 51.71330" W 106 14' 40.40585" W	2550 . 723 2586 . 230 2596 . 886 2598 . 430 2587 . 487 2596 . 943 2602 . 783 2622 . 432 2638 . 234 2651 . 057 2675 . 415 2696 . 472 2711 . 302 2718 . 836 2738 . 806 2757 . 984 2772 . 036 2783 . 835 2798 . 059 2801 . 428 2802 . 047 2813 . 434 2837 . 234 2837 . 234 2863 . 088 2889 . 185 2915 . 559	-0' 30' 27.50218" -0' 30' 16.43172" -0' 30' 09.32477" -0' 30' 05.08913" -0' 29' 58.08431" -0' 29' 50.28142" -0' 29' 41.99110" -0' 29' 31.18138" -0' 29' 25.87715" -0' 29' 27.15299" -0' 29' 28.93290" -0' 29' 29.92204" -0' 29' 29.92204" -0' 29' 29.20545" -0' 29' 24.26574" -0' 29' 24.26574" -0' 29' 31.37970" -0' 29' 18.10306" -0' 29' 14.20723" -0' 29' 09.90548" -0' 29' 03.47382" -0' 28' 54.91638" -0' 28' 36.12647" -0' 28' 36.12647" -0' 28' 36.20777" -0' 28' 17.63547" -0' 28' 17.63547"	SCALE 0.999980685 0.999980096 0.999979834 0.999979549 0.999978436 0.999978424 0.99997741 0.999977298 0.999976807 0.999975558 0.99997558	NORTHING (m) 506065 .426 505665 .000 505484 .840 505289 .997 505041 .446 504756 .128 504520 .145 504370 .527 504033 .648 503725 .095 503381 .611 503083 .090 502809 .156 502496 .298 502177 .523 501865 .643 501554 .964 501289 .580 501046 .511 500821 .672 500660 .728 500613 .821 500608 .418 500582 .704 500387 .491 500067 .727	EASTING (m) 845314.899 845729.902 845997.021 846155.460 846418.143 846710.700 847022.137 847429.604 847627.294 847576.403 847506.147 847466.177 847490.929 847597.070 847672.354 847778.854 847790.149 848045.261 848205.930 848447.340 848769.724 849113.057 849480.146 849855.178 850177.881
I-70 CM-MP 185.70 I-70 CM-MP 185.90 I-70 CM-MP 186.00 I-70 CM-MP 186.20 I-70 CM-MP 186.50 I-70 CM-MP 186.70 I-70 CM-MP 186.90 I-70 CM-MP 187.00 I-70 CM-MP 187.00 I-70 CM-MP 187.40 I-70 CM-MP 187.80 I-70 CM-MP 187.80 I-70 CM-MP 187.90 I-70 CM-MP 188.20 I-70 CM-MP 188.20 I-70 CM-MP 188.50 I-70 CM-MP 188.50 I-70 CM-MP 188.70 I-70 CM-MP 188.70 I-70 CM-MP 188.90	39° 35′ 12.17134″ N 39° 35′ 00.87911″ N 39° 34′ 52.54633″ N 39° 34′ 41.62770″ N 39° 34′ 31.74107″ N 39° 34′ 15.61568″ N 39° 34′ 15.61568″ N 39° 33′ 59.06528″ N 39° 33′ 49.31047″ N 39° 33′ 49.31047″ N 39° 33′ 31.72002″ N 39° 33′ 31.72002″ N 39° 33′ 18.57349″ N 39° 33′ 18.57349″ N 39° 33′ 58.89789″ N 39° 32′ 58.89789″ N 39° 32′ 50.51322″ N	106 14 45.42687" W 106 14 49.66270" W 106 14 55.48381" W 106 14 58.32279" W 106 14 52.43771" W 106 14 43.38236" W 106 14 43.38236" W 106 14 43.346672" W 106 14 77.29937" W 106 14 77.55483" W 106 14 01.53808" W 106 13 55.91370" W 106 13 47.92756" W 106 13 38.67750" W 106 13 28.18964" W 106 13 19.74475" W 106 13 11.66294" W	2941 . 477 2969 . 592 2990 . 960 3008 . 035 3024 . 245 3039 . 007 3056 . 573 3075 . 892 3098 . 146 3113 . 549 3133 . 658 3150 . 028 3159 . 945 3160 . 228 3177 . 776 3181 . 408 3194 . 568	-0' 28' 13.67068" -0' 28' 16.34217" -0' 28' 20.01348" -0' 28' 21.80400" -0' 28' 18.09234" -0' 28' 12.38122" -0' 28' 00.68678" -0' 27' 55.93096" -0' 27' 49.78518" -0' 27' 45.99048" -0' 27' 42.44324" -0' 27' 37.40647" -0' 27' 31.57255" -0' 27' 24.95796" -0' 27' 19.63186" -0' 27' 14.53475"	0.999971777 0.999971315 0.999970976 0.999970136 0.999969820 0.999969492 0.999969171 0.999968838 0.999968455 0.999968414 0.999967770 0.999967263 0.99996630 0.999966513 0.999966195	499706.018 499358.609 499102.780 498766.622 498460.573 498215.068 497959.573 497708.303 497446.035 497143.323 496873.018 496598.613 496463.970 496189.888 495838.298 495579.514 495319.412	850322.285 850218.348 850077.324 850006.799 850144.732 850358.840 850593.414 850593.414 8505975.129 851205.280 851346.721 851478.772 851668.339 851886.970 852134.550 852334.113 852525.009

PROJECT COORDINATE SUMMARY TABLE (ADJUSTED FIELD DATA)

POINT NAME		PROJECT	COORDINATES	C1 C1/(4+)	_	ECODIDITION
		NORTH (ft)	EAST (ft)	ELEV(ft)	DESCRIPTION	
-70	CM-MP 180.00	1333053.58	2118541.32	8409.55	SET	CDOT TYPE II
-70	CM-MP 180.30	1331739.20	2119903.55	8525.72	SET	CDOT TYPE II
-70	CM-MP 180.60	1331147.83	2120780.35	8560.98	SET	CDOT TYPE II
-70	CM-MP 180.70	1330508.27	2121300.42	8565.72	SET	CDOT TYPE II
-70	CM-MP 180.90	1329692.41	2122162.67	8530.12	SET	CDOT TYPE II
-70	CM-MP 181.20	1328755.86	2123122.97	8560.81	SET	CDOT TYPE II
-70	CM-MP 181.40	1327981.26	2124145.25	8580.28	SET	CDOT TYPE II
-70	CM-MP 181.70	1327490.15	2125482.74	8644.41	SET	CDOT TYPE
-70	CM-MP 181.90	1326384.36	2126131.65	8696.60	SET	CDOT TYPE 11
-70	CM-MP 182.20	1325371.55	2125964.60	8738.69	SET	CDOT TYPE 11
-70	CM-MP 182.40	1324244.07	2125733.99	8818.31	SET	CDOT TYPE II
-70	CM-MP 182.60	1323264.19	2125602.79	8887.72	SET	CDOT TYPE II
-70	CM-MP 182.70	1322365.02	2125684.04	8936.04	SET	CDOT TYPE II
-70	CM-MP 182.90	1321338.07	2126032.44	8961.06	SET	CDOT TYPE !!
-70	CM-MP 183.10	1320291.71	2126279.56	9026.29	SET	CDOT TYPE II
-70	CM-MP 183.30	1319267.98	2126629.14	9089.53	SET	CDOT TYPE !!
-70	CM-MP 183.50	1318248.19	2127027.28	9135.34	SET	CDOT TYPE II
-70	CM-MP 183.70	1317377.08	2127503.61	9174.35	SET	CDOT TYPE II
-70	CM-MP 183.90	1316579.21	2128030.99	9220.69	SET	CDOT TYPE II
-70	CM-MP 184.10	1315841.19	2128823.41	9232.05	SET	CDOT TYPE II
-70	CM-MP 184.30	1315312.90	2129881.62	9233.75	SET	CDOT TYPE
-70	CM-MP 184.50	1315158.93	2131008.60	9271.43	SET	CDOT TYPE II
-70	CM-MP 184.70	1315141.19	2132213.55	9349.23	SET	CDOT TYPE II
-70	CM-MP 185.00	1315056.79	2133444.58	9434.38	SET	CDOT TYPE II
-70	CM-MP 185.20	1314416.01	2134503.83	9519.68	SET	CDOT TYPE II
-70	CM-MP 185.40	1313366.40	2135380.86	9606.52	SET	CDOT TYPE II
-70	CM-MP 185.70	1312179.10	2134977.84	9691.26	SET	CDOT TYPE II
-70	CM-MP 185.90	1311038.75	2134636.67	9783.84	SET	CDOT TYPE II
-70	CM-MP 186.00	1310199.00	2134173.76	9853.63	SET	CDOT TYPE II
-70	CM-MP 186.20	1309095.58	2133942.27	9909.96	SET	CDOT TYPE II
-70	CM-MP 186.50	1308090.99	2134395.02	9962.83	SET	CDOT TYPE II
-70	CM-MP 186.70	1307285.13	2135097.83	10011.57	SET	CDOT TYPE II
-70	CM-MP 186.90	1306446.48	2135867.80	10068.89	SET	CDOT TYPE II
-70 -70	CM-MP 187.00	1305621.70	2136536.96	10132.58	SET	CDOT TYPE II
- 70	CM-MP 187.20	1304760.81	2137120.77	10205.31	SET	CDOT TYPE II
-70 -70	CM-MP 187.20	1303767.18	2137876.23	10256.15	SET	CDOT TYPE II
-70 -70	CM-MP 187.60	1302879.91	2138340.50	10321.82	SET	CDOT TYPE II
-70 -70	CM-MP 187.80	1301979.19	2138340.30	10375.87	SET	CDOT TYPE II
-70 -70	CM-MP 187.90	1301575.15	2139396.20	10408.10	SET	CDOT TYPE II
-70 -70	CM-MP 188.20	1300637.57	2139396.20	10409.03	SET	CDOT TYPE II
-70 -70	CM-MP 188.50	1299483.49	2140113.84	10466.60	SET	CDOT TYPE II
-70 -70	CM-MP 188.70	1298634.04	2140926.51	10478.52	SET	CDOT TYPE II
-70 -70	CM-MP 188.90	1297780.27	2141361.37	10521.70	SET	CDOT TYPE II

PROJECT COORDINATE CONVERSION PARAMETERS

Project Latitude: Project Longitude: Project Elevation:

State Plane Zone:

39'34'16.95715" 106 14 23 . 78035" 2955.1258m Colorado Central 0.9999695454

Scale Factor: Combined Scale Factor: Northing Reduction:

0.9995060071 100000 200000

Easting Reduction: Units are METERS.

DOT Region 1 18500 E. Colfax Avenue Aurora, CO 80011 Phane: (303) 757–9744 FAX: (303) 757–9746

Survey Unit: Joseph Conway

	Sheet Revisions	
у	XXXXX	XXX
_		

INTERSTATE 70 MP 180.0 to MP 196.0

SITUATE IN THE WHITE RIVER NATIONAL FOREST IN THE COUNTY OF SUMMIT AND THE COUNTY OF EAGLE, STATE OF COLORADO. Project Control Diagram

Monumentation Sheet

Project Number: STA R100-104 Project Location: INTERSTATE 70 - VAIL PASS

Project Location: MILEPOST 180 TO MILEPOST 196
 Project Code:
 Lost Mod. Date
 Subset Sheets
 Sheet No.
 Total No. of Sheets

 14861
 10-27-04
 XXX of XXX
 3
 14

 Prepared By:

mountain surveying s Mapping, inc. 8751 E. HAMPDEN AVE. SUITE B-1 DENVER, COLORADO 80231 (303) 306-1858

GEODETIC COORDINATE SUMMARY TABLE (ADJUSTED FIELD DATA)

	INIT NIANAE	GEODETIC COORDINATES	5 NAD-83(92) (CHARN)	ELLIP.	MAPPING	SCALE	NAD 83(92)	ZONE 0502
'	INT NAME	LATITUDE(N)	LONGITUDE(W)	(NAVD88)m	ANGLE	SCALE	NORTHING (m)	EASTING (m)
1-70	CM-MP 189.10	39° 32' 40.55422" N	106' 13' 08.51097" W	3215.687	-0° 27' 12.54683"	0.999965821	495011.695	852597.831
1-70	CM-MP 189.20	39° 32′ 34.13551" N	106° 13° 02.05422" W	3232.317	-0° 27' 08.47463"	0.999965580	494812.533	852750.428
1-70	CM-MP 189.40	39° 32° 25.17198″ N	106° 12′ 54.92734" W	3245.911	-0° 27' 03.97978"	0.999965247	494534.770	852918.416
1-70	CM-MP 189.60	39° 32′ 15.01804" N	106° 12' 51.94728" W	3233.984	-0° 27° 02 10029"	0.999964871	494221.078	852987.109
1-70	CM-MP 189.80	39° 32' 02.88219" N	106° 12′ 54.33493" W	3216.760	-0° 27' 03.60615"	0.999964425	493847.276	852927.150
1-70	CM-MP 190.00	39° 31° 51.18273" N	106° 12′ 56.16997" W	3218.808	-0° 27' 04.76349"	0.999963998	493486 . 828	852880.489
1-70	CM-1	39° 31° 40.17922" N	106° 13° 05.70582" W	3211.724	-0° 27' 10.77766"	0.999963599	493149.295	852650.086
1-70	CM-2	39° 31' 38.04352" N	106° 13′ 06.03398" W	3209.529	-0° 27' 10.98462"	0.999963522	493083.496	852641.728
NSRS	VAIL PASS	39° 31° 44.04349″ N	106° 13' 03.17196" W	3221.780	-0° 27' 09.17957"	0.999963739	493267.985	852711.539
NSRS	HE I D	39° 30' 06.31578" N	106° 08' 25.72693" W	2951.220	-0° 24° 14.19789"	0.999960317	490204.692	859316.007
NSRS	R 448	39° 30° 36.41211″ N	106°08°30.93025" W		-0° 24' 17.47957"	0.999961347	491133.690	859198.256
NSRS	Q 448	39° 30′ 09.87897" N	106° 09' 10.47344" W		-0' 24' 42.41905"	0.999960437	490322.184	858247.782
NSRS	J 448	39° 30° 00.50644" N	106° 09° 47.50562" W		-0° 25' 05.77486"	0.999960120	490039.560	857360.970
NSRS	G 448	39° 30' 08.51167" N	106° 10' 16.92428" W		-0' 25' 24.32890"	0.999960391	490291.590	856659.954
NSRS	H 448	39° 30′ 14.48281″ N	106° 10′ 44.93767" W	3025.358	-0° 25' 41.99665"	0.999960594	490480.704	855992.085
NSRS	DD-VP 13.0	39° 30° 16.47408" N	106° 10′ 49.97667" W	3028.923	-0° 25′ 45.17470"	0.999960662	490543.012	855872.165
NSRS	L 448	39° 30' 35.10636" N	106° 12' 09.04062" W		-0° 26' 35.03950"	0.999961301	491131.976	853987.817
NSRS	M 448	39° 30′ 50.44423" N	106° 12' 19.98298" W		-0° 26° 41.94074"	0.999961834	491606.995	853730.103
NSRS	P 448	39° 31′ 30.08564″ N	106° 12′ 58.20441" W		-0° 27° 06.04659"	0.999963236	492836.612	852826 . 777
NSRS	MCLAURIN	39° 37° 30.43663″ N	106° 16' 37.48236" W	2657.700	-0° 29° 24.34291"	0.999977682	503992.387	847684.959
NSRS	WOODMAN	39° 37′ 11.80292" N	106' 28' 08.00530" W	2318.630	-0' 36' <u>39.84851"</u>	0.999976860	503576.002	<u>8312</u> 1 <u>1</u> .182

PROJECT COORDINATE SUMMARY TABLE (ADJUSTED FIELD DATA)

DOINT NAME		PROJECT COORDINATES		ELEV(ft)	DESCRIPTION		
	OINT NAME	NORTH (ft) EAST (ft)			DESCRIPTION		
1-70	CM-MP 189.10	1296770.20	2142447.21	10591.01	SET CDOT TYPE II		
1-70	CM-MP 189.20	1296116.46	2142948.11	10645.58	SET CDOT TYPE II		
1-70	CM-MP 189.40	1295204.72	2143499.52	10690.20	SET CDOT TYPE !!		
1-70	CM-MP 189.60	1294175.04	2143725.00	10651.05	SET CDOT TYPE !!		
1-70	CM-MP 189.80	1292948.05	2143528.19	10594.52	SET CDOT TYPE II		
1-70	CM-MP 190.00	1291764.90	2143375.02	10601.24	SET CDOT TYPE !!		
1-70	CM-1	1290656.96	2142618.74	10577.99	FOUND CDOT TYPE II		
1-70	CM-2	1290440.97	2142591.30	10570.79	FOUND CDOT TYPE !!		
NSRS	VAIL PASS	1291046.55	2142820.45	10611.00	FOUND NGS HORZ DISK		
NSRS	HE ID	1280991.43	2164499.32	9723.55	FOUND NGS 3-D ROD		
NSRS	R 448	1284040.83	2164112.81	9680.55	FOUND NGS VERT DISK		
NSRS	Q 448	1281377.09	2160992.92	9740.09	FOUND NGS VERT DISK		
NSRS	J 448	1280449.39	2158082.00	9812.60	FOUND NGS VERT DISK		
NSRS	G 448	1281276.67	2155780.95	9888.03	FOUND NGS VERT DISK		
NSRS	H 448	1281897.43	2153588.70	9966.75	FOUND NGS 3-D ROD		
NSRS	DD-VP 13.0	1282101.95	2153195.07	9978.45	FOUND SURVEY DISK		
NSRS	L 448 .	1284035.20	2147009.78	10248.06	FOUND NGS VERT DISK		
NSRS	M 448	1285594.43	2146163.84	10279.23	FOUND NGS VERT DISK		
NSRS	P 448	1289630.59	2143198.72	10509.69	FOUND NGS VERT DISK		
NSRS	MCL AUR IN	1326248.92	2126320.93	8759.50	FOUND NGS HORZ DISK		
NSRS	WOODMAN	1324882.15	2072246 . 50	7648.74	FOUND NGS HORZ DISK		

THE FOLLOWING POINTS WERE NOT INCLUDED IN THE GPS NETWORK. THEY WERE TIED IN AS SIDE SHOTS USING GPS FAST STATIC METHODS.

DOINT NAME	GEODETIC COORDINATES NAD-83(92) (CHARN)		ELLIP.	MAPPING	SCALE	NAD 83(92)	ZONE 0502
POINT NAME	LATITUDE(N)	LONGITUDE(W)	(NAVD88)m	ANGLE	SCALE	NORTHING (m)	EASTING (m)
NSRS K 448 NSRS N 448	39° 30′ 19.90279″ N 39° 31′ 09.56376″ N	106° 11′ 38.03610″ W 106° 12′ 47.54999″ W		-0° 26' 15.48528" -0° 26' 59.32696"	0.999960779 0.999962506	490657.433 492201.750	854724.860 853076.261

POINT NAME	PROJECT COORDINATES		ELEV(ft)	DESCRIPTION		
POINT NAME	NORTH (ft)	EAST (ft)		DESCRIPTION		
NSRS K 448 NSRS N 448	1282477.53 1287546.68	2149429.09 2144017.64	10102.78 10403.35	FOUND NGS VERT DISK FOUND NGS VERT DISK		

PROJECT COORDINATE CONVERSION PARAMETERS

Project Latitude: Project Longitude: Project Elevation: 39'34'16.95715" 106 14 23 . 78035" 2955.1258m

State Plane Zone: Scale Factor:

Colorado Central 0.9999695454

Combined Scale Factor: 0.9995060071 Northing Reduction:

Easting Reduction:

Units are METERS.

100000 200000

THE FOLLOWING POINTS WERE NOT INCLUDED IN THE GPS NETWORK. THEY WERE TIED IN AS SIDE SHOTS USING RTK-GPS METHODS.

POINT NAME		PROJECT COORDINATES		ELEV(ft)	DESCRIPTION	
		NORTH (ft)	EAST (ft)		DESCRIPTION	
I-70 CM-N	MP 185.27 MP 185.28 MP 185.51	1313692.54	2135237.63 2135079.68 2135206.53	9563.60 9544.47 9616.25	SET REBAR & CAP SET REBAR & CAP SET REBAR & CAP	

Phone: (303) 757-9744 FAX: (303) 757-9746

Survey Unit: Joseph Conway

	Sheet Revisions	
m/yy	XXXXX	XXX

INTERSTATE 70 MP 180.0 to MP 196.0

SITUATE IN THE WHITE RIVER NATIONAL FOREST IN THE COUNTY OF SUMMIT AND THE COUNTY OF EAGLE, STATE OF COLORADO.



Project Control Diagram Plan Sheet

Project Number: STA R100-104 Project Locotion: INTERSTATE 70 - VAIL PASS

mountain surveying mapping, inc. 8751 E. HAMPDEN AVE. SUITE B-1 DENVER, COLORADO 80231 (303) 306-1858

SET I-70 CM-MP 180.00 CDOT TYPE II N: 1333053.58 E: 2118541.32 EL:8409.55

SET I-70 CM-MP 180.60 CDOT TYPE II N: 1331147.83 E: 2120780.35

EL:8560.98

I-70 CM-MP 180.30 CDOT TYPE II N: 1331739.20 E: 2119903.55 EL:8525.72

I-70 CM-MP 180.70 CDOT TYPE II N: 1330508.27 E: 2121300.42 EL:8565.72

SET I-70 CM-MP 180.90 CDOT TYPE II N: 1329692.41 E: 2122162.67

EL:8530.12

DOT Region 1 18500 E. Colfax Avenue

Survey Unit: Joseph Conway

I-70 CM-MP 180.90

CDOT TYPE II

N: 1329692.41

E: 2122162.67

EL:8530.12

Aurora, CO 80011 Phone: (303) 757-9744 FAX: (303) 757-9746

	Sheet Revisions	
/уу	XXXXX	XXX

INTERSTATE 70 MP 180.0 to MP 196.0

SITUATE IN THE WHITE RIVER NATIONAL FOREST IN THE COUNTY OF SUMMIT AND THE COUNTY OF EAGLE, STATE OF COLORADO.



Project Control Diagram Plan Sheet Project Number: STA R100-104 Project Location: INTERSTATE 70 - VAIL PASS
 Project Lacatian:
 MILEPOST 180 TO MILEPOST 196

 Project Code:
 Lost Mod. Date
 Subset Sheets
 Sheet No. Totol No.

 14861
 10-27-04
 XXX of XXX
 5
 14

> mountain surveying Mapping, inc. 8751 E. HAMPDEN AVE. SUITE B-DENVER, COLORADO 80231 (303) 306-1858

SET

I-70 CM-MP 181.70

CDOT TYPE II N: 1327490.15 E: 2125482.74

EL:8644.41

MCLAURIN NGS HORZ DISK N: 1326248.92

FOUND

E: 2126320.93

EL:8759.50

EL:8696.60

SET

I-70 CM-MP 181.90

CDOT TYPE II N: 1326384.36 E: 2126131.65

SET

I-70 CM-MP 182.20

CDOT TYPE II N: 1325371.55

E: 2125964.60

EL:8738.69

= POND IDENTIFICATION SIGN

SET

I-70 CM-MP 181.20

CDOT TYPE II

N: 1328755.86 E: 2123122.97

EL:8560.81

I-70 CM-MP 181.40

CDOT TYPE II N: 1327981.26 E: 2124145.25

EL:8580.28


Survey Unit: Joseph Conway

DOT Region 1 18500 E. Colfax Avenue Aurora, CO 80011 | TRUMEPONTATION Phone: (303) 757-9744 FAX: (303) 757-9746

	Sheet Revisions	
n/yy	XXXXX	XXX
		 _
		 _
- 1		ı

INTERSTATE 70 MP 180.0 to MP 196.0

SITUATE IN THE WHITE RIVER NATIONAL FOREST IN THE COUNTY OF SUMMIT AND THE COUNTY OF EAGLE, STATE OF COLORADO.

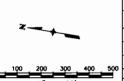

Project Control Diagram Plan Sheet

Project Number: STA R100-104 Project Location: INTERSTATE 70 - VAIL PASS

 Project Location:
 MILEPOST 180 TO MILEPOST 196

 Project Code:
 Last Mod. Date
 Subset Sheets
 Sheet No. Total No.

 14861
 10-27-04
 XXX of XXX
 6
 14

mountain surveying & Mapping, inc.

8751 E. HAMPDEN AVE. SUITE B-1 DENVER, COLORADO 80231 (303) 306-1858

SET

I-70 CM-MP 182.20

CDOT TYPE II

N: 1325371.55 E: 2125964.60 EL:8738.69

I-70 CM-MP 182.40

.50

CDOT TYPE II N: 1324244.07

E: 2125733.99

EL:8818.31

SET

SET

I-70 CM-MP 182.60

CDOT TYPE II

N: 1323264.19 E: 2125602.79

EL:8887.72

SET

I-70 CM-MP 182.70

CDOT TYPE II N: 1322365.02 E: 2125684.04

SET

I-70 CM-MP 182.90

CDOT TYPE II N: 1321338.07

E: 2126032.44 EL:8961.06

.94

.93

SET

I-70 CM-MP 183.10 CDOT TYPE II

N: 1320291.71

E: 2126279.56 EL:9026.29

EL:8936.04


DOT Region 1 18500 E. Colfax Avenue Aurora, CO 80011 Phone: (303) 757–9744 FAX: (303) 757–9746

Survey Unit: Joseph Conway

	Sheet Revisions	
mm/yy	XXXXX	XX

INTERSTATE 70 MP 180.0 to MP 196.0

SITUATE IN THE WHITE RIVER NATIONAL FOREST IN THE COUNTY OF SUMMIT AND THE COUNTY OF EAGLE, STATE OF COLORADO.

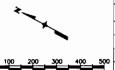

Project Control Diagram

Plan Sheet

Project Number: STA R100-104 Project Location: INTERSTATE 70 - VAIL PASS

Project Location: MILEPOST 180 TO MILEPOST 196

SET

CDOT TYPE II

N: 1315841.19

E: 2128823.41

EL:9232.05

I-70 CM-MP 184.10

MAPPING, INC.

8751 E. HAMPDEN AVE. SUITE B-1 DENVER, COLORADO 80231 (303) 306-1858

SET

I-70 CM-MP 183.10

CDOT TYPE II N: 1320291.71

E: 2126279.56

EL:9026.29

SET

I-70 CM-MP 183.30

CDOT TYPE II

N: 1319267.98 E: 2126629.14

EL:9089.53

SET

I-70 CM-MP 183.50

CDOT TYPE II N: 1318248.19

E: 2127027.28

EL:9135.34

8 3 .62

SET

I-70 CM-MP 183.70

CDOT TYPE II N: 1317377.08 E: 2127503.61 EL:9174.35

SET

I-70 CM-MP 183.90

CDOT TYPE II N: 1316579.21 E: 2128030.99

EL:9220.69

CDOT Form

Survey Unit: Joseph Conway

COLORADO DEPARTMENT OF TRANSPORTATION

Sheet Revisions

PARTMENT OF TRANSPORTATION

Sheet Revisions

| Minimum | Min

XXXXX XXX

INTERSTATE 70 MP 180.0 to MP 196.0

SITUATE IN THE WHITE RIVER NATIONAL FOREST
IN THE COUNTY OF SUMMIT AND THE COUNTY OF EAGLE,
STATE OF COLORADO.

0 100 200 300 400 500

Project Control Diagram

Plan Sheet

Project Number: STA R100-104
Project Location: INTERSTATE 70 - VAIL PASS

 Project Location:
 MILEPOST 180 TO MILEPOST 196

 Project Code:
 Last Mod. Date
 Subset Sheets
 Sheet No. Totol No. of 14861
 10-27-04
 XXX of XXX
 8
 14

MS MO


MAPPING, INC.
51 E. HAMPDEN AVE. SUITE B

8751 E. HAMPDEN AVE. SUITE B-DENVER, COLORADO 80231 (303) 306-1858

SET I-70 CM-MP 184.10 CDOT TYPE II N: 1315841.19 E: 2128823.41 EL:9232.05

SET
I-70 CM-MP 184.30
CDOT TYPE II

N: 1315312.90 E: 2129881.62 EL:9233.75

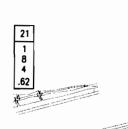

SET I-70 CM-MP 184.50 CDOT TYPE II

N: 1315158.93 E: 2131008.60 EL:9271.43



SET
I-70 CM-MP 184.70
CDOT TYPE II

N: 1315141.19 E: 2132213.55 EL:9349.23 SET I-70 CM-MP 185.00


CDOT TYPE II

N: 1315056.79 20 E: 2133444.58 1 8

EL:9434.38

NO S I G N

Projects/CDOT\04054\PCD\14861pcd.

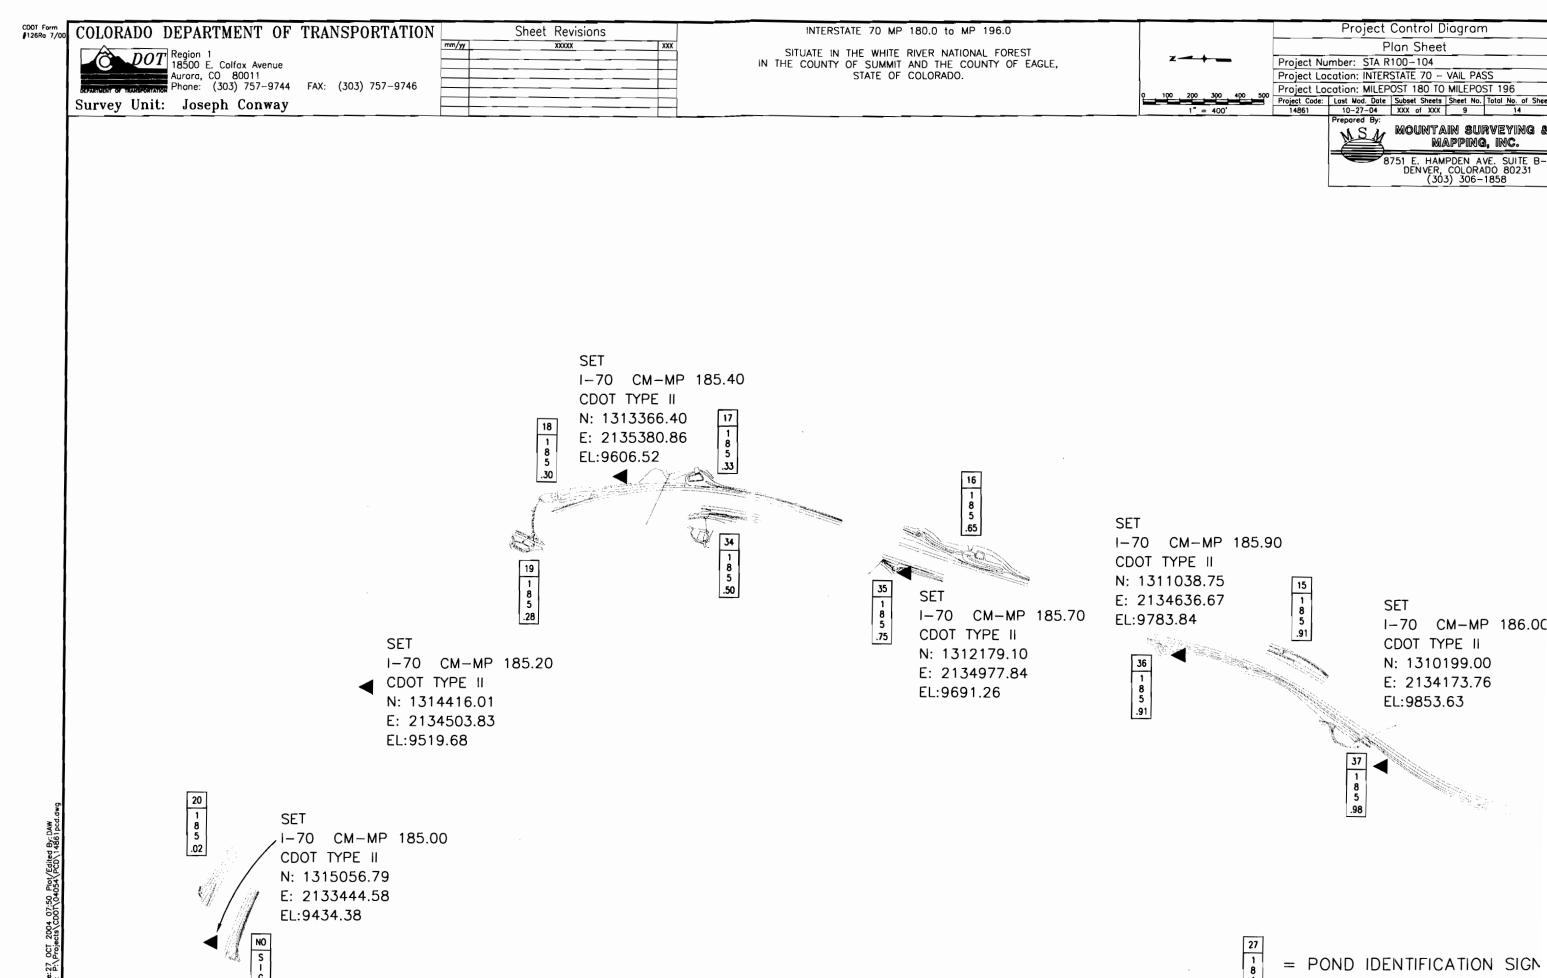

CDOT Form #126Ro 7/00	COLORADO	DEPARTMENT OF	TRANSPORTATION	Sheet Revisions	INTERST	TATE 70 MP 180.0 to MP 196	5.0		Pro	ject Control Diagram
				XXXXX	SITUATE IN	THE WHITE RIVER NATIONAL F	OREST	*	Decised Number	Plan Sheet
	C Spor	Region 1 18500 E. Colfox Avenue Aurora, CO 80011 Phone: (303) 757–9744			IN THE COUNTY	OF SUMMIT AND THE COUNTY STATE OF COLORADO.	OF EAGLE,		Project Number: Project Location:	INTERSTATE 70 - VAIL PASS
	DEPARTMENT OF TRANSPORTATION	Phone: (303) 757-9744	FAX: (303) 757-9746					0 100 200 300 400 50	Project Location:	MILEPOST 180 TO MILEPOST 196
	Survey Unit:	Joseph Conway						1" = 400'	14861 10-2 Prepore	d. Date Subset Sheets Sheet No. Total No. of 7-04 XXX of XXX 10 14 d Bv:
									M	
						•			-	
										8751 E. HAMPDEN AVE. SUITE DENVER, COLORADO 8023 (303) 306-1858
	1									
	15									
	15									
	8 5									
	.91									
		SET								
	1 11111	I-70 CM-MP 18	16.00							
	W. 111271	CDOT TYPE II								
	1000	N: 1310199.00								
		E: 2134173.76							13	12 11
	5	EL:9853.63					SET		8	1 8
	.98						I-70 CM-MP	186 90	.95	.00
	11						CDOT TYPE II	700.50		
							N: 1306446.48	your and we want of	The state of the s	The state of the s
							E: 2135867.80	mercular a service of the service of	100	F .
							EL:10068.89			1.20
			SET			SET	•		30	SET
			I-70 CM-MP 18	86.20		I-70 CM-MP 186.	.70		8 6	I-70 CM-MP 187.0
			CDOT TYPE II	SET SET	_	CDOT TYPE II			.99	CDOT TYPE II
9			N: 1309095.58		CM-MP 186.50	N: 1307285.13				N: 1305621.70
* cd.d*			E: 2133942.27	CDOT TY	PE II	E: 2135097.83				E: 2136536.96 EL:10132.58
9y: DA 861pc			EL:9909.96	N: 1308		EL:10011.57				EL:10132.56
Sited E				E: 2134	395.02					
lot/Ec				EL:9962	.83					
.50 P										
004 07:50 Plot/Edited s\cDoT\04054\PCD\1										
8/8										

= POND IDENTIFICATION SIGN

COLORADO DEPARTMENT OF TRANSPORTATION Plan Sheet SITUATE IN THE WHITE RIVER NATIONAL FOREST IN THE COUNTY OF SUMMIT AND THE COUNTY OF EAGLE, ### POOT Region 1 18500 E. Colfax Avenue Aurora, CO 80011 Phone: (303) 757-9744 FAX: (303) 757-9746 Project Number: STA R100-104 Project Location: INTERSTATE 70 - VAIL PASS STATE OF COLORADO. Project Location: MILEPOST 180 TO MILEPOST 196
 Project Code:
 Last Mod. Date
 Subset Sheets
 Sheet No.
 Total No. of

 14861
 10-27-04
 XXX of XXX
 11
 14
 Survey Unit: Joseph Conway mountain surveying & mapping, inc. 8751 E. HAMPDEN AVE. SUITE B-1 DENVER, COLORADO 80231 (303) 306-1858 SET I-70 CM-MP 187.40 SET CDOT TYPE II I-70 CM-MP 187.20 N: 1303767.18 CDOT TYPE II E: 2137876.23 10 N: 1304760.81 EL:10256.15 .00 .07 E: 2137120.77 .13 EL:10205.31 I-70 CM-MP 187.90 9 CDOT TYPE II SET N: 1301537.23 Comment of the same I-70 CM-MP 187.60 .34 E: 2139396.20 40 SET CDOT TYPE II EL:10408.10 I-70 CM-MP 187.00 I-70 CM-MP 187.80 N: 1302879.91 CDOT TYPE II CDOT TYPE II .23 E: 2138340.50 N: 1305621.70 N: 1301979.19 EL:10321.82 E: 2136536.96 E: 2138773.95 EL:10132.58 EL: 10375.87 = POND IDENTIFICATION SIGN

Sheet Revisions

INTERSTATE 70 MP 180.0 to MP 196.0

Project Control Diagram

					_			
CDOT Form #126Ra 7/00	COLORADO DEPARTMENT OF	TRANSPORTATION		Sheet Revisions		INTERSTATE 70 MP 180.0 to MP 196.0		Project Control Diagram
	Region 1		mm/yy	XXXXX XXX	1	SITUATE IN THE WHITE RIVER NATIONAL FOREST	*•	Plan Sheet
	18500 E. Colfax Avenue				_	IN THE COUNTY OF SUMMIT AND THE COUNTY OF EAGLE,	*	Project Number: STA R100-104
	Aurora, CO 80011	54V (707) 757 0746		-	_	STATE OF COLORADO.		Project Location: INTERSTATE 70 - VAIL PASS
	DEPARTMENT OF TRANSPORTATION Phone: (303) 757-9744	FAX: (303) /5/-9/46			•		0 100 200 300 400 50	Project Location: MILEPOST 180 TO MILEPOST
	Survey Unit: Joseph Conway]			Project Code: Lost Mod. Date Subset Sheets Sheet No. To

E: 2140926.51

EL:10466.60



8751 E. HAMPDEN AVE. SUITE B-1 DENVER, COLORADO 80231 (303) 306-1858

SET I-70 CM-MP 188.20 CDOT TYPE II N: 1300637.57 E: 2140113.84 EL:10409.03 SET I-70 CM-MP 188.50 NO S I G N CDOT TYPE II N: 1299483.49

1 1 8 8 8 8 .73 .73 SET I-70 CM-MP 188.70

CDOT TYPE II N: 1298634.04 E: 2141581.57 EL:10478.52

SET I-70 CM-MP 188.90 CDOT TYPE II N: 1297780.27 E: 2142208.18 EL:10521.70

NO S I

SET I-70 CM-MP 189.10 CDOT TYPE II

N: 1296770.20 E: 2142447.21 EL:10591.01

▼ _{SET}

I-70 CM-MP 187.90

CDOT TYPE II

N: 1301537.23

E: 2139396.20

EL:10408.10

Survey Unit: Joseph Conway

SET


DOT Region 1 18500 E. Colfax Avenue

Aurora, CO 80011 Phone: (303) 757–9744 FAX: (303) 757–9746

	Sheet Revisions	
1	XXXXX	XX

INTERSTATE 70 MP 180.0 to MP 196.0

SITUATE IN THE WHITE RIVER NATIONAL FOREST
IN THE COUNTY OF SUMMIT AND THE COUNTY OF EAGLE,
STATE OF COLORADO.

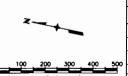

Project Control Diagram

Plan Sheet

Project Number: STA R100-104 Project Location: INTERSTATE 70 - VAIL PASS

Project Location: MILEPOST 180 TO MILEPOST 196 Project Code: Lost Mod. Date Subset Sheets Sheet No. Total No. of 9

14861 10-27-04 XXX of XXX 13 14

Prepared By:

mountain surveying Mapping, inc.

8751 E. HAMPDEN AVE. SUITE B-DENVER, COLORADO 80231 (303) 306-1858

.09 I-70 CM-MP 188.90 CDOT TYPE II SET N: 1297780.27 I-70 CM-MP 189.20 E: 2142208.18 CDOT TYPE II EL:10521.70 N: 1296116.46 E: 2142948.11 **SET** EL:10645.58 I-70 CM-MP 189.10 CDOT TYPE II N: 1296770.20 E: 2142447.21

EL:10591.01

SET I-70 CM-MP 189.40 CDOT TYPE II N: 1295204.72 E: 2143499.52 EL:10690.20

CDOT TYPE II N: 1294175.04 E: 2143725.00 EL: 10651.05

i-70 CM-MP 189.60

SET

SET I-70 CM-MP 189.80

CDOT TYPE II N: 1292948.05 E: 2143528.19

EL:10594.52

	_
CDOT Form # 126Ra 7/00	
COO! FOR!	
#126Pa 7/00	

DOT Region 1 18500 E. Colfox Avenue


Survey Unit: Joseph Conway

Aurora, CO 80011 Phone: (303) 757–9744 FAX: (303) 757–9746

	Sheet Revisions	
y	XXXXX	XXX
-1	·	

INTERSTATE 70 MP 180.0 to MP 196.0

SITUATE IN THE WHITE RIVER NATIONAL FOREST IN THE COUNTY OF SUMMIT AND THE COUNTY OF EAGLE, STATE OF COLORADO.

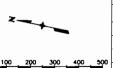

Project Control Diagram

Plan Sheet

Project Number: STA R100-104 Project Location: INTERSTATE 70 - VAIL PASS

Project Location: MILEPOST 180 TO MILEPOST 196

 Project Code:
 Lost Mod. Date
 Subset Sheets
 Sheet No.
 Total No. of Sheets

 14861
 10-27-04
 XXX of XXX
 14
 14

Mapping, inc.

8751 E. HAMPDEN AVE. SUITE B-1 DENVER, COLORADO 80231 (303) 306-1858

SET

I-70 CM-MP 189.80

CDOT TYPE II N: 1292948.05 E: 2143528.19 EL: 10594.52

I-70 CM-MP 190.00

CDOT TYPE II N: 1291764.90

E: 2143375.02 EL:10601.24

FOUND

VAIL PASS

NGS HORZ DISK N: 1291046.55

E: 2142820.45

EL:10611.00

FOUND

I-70 CM-2 CDOT TYPE II MON.

N: 1290440.97 E: 2142591.30

EL:10570.79

FOUND

I - 70 CM - 1

CDOT TYPE II MON.

N: 1290656.96

E: 2142618.74 EL: 10577.99

FOUND

P 448

NGS VERT DISK N: 1289630.59

E: 2143198.72

EL:10509.69

= POND IDENTIFICATION SIGN

FOUND N 448

NGS VERT DISK N: 1287546.68

E: 2144017.64 EL: 10403.35