Colorado Department of Transportation

18500 East Colfax Avenue Aurora, CO 80011 Phone: 303-365-7410 FAX: 303-365-7350

KAW Region 1

I		Sheet Revisions Sheet Revisions			Sheet Revisions			Sheet Revisions		Pr
ı	Date	Description	Initials	Date	Description	Initials	Date	Description	Initials	<u>.</u>
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Prepared By:	
URS	Pro
URS Corporation	Pro
8181 East Tufts Avenue	Pro
Denver, CO 80237	Pro
(303) 740-2600	

		Right o	of Way Plo	ıns	3			
	Title Sheet							
	Project Number: STA R100-140							
	Project Location: US6 & SH 119, CLEAR CREEK ROCKFALI Project Location: JEFFERSON & GILPIN COUNTIES							
	Project Code:	Last Mod. Date	Subset Sheets		Sheet No.			
	16521	08-11-08	1 of 1		1.01			

INDEX OF SHEETS

DEPARTMENT OF TRANSPORTATION STATE OF COLORADO

RIGHT OF WAY PLAN OF PROPOSED FEDERAL AID PROJECT NO. STA R100-140 US 6 & STATE HIGHWAY NO. 119 **JEFFERSON & GILPIN COUNTY RIGHT OF WAY**

> SCALES OF ORIGINAL 11x17 DRAWINGS PLAN SHEETS 1" = 100' OWNERSHIP MAP 1" = 200' R.O.W. LENGTH OF PROJECT = 0.20 Miles (Site 1) 0.10 Miles (Site 2)

1.01 (1) Title Sheet 2.01 (1) Tabulation of Properties

(13) Control Diagrams 4.01 (1) Monumentation Sheets

5.01 - 5.03 (3) Plan Sheets 6.01 - 6.02 (2) Ownership Sheets

SHEET NO.

M-100-1 (3) Standard Symbols M-629-1 (2) Survey Monuments

(26) Total Sheets

DATE


All Measurements Are In English Units Unless Otherwise Noted

BASIS OF BEARINGS: (Site 1)

Bearings shown herein are grid bearings based upon the Mountain Surveying and Mapping Inc. Control Diagram for the US Hwy 6 corridor to the CDOT. More particularly a line connecting the S 1/4 corner of Section 36, T. 3S., R. 72W., 6th P.M. (being a found 3-1/4" Brass Cap on pipe stamped: BLM S 1/4 Sec 36 1996), and the SE corner of Section 36, T. 3S., R. 72W., 6th P.M. (being a found of Section 36, T. 3S., R. 72W., 6th P.M. (being a found of Section 36, P. 3S.). 1.5' Vertical Stone in Mound of Stones) as Bearing S. 89° 56'31" E, a distance

BASIS OF BEARINGS: (Site 2)

Bearings shown herein are grid bearings based upon the Mountain Surveying and Mapping Section Corner Location Diagram which is also based on the Western States Survey Control Diagram for the SH 119 corridor to the CDOT. More particularly a line connecting the W 1/4 corner of Section 27, T. 3S., R. 72W., 6th P.M. (being a found 15"X9"X9" Stone w/ 1-1/2" Alum. Cap stamped: 1/4 28 27 865) and the NW corner of Section 27, T. 3S., R. 72W., 6th P.M. (being a found 12"X13"X8" Stone w/ 1-1/2" Alum. Cap stamped: 21, 22, 28, 27 865) as Bearing N. 00° 18'06" E., a distance of 2459.91 feet.

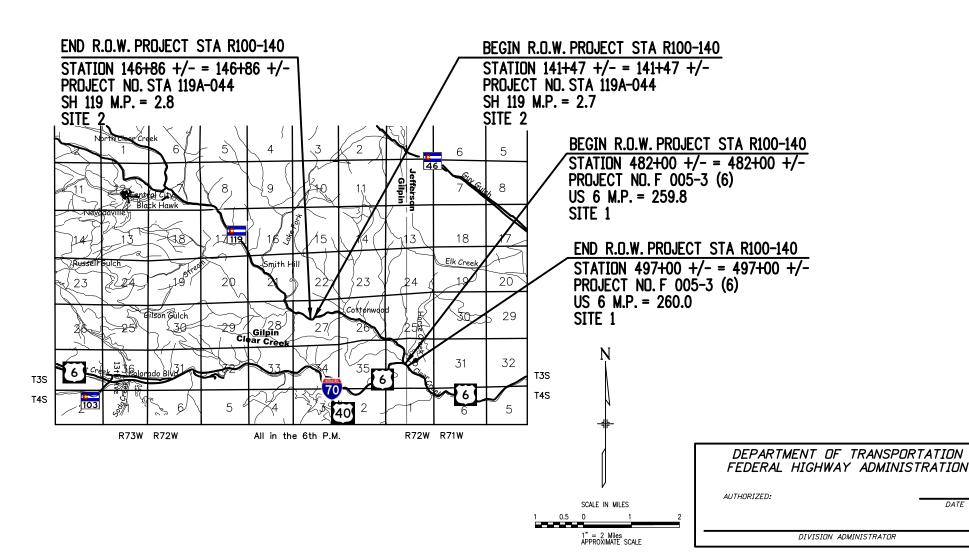

Colorado Department of Transportation

DOT	18500 East Colfax Avenue
	Aurora, CD 80011 Phone: 303-365-7410 FAX: 303-365-7350

Sheet Revisions			Sheet Revisions	
Description	Initials	Date	Description	Initials

Prepared By:	
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URS Corporation 8181 East Tufts Avenue	Р
Denver, CO 80237	Ρ

Sheet Revisions

Description

Right of Way Plans Tabulation of Properties

Project Number: STA R100-140

Project Location: US6 & SH 119, CLEAR CREEK ROCKFALL

Project Location: JEFFERSON & GILPIN COUNTIES

Region 1	ೄ Phone: 303-365-7410 FAX: 303-365 K	AW AW							818 D	1 East Tufts Avenue Denver, CO 80237 (303) 740—2600	Project Location: JEFFERSON & GILPIN COUNTIES Project Code: Last Mod. Date Subset Sheets Sheet No.
itogion i			<u> </u>	1		<u> </u>		`	<u> </u>	(303) /40-2600	16521 08-11-08 1 of 1 2.01
Parcel No.	Ownership Name & Address	Site Address	Location	Area In Squ		re Feet (sf)	/ Acres (ad	Ī	Book and Page No. And/Or	Intle	Remarks
	Simoronip name a xaaroo		200011011	Area Of Parcel	Existing ROW	Net Area	Remainder Left	Remainder Right	Reception No.	Commitment No.	iomarito
			SITE 1								
			JEFFERSON COUNTY								
PE-110	CLIFFORD W. DAVIS	1927 BADGER SPUR	S1/2 SECTION 36	137,614 sf		137,614 sf				NF0049	The purpose of this permanent easement is fo
	& CHRISTIANE J. DAVIS	GOLDEN, CO 80403	T. 3S., R. 72 W., 6th P.M.	3.159 ac		3.159 ac	22.60 ac +/	-			construction and maintenance of Rock Fall
	1049A COUNTY ROAD 4 EAST		LOTS 25 AND 26, DOUGLAS								Mitigation
	PRATTVILLE, AL 36067		MOUNTAIN RANCH FILING NO. 1								Total Remainder area per the Jefferson Count
											Assessor's Records
TE 110	(0)		05 444 0507700 00	104.0505		404.0505				(0 1)	
TE-110	(Same as above)	(Same as above)	SE 1/4 SECTION 36	194,658 sf		194,658 sf				(See above)	The purpose of this temporary easement is fo
			T. 3S., R. 72 W., 6th P.M.	4.469 ac		4.469 ac	(See above))			rock scaling and a construction work zone
			LOT 26, DOUGLAS MOUNTAIN								
			RANCH FILING NO. 1								
PE-111	JOHN M. EAGLETON	2084 DOUGLAS MOUNTAIN DR	S1/2 SECTION 36	2,085 sf		2,085 sf				NF0048	The purpose of this permanent easement is fo
	& SANDRA J. EAGLETON	GOLDEN, CO 80403	T. 3S., R. 72 W., 6th P.M.	0.048 ac		0.048 ac	8.40 ac +/-	-			construction and maintenance of Rock Fall
	2084 DOUGLAS MOUNTAIN DR		LOT 32, DOUGLAS MOUNTAIN								Mitigation
	GOLDEN, CO 80403		RANCH FILING NO. 1								Total Remainder area per the Jefferson Count
											Assessor's Records
			SITE 2								
			GILPIN COUNTY								
			GILFIN COUNTY								
PE-120	PETER SEIPP GOLTRA AS CUSTODIAN	Not Available Vacant Land	NW1/4 SECTION 27	21,575 sf		21,575 sf				NF0047	The purpose of this permanent easement is fo
	FOR CAROLYN SEIPP GOLTRA,		T. 3S., R. 72 W., 6th P.M.	0.495 ac		0.495 ac	300 ac +				construction and maintenance of Rock Fall
	1/2 INTEREST										Mitigation
	AND FOR ANDREW RENARD GOLTRA,										Total Remainder area per the Gilpin County
	1/2 INTEREST										Assessor's Records
	P.O. BOX 721										
	LAKE FOREST, IL 60045										
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DOT Region 1 Address: 18500 E. Colfax Ave.

Aurora, CO 80011 Phone: (303) 757–9744 FAX: (303) 757–9746 Survey Unit: Joseph Conway

	SHEEF MENDIONS	
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US HIGHWAY NO. 6 MP 257.0 to MP 271.6 SITUATE IN SEC. 28, 32 & 33, T. 3 S., R. 70 W., SEC. 32, 33, 34, 35 & 36, T. 3 S., R. 71 W., SEC. 36, T. 3 S., R. 72 W., SEC. 6, T. 4 S., R. 70 W., SEC. 2, 3, 5 & 6, T. 4 S., R. 71 W., SEC. 1, T. 4 S., R. 72 W. OF THE 6TH P.M., COUNTY OF JEFFERSON, AND SEC. 34, 35 & 36, T. 3 S., R. 72 W., SEC. 1, 2 & 3, T. 4 S., R. 72 W. OF THE 6TH P.M., COUNTY OF CLEAR CREEK, STATE OF COLORADO.


1 Toject Condor Diagram
Title Sheet
Project Number: STA 119A-048
Project Location: US HWY 6 - MILEPOST 257.0 TO 271.6

Project Location: JEFFERSON & CLEAR CREEK COUNTIES Project Code: Last Mod. Date Subset Sheets Sheet No. Total No. of Sheet 10-18-04 XXX of XXX 1

Project Control Diggram

NH 0061-078 PC 15370 SHEET 03

MOUNTAIN SURVEYING & MAPPING, INC. 8751 E. HAMPDEN AVE. SUITE B-1 DENVER, COLORADO 80231 (303) 306-1858

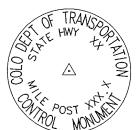

Typical Control Monument Cap Not to Scale

a bridge and "THREE" a horizontal control disk set in a rock outcropping. That bearing being S82' 36' 11"E. running a closed bench loop.

BASIS OF ELEVATIONS: Project is based on an elevation of 5717.85 ft at NSRS benchmark L 407. Control points from milepost 257.0 to milepost 271.6 were tied in by means of

BASIS OF BEARING: All bearings are grid bearings of the Colorado State Plane Coordinate System, Central Zone, North American Datum1983/92. The basis of grid bearing is the line between NSRS horizontal stations "FOUR" a horizontal control disk set in the abutment of

COORDINATE DATUM: Project coordinates are modified Colorado State Plane Coordinate System, Central Zone, North American Datum1983/92 coordinates. The combined elevation scale factor was calculated on a previous CDOT project and is 1.000350925. The modified metric values were converted to US Survey Feet by (3937/1200). The north values were truncated by 1,000,000 and the east values were truncated by 2,000,000.



CP - Control Point Monuments set by CDOT. They were CDOT type 2 monuments, a 3-1/4" dia. aluminum control monument cap (as shown) on a $3' \times 3/4"$ dia. finned aluminum security rod on a $3' \times 3/4"$ dia. smooth aluminúm rod.

NOTE: This control survey is for the use of the Colorado Department of Transportation personnel. The survey is not a complete Boundary Survey. Title Policy, Title Commitment, and Title Research were not part of this control survey, therefore, easements, rights, and restrictions of record are not shown. The verification of the physical evidence with relation to easements, rights of way, property boundaries, and restriction, as described in the instruments of record, were not included in this control survey.

NOTE: According to Colorado law you must commence any legal action based upon any defect in this survey within three years after you first discover such defect. In no event may any action based upon any defect in this survey be commenced more than ten years from the date of the statement shown.

NOTE: No guarantee as to the accuracy of the information contained on the attached drawing is either stated or implied unless this copy bears an original signature of the professional land surveyor hereon named.

SURVEYORS STATEMENT: I, Michael D. Heimbuck, a Professional Land Surveyor in the State of Colorado, hereby state that this Control Survey Diagram was prepared under my direct supervision this _____day of ______, from a field survey performed under my supervision and checking for and on behalf of the Department of Transportation, State of Colorado, and is not a Land Survey Plat or Right-of-Way Survey Plat and to the best of my knowledge and belief this control survey, as shown, meets the minimum horizontal control tolerances of a Type B Survey and this topographic survey, as shown, meets the minimum horizontal control tolerances of a Type D Survey as listed in the Colorado Department of Transportation Survey Manual Chapter Three (Revised 4/29/92).

Michael D. Heimbuck PLS 17488

CONSTRUCTION SURVEYING AND MONUMENTATION REQUIREMENTS:

- 1). This Control Survey Diagram represents the horizontal and vertical control for the project established by the Division. It is possible that some of the survey control monuments listed have been disturbed or obliterated. It is the Contractor's responsibility to verify the existence and stability of the control monuments before submitting a bid price.
- All Type 1 and Type 2 monuments shall be set flush with the ground. Witness
 posts shall be installed 1 foot from and facing all Type 1 and Type 2 monuments,
 or as directed by the Project Engineer.
- 3). Installation of Type 3 and Type 3-A monuments shall be completed in the same day that installation is commenced. Under no circumstances shall holes in the roadway be left open overnight.
- 4). When installing Type 3—A monuments, the aluminum access cover shall be positively secured to the PVC pipe with screws or glue. The access cover shall be caulked with asphalt caulking between the cover and the edges of the roadway surface to provide a positive moisture barrier around the access cover.
- 5). Control survey procedures, statistical analysis, and accuracy obtained for horizontal and vertical control shall be documented in the field book.
- 6). Legible copies of the field books shall be submitted to the Project Engineer for review on a monthly basis.
- 7). It is ultimately the prime Contractors responsibility to insure that these requirements, as well as any contained in the CDOT specifications, project special provisions, and CDOT Survey Manual are fulfilled under this contract.
- 8). The minimum staking intervals for each item are described on the plans or in the CDOT Survey Manual. If the contractor wishes to reduce the minimum intervals, a Contract Modification Order must be negotiated and the cost of the item reduced

2004 08:30 Plot/Edited By: DAW cts/CD0T\04053\PCD\14231pcc

DOT Region 1 Address: 18500 E. Colfax Ave.

Aurora, CO 80011 ORTATION Phone: (303) 757-9744

DEPARTMENT OF TRANSPORTATION	Phone: (303) 757-9744	FAX:	(303)	757-9746
Survey Unit:	Joseph Conway			

	Sheet	Revisions	
mm/yy		XXXXX	X
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US HIGHWAY NO. 6 MP 257.0 to MP 271.6
SITUATE IN SEC. 28, 32 & 33, T. 3 S., R. 70 W.,
SEC. 32, 33, 34, 35 & 36, T. 3 S., R. 71 W., SEC. 36, T. 3 S., R. 72 W.,
SEC. 6, T. 4 S., R. 70 W., SEC. 2, 3, 5 & 6, T. 4 S., R. 71 W.,
SEC. 1, T. 4 S., R. 72 W. OF THE 6TH P.M., COUNTY OF JEFFERSON, AND
SEC. 34, 35 & 36, T. 3 S., R. 72 W., SEC. 1, 2 & 3, T. 4 S., R. 72 W. OF
THE 6TH P.M., COUNTY OF CLEAR CREEK, STATE OF COLORADO.

Pro	oject Control Diagram	
М	onumentation Sheet	
ct Number:	STA 119A-048	

Project Location: US HWY 6 - MILEPOST 257.0 TO 271.6 Project Location: JEFFERSON & CLEAR CREEK COUNTIES

 Project Code:
 Last Mod. Date
 Subset Sheets
 Sheet No.
 Total No. of Sheet

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 10-18-04
 XXX of XXX
 2
 15
 NH 0061-078 PC 15370 SHEET 03A

MOUNTAIN SURVEYING & MAPPING, INC. 8751 E. HAMPDEN AVE. SUITE B-1 DENVER, COLORADO 80231 (303) 306-1858

GEODETIC COORDINATE SUMMARY TABLE (ADJUSTED FIELD DATA)

PROJECT	COORDINATE	SUMMARY	TABLE
()	ADJUSTED FIE	ELD DATA)	

	T	T						<u> </u>				
POINT NAME		ES NAD-83(92) (CHARN)	ELLIP.	MAPPING	SCALE	NAD 83(92)	ZONE 0502	POINT NAME	PROJECT C	COORDINATES	ELEV(ft)	DESCRIPTION
1 0111 117/11/12	LATITUDE(N)	LONGITUDE(W)	(NAVD88)m	ANGLE	JUALL	NORTHING (m)	EASTING (m)	I CITY IVANIL	NORTH (ft)	EAST (ft)		DESCRIPTION
I-70 CM-MP 244.42	39° 44′ 46.53439″ N	105° 26′ 16.07648″ W	2190.106	0° 02' 21.22623"	0.999999262	517158.522	919733.014	I-70 CM-MP 244.42	697306.34	1018549.64	7229.96	SET CDOT TYPE 2 MON.
US 6 CM-MP 257.30	39° 44′ 48.47216″ N	105° 26' 10.55318" W	2186.948	0' 02' 24.70971"	0.999999368	517218.377	919864.471	US 6 CM-MP 257.30	697502.78	1018981.08	7219.63	SET CDOT TYPE 2 MON.
US 6 CM-MP 257.50	39° 44′ 42.65509" N	105° 26' 01.55646" W	2184.282	0' 02' 30.38385"	0.999999050	517039.122	920078.795	US 6 CM-MP 257.50	696914.47	1019684.49	7210.92	SET CDOT TYPE 2 MON.
US 6 CM-MP 257.70	39° 44′ 34.40898″ N	105° 25′ 54.09112″ W	2183.688	0' 02' 35.09216"	0.999998601	516784.931	920256.724	US 6 CM-MP 257.70	696080.22	1020268.45	7208.99	SET CDOT TYPE 2 MON.
US 6 CM-MP 257.80	39° 44° 31.97577" N	105° 25' 47.59827" W	2187.576	0' 02' 39.18713"	0.999998469	516710.005	920411.371	US 6 CM-MP 257.80	695834.31	1020776.00	7221.78	SET CDOT TYPE 2 MON.
US 6 CM-MP 257.95	39° 44′ 28.59187″ N	105° 25° 38.92699" W	2179.344	0° 02' 44.65602"	0.999998286	516605.802	920617.913	US 6 CM-MP 257.95	695492.32	1021453.87	7194.80	SET CDOT TYPE 2 MON.
US 6 CM-MP 258.10	39° 44′ 21.27357″ N	105° 25′ 37.84978″ W	2171.908	0° 02' 45.33541"	0.999997890	516380.116	920643.742	US 6 CM-MP 258.10	694751.62	1021538.64	7170.40	SET CDOT TYPE 2 MON.
US 6 CM-MP 258.15	39° 44′ 19.43073″ N	105° 25′ 34.43330″ W	2169.678	0° 02′ 47.49014″	0.999997790	516323.345	920725.136	US 6 CM-MP 258.15	694565.30	1021805.77	7163.09	SET CDOT TYPE 2 MON.
US 6 CM-MP 258.20 US 6 CM-MP 258.35	39° 44′ 19.91678″ N 39° 44′ 19.16725″ N	105' 25' 27.44662" W	2165.044	0' 02' 51.89657"	0.999997816	516338.473	920891.480	US 6 CM-MP 258.20	694614.95	1022351.71	7147.94	SET CDOT TYPE 2 MON.
US 6 CM-MP 258.50	39° 44° 12.85742" N	105° 25' 21.52273" W 105° 25' 13.73112" W	2161.029 2156.199	0° 02° 55.63271" 0° 03° 00.54679"	0.999997776	516315.475	921032.551	US 6 CM-MP 258.35	694539.47	1022814.70	7134.82	SET CDOT TYPE 2 MON.
US 6 CM-MP 258.70	39° 44° 11.36094" N	105° 25° 07.37360" W	2153.335	0° 03′ 04.55641″	0.999997436 0.999997355	516121.031 516075.011	921218.245 921369.667	US 6 CM-MP 258.50 US 6 CM-MP 258.70	693901.31	1023424.15	7118.98	SET CDOT TYPE 2 MON. SET CDOT TYPE 2 MON.
US 6 CM-MP 258.85	39° 44′ 16.48598" N	105° 24° 57.12088" W	2150.282	0° 03′ 11.02270″	0.999997631	516233.297	921613.651	US 6 CM-MP 258.85	693750.27 694269.76	1023921.11	7109.65 7099.72	SET CDOT TYPE 2 MON. SET CDOT TYPE 2 MON.
US 6 CM-MP 259.00	39° 44' 23.01480" N	105° 24° 51.29943" W	2145.597	0° 03' 14.69423"	0.999997984	516434.785	921752.075	US 6 CM-MP 259.00	694931.04	1024721.87	7099.72	SET CDOT TIPE 2 MON.
US 6 CM-MP 259.10	39° 44° 25.42358" N	105° 24° 41.29660" W	2134.484	0' 03' 21.00291"	0.999998114	516509.304	921990.173	US 6 CM-MP 259.10	695175.61	1025957.60	7004.41	SET CDOT TYPE 2 MON.
US 6 CM-MP 259.25	39° 44° 27.78432" N	105° 24' 34.79183" W	2123.511	0' 03' 25.10540"	0.999998242	516582.265	922144.979	US 6 CM-MP 259.25	695415.07	1026465.68	7047.37	SET CDOT TYPE 2 MON.
US 6 CM-MP 259.35	39° 44° 31.79436" N	105° 24' 31.51096" W	2121.185	0' 03' 27.17461"	0.999998459	516706.019	922222.972	US 6 CM-MP 259.35	695821.23	1026721.65	7004.41	FOUND CDOT TYPE 2 MON.
US 6 CM-MP 259.46	39° 44° 33.47791" N	105° 24' 28.74459" W	2119.419	0' 03' 28.91933"	0.999998551	516758.009	922288.785	US 6 CM-MP 259.46	695991.86	1026937.65	6998.65	SET CDOT TYPE 2 MON.
US 6 CM-MP 259.50	39° 44' 35.32414" N	105° 24' 24.20158" W	2119.481	0° 03′ 31.78456″	0.999998651	516815.059	922396.893	US 6 CM-MP 259.50	696179.10	1027292.45	6998.90	FOUND CDOT TYPE 2 MON.
US 6 CM-MP 259.60	39° 44′ 41.65222" N	105° 24' 19.98445" W	2112.153	0° 03' 34.44426"	0.999998996	517010.331	922497.096	US 6 CM-MP 259.60	696819.98	1027621.32	6974.89	SET CDOT TYPE 2 MON.
US 6 CM-MP 259.65	39° 44′ 48.37258″ N	105° 24' 17.04458" W	2102.688	0' 03' 36.29840"	0.999999363	517217.670	922566.872	US 6 CM-MP 259.65	697500.46	1027850.32	6943.85	SET CDOT TYPE 2 MON.
US 6 CM-MP 259.80	39° 44° 49.26274" N	105° 24' 07.03433" W	2093.852	0' 03' 42.61176"	0.999999411	517245.378	922805.166	US 6 CM-MP 259.80	697591.40	1028632.40	6914.94	SET CDOT TYPE 2 MON.
US 6 CM-MP 259.95	39° 44′ 50.36719" N	105° 24' 00.73366" W	2094.389	0' 03' 46.58553"	0.999999472	517279.604	922955.133	US 6 CM-MP 259.95	697703.73	1029124.59	6916.74	SET CDOT TYPE 2 MON.
US 6 CM-MP 260.05	39° 44′ 46.38504″ N	105° 23' 52.34650" W	2091.991	0' 03' 51.87522"	0.999999254	517157.010	923154.950	US 6 CM-MP 260.05	697301.38	1029780.39	6908.96	SET CDOT TYPE 2 MON.
US 6 CM-MP 260.20	39° 44° 39.54327" N	105° 23′ 50.14922″ W	2093.796	0° 03' 53.26102"	0.999998881	516946.059	923207.502	US 6 CM-MP 260.20	696609.04	1029952.86	6914.88	SET CDOT TYPE 2 MON.
US 6 CM-MP 260.40	39° 44′ 35.98058″ N	105° 23' 38.98939" W	2082.677	0" 04' 00.29941"	0.999998687	516836.485	923473.331	US 6 CM-MP 260.40	696249.42	1030825.31	6878.48	SET CDOT TYPE 2 MON.
US 6 CM-MP 260.60	39° 44′ 32.46464″ N	105° 23' 26.47474" W	2079.539	0° 04' 08.19227"	0.999998496	516728.401	923771.423	US 6 CM-MP 260.60	695894.69	1031803.64	6868.25	SET CDOT TYPE 2 MON.
US 6 CM-MP 260.80	39° 44' 22.83218" N	105° 23' 23.71064" W	2078.856	0' 04' 09.93556"	0.999997974	516431.401	923837.595	US 6 CM-MP 260.80	694919.94	1032020.81	6866.01	SET CDOT TYPE 2 MON.
US 6 CM-MP 260.98	39° 44' 16.00257" N	105° 23′ 19.81393″ W	2076.395	0' 04' 12.39317"	0.999997605	516220.878	923930.634	US 6 CM-MP 260.98	694229.01	1032326.17	6857.95	SET CDOT TYPE 2 MON.
US 6 CM-MP 261.08	39° 44′ 10.36946″ N	105° 23' 12.69762" W	2071.064	0' 04' 16.88136"	0.999997302	516047.354	924100.296	US 6 CM-MP 261.08	693659.50	1032883.00	6840.50	SET CDOT TYPE 2 MON.
US 6 CM-MP 261.15	39° 44′ 08.19703" N	105° 23' 06.46544" W	2068.934	0' 04' 20.81193"	0.999997185	515980.540	924248.778	US 6 CM-MP 261.15	693440.22	1033370.31	6833.55	SET CDOT TYPE 2 MON.
US 6 CM-MP 261.25	39° 44′ 12.13607″ N	105° 23' 00.53643" W	2065.058	0° 04' 24.55129"	0.999997397	516102.205	924389.802	US 6 CM-MP 261.25	693839.52	1033833.15	6820.89	SET CDOT TYPE 2 MON.
US 6 CM-MP 261.45	39° 44° 15.35835" N	105' 22' 53.73258" W	2062.565	0' 04' 28.84241"	0.999997570	516201.794	924551.681	US 6 CM-MP 261.45	694166.37	1034364.43	6812.76	SET CDOT TYPE 2 MON.
US 6 CM-MP 261.65	39° 44° 10.85066" N	105° 22° 47.28742" W	2062.368	0. 04, 32.90730,	0.999997328	516062.972	924705.331	US 6 CM-MP 261.65	693710.76	1034868.71	6812.15	FOUND CDOT TYPE 2 MON.
US 6 CM-MP 261.70 US 6 CM-MP 261.75	39* 44' 09.72992" N 39* 44' 10.40438" N	105° 22′ 44.72710″ W 105° 22′ 41.29602″ W	2061.014	0' 04' 34.52207"	0.999997267	516028.488	924766.341	US 6 CM-MP 261.70	693597.58	1035068.95	6807.68	FOUND CDOT TYPE 2 MON.
US 6 CM-MP 261.85	39° 44° 12.60816" N	105 22 41.29602 W	2059.664 2057.191	0° 04° 36.68602" 0° 04° 41.81259"	0.999997304 0.999997422	516049.398 516117.628	924848.013 925041.472	US 6 CM-MP 261.75	693666.21	1035336.99	6803.31	FOUND CDOT TYPE 2 MON.
US 6 CM-MP 261.95	39° 44° 12.14763" N	105 22 35.10730 W	2056.726	0° 04° 46.40138"	0.999997397	516103.663	925214.738	US 6 CM-MP 261.85 US 6 CM-MP 261.95	693890.14 693844.31	1035971.92 1036540.58	6795.26 6793.79	SET CDOT TYPE 2 MON. SET CDOT TYPE 2 MON.
US 6 CM-MP 262.10	39° 44' 13.72151" N	105° 22° 16.85142" W	2056.720	0' 04' 52.10297"	0.999997482	516152.506	925429.929	US 6 CM-MP 262.10	694004.61	1036340.36	6793.79	SET CDOT TIPE 2 MON.
US 6 CM-MP 262.30	39° 44' 03.35849" N	105° 22' 10.78512" W	2048.188	0' 04' 55.92892"	0.999996925	515833.102	925574.833	US 6 CM-MP 262.30	692956.33	1037722.40	6765.87	SET COOT TIPE 2 MON.
US 6 CM-MP 262.40	39° 44′ 02.83261″ N	105° 22' 05.79881" W	2045.756	0' 04' 59.07374"	0.999996897	515817.054	925693.591	US 6 CM-MP 262.40	692903.66	1037722.40	6757.93	SET COOT TYPE 2 MON.
US 6 CM-MP 262.55	39° 44' 07.22163" N	105° 21' 53.27479" W	2042.448	0° 05' 06.97251"	0.999997133	515952.856	925991.614	US 6 CM-MP 262.55	693349.36	1039090.27	6747.18	SET CDOT TYPE 2 MON.
US 6 CM-MP 262.65	39° 44′ 03.85712" N	105° 21' 44.71108" W	2041.473	0' 05' 12.37355"	0.999996952	515849.396	926195.688	US 6 CM-MP 262.65	693009.80	1039760.04	6744.04	SET CDOT TYPE 2 MON.
US 6 CM-MP 262.75	39° 44' 04.37674" N	105° 21' 40.05283" W	2041.089	0* 05' 15.31146"	0.999996980	515865.590	926306.586	US 6 CM-MP 262.75	693062.95	1040124.01	6742.82	SET CDOT TYPE 2 MON.
US 6 CM-MP 262.85	39° 44' 08.26336" N	105° 21′ 36.42790″ W	2039.138	0° 05' 17.59766"	0.999997189	515985.591	926392.718	US 6 CM-MP 262.85	693456.80	1040406.69	6736.47	SET CDOT TYPE 2 MON.
US 6 CM-MP 263.05	39* 44' 13.95143" N	105° 21' 28.61390" W	2038.547	0° 05' 22.52587"	0.999997495	516161.308	926578.508	US 6 CM-MP 263.05	694033.50	1041016.45	6734.60	SET CDOT TYPE 2 MON.
US 6 CM-MP 263.25	39° 44° 21.04163" N	105° 21' 26.12892" W	2037.139	0' 05' 24.09312"	0.999997877	516380.073	926637.335	US 6 CM-MP 263.25	694751.48	1041209.52	6730.00	SET CDOT TYPE 2 MON.
US 6 CM-MP 263.40	39° 44° 25.16384" N	105° 21' 17.09138" W	2028.876	0' 05' 29.79300"	0.999998100	516507.549	926852.319	US 6 CM-MP 263.40	695169.85	1041915.09	6702.98	SET CDOT TYPE 2 MON.
US 6 CM-MP 263.50	39° 44′ 26.03672″ N	105° 21′ 07.14282" W	2021.789	0' 05' 36.06746"	0.999998147	516534.852	927089.151	US 6 CM-MP 263.50	695259.46	1042692.37	6679.83	SET CDOT TYPE 2 MON.
US 6 CM-MP 263.60	39° 44° 32.13730" N	105° 20' 58.78082" W	2019.408	0° 05' 41.34128"	0.999998478	516723.330	927287.938	US 6 CM-MP 263.60	695878.04	1043344.79	6672.07	SET CDOT TYPE 2 MON.
US 6 CM-MP 263.75	39° 44′ 31.58441″ N	105° 20′ 48.86375″ W	2011.402	0° 05' 47.59588"	0.999998448	516706.673	927524.087	US 6 CM-MP 263.75	695823.37	1044119.82	6645.88	SET CDOT TYPE 2 MON.
US 6 CM-MP 263.95	39° 44′ 27.44030″ N	105* 20' 40.58574" W	2004.329	0° 05' 52.81673"	0.999998223	516579.197	927721.400	US 6 CM-MP 263.95	695405.00	1044767.40	6622.73	SET CDOT TYPE 2 MON.
US 6 CM-MP 264.15	39° 44° 26.24739" N	105° 20' 25.69221" W	1993.697	0' 06' 02.20992"	0.999998159	516543.020	928076.077	US 6 CM-MP 264.15	695286.27	1045931.45	6587.96	SET CDOT TYPE 2 MON.
US 6 CM-MP 264.35	39° 44′ 28.01350″ N	105° 20' 15.71259" W	1987.302	0' 06' 08.50397"	0.999998254	516597.911	928313.594	US 6 CM-MP 264.35	695466.42	1046710.97	6567.05	SET CDOT TYPE 2 MON.
US 6 CM-MP 264.50	39° 44′ 28.92402″ N	105° 20° 03.98207" W	1981.967	0' 06' 15.90228"	0.999998304	516626.496	928592.844	US 6 CM-MP 264.50	695560.23	1047627.47	6549.66	FOUND CDOT TYPE 2 MON.
US 6 CM-MP 264.60	39° 44′ 30.07982″ N	105° 19' 54.46822" W	1980.113	0' 06' 21.90257"	0.999998366	516662.559	928819.299	US 6 CM-MP 264.60	695678.59	1048370.69	6543.66	FOUND CDOT TYPE 2 MON.

Region 1 Address: 18500 E. Colfax Ave.

Survey Unit: Joseph Conway

Auroro, CO 80011 Phone: (303) 757–9744 FAX: (303) 757–9746

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US HIGHWAY NO. 6 MP 257.0 to MP 271.6 SITUATE IN SEC. 28, 32 & 33, T. 3 S., R. 70 W., SEC. 32, 33, 34, 35 & 36, T. 3 S., R. 71 W., SEC. 36, T. 3 S., R. 72 W., SEC. 6, T. 4 S., R. 70 W., SEC. 2, 3, 5 & 6, T. 4 S., R. 71 W., SEC. 1, T. 4 S., R. 72 W. OF THE 6TH P.M., COUNTY OF JEFFERSON, AND SEC. 34, 35 & 36, T. 3 S., R. 72 W., SEC. 1, 2 & 3, T. 4 S., R. 72 W. OF

THE 6TH P.M., COUNTY OF CLEAR CREEK, STATE OF COLORADO.

Project Control Diagram

Monumentation Sheet Project Number: STA 119A-048

Project Location: US HWY 6 - MILEPOST 257.0 TO 271.6 Project Location: JEFFERSON & CLEAR CREEK COUNTIES

 Project Code:
 Last Mod. Date
 Subset Sheets
 Sheet No.
 Total No. of Sheets

 14231
 10-18-04
 XXX of XXX
 3
 15

PC 15370 SHEET 03B

MOUNTAIN SURVEYING & MAPPING, INC. 8751 E. HAMPDEN AVE. SUITE B-1 DENVER, COLORADO 80231 (303) 306-1858

GEODETIC COORDINATE SUMMARY TABLE (ADJUSTED FIELD DATA)

PROJECT	COORDINATE	SU	MMARY	TABLE
(/	ADJUSTED FIE	ELD	DATA)	

DOINT NAME	GEODETIC COORDINATE	S NAD-83(92) (CHARN)	ELLIP.	MAPPING	COALE	NAD 83(92) ZONE 0502		DOINT NAME	PROJECT COORDINATES			DECODIDATION
POINT NAME	LATITUDE(N)	LONGITUDE(W)	(NAVD88)m	ANGLE	SCALE	NORTHING (m)	EASTING (m)	POINT NAME	NORTH (ft)	EAST (ft)	ELEV(ft)	DESCRIPTION
US 6 CM-MP 264.70	39° 44° 29.78594" N	105° 19' 47.56390" W	1977.670	0* 06' 26.25705"	0.999998350	516653.802	928983.705	US 6 CM-MP 264.70	695649.85	1048910.27	6535.69	FOUND CDOT TYPE 2 MON.
US 6 CM-MP 265.00	39° 44′ 27.99605″ N	105° 19' 31.02160" W	1967.688	0" 06" 36.69011"	0.999998253	516599.346	929377.677	US 6 CM-MP 265.00	695471.13	1050203.28	6503.06	FOUND CDOT TYPE 2 MON.
US 6 CM-MP 265.15	39° 44′ 23.84944″ N	105° 19° 22.49176" W	1956.211	0' 06' 42.06979"	0.999998029	516471.852	929581.020	US 6 CM-MP 265.15	695052.70	1050870.65	6465.48	FOUND CDOT TYPE 2 MON.
US 6 CM-MP 265.45	39° 44′ 14.27154" N	105° 19' 05.65589" W	1933.118	0° 06' 52.68800"	0.999997512	516177.248	929982.475	US 6 CM-MP 265.45	694085.81	1052188.22	6389.79	FOUND CDOT TYPE 2 MON.
US 6 CM-MP 265.50	39° 44′ 12.44324″ N	105° 19' 03.28135" W	1929.551	0' 06' 54.18559"	0.999997413	516120.974	930039.129	US 6 CM-MP 265.50	693901.12	1052374.15	6378.12	FOUND CDOT TYPE 2 MON.
US 6 CM-MP 265.75	39° 44′ 16.08157" N	105° 18′ 43.11710″ W	1914.771	0' 07' 06.90298"	0.999997609	516234.164	930519.032	US 6 CM-MP 265.75	694272.61	1053949.19	6329.79	FOUND CDOT TYPE 2 MON.
US 6 CM-MP 265.95	39° 44′ 22.02969″ N	105' 18' 41.88686" W	1909.784	0' 07' 07.67887"	0.999997930	516417.673	930547.945	US 6 CM-MP 265.95	694874.88	1054044.08	6313.46	FOUND CDOT TYPE 2 MON.
US 6 CM-MP 266.05	39° 44° 28.78127" N	105° 18' 39.04386" W	1902.170	0 07 09.47193"	0.999998296	516626.042	930615.204	US 6 CM-MP 266.05	695558.74	1054264.82	6288.53	FOUND CDOT TYPE 2 MON.
US 6 CM-MP 266.20	39° 44' 31.70059" N	105° 18′ 31.89548″ W	1902.930	0° 07' 13.98033"	0.999998454	516716.434	930785.216	US 6 CM-MP 266.20	695855.41	1054822.80	6291.09	FOUND CDOT TYPE 2 MON.
US 6 CM-MP 266.40	39° 44° 43.34958" N	105° 18' 34.31583" W	1895.060	0° 07' 12.45384"	0.999999088	517075.585	930726.835	US 6 CM-MP 266.40	697034.14	1054631.20	6265.29	FOUND CDOT TYPE 2 MON.
US 6 CM-MP 266.50	39° 44° 47.81053" N	105' 18' 33.02338" W	1891.844	0° 07' 13.26898"	0.999999332	517213.232	930757.317	US 6 CM-MP 266.50	697485.89	1054731.24	6254.77	FOUND CDOT TYPE 2 MON.
US 6 CM-MP 266.60	39° 44° 50.34962″ N	105' 18' 26.77581" W	1887.817	0' 07' 17.20926"	0.999999471	517291.856	930905.893	US 6 CM-MP 266.60	697743.94	1055218.86	6241.62	FOUND CDOT TYPE 2 MON.
US 6 CM-MP 266.80	39° 44° 49.20190" N	105° 18' 16.17652" W	1885.064	0' 07' 23.89412"	0.999999408	517256.997	931158.313	US 6 CM-MP 266.80	697629.53	1056047.30	6232.66	FOUND CDOT TYPE 2 MON.
US 6 CM-MP 266.90	39° 44° 46.74549" N	105° 18' 08.75876" W	1884.438	0° 07' 28.57242"	0.999999274	517181.620	931335.078	US 6 CM-MP 266.90	697382.14	1056627.44	6230.66	FOUND CDOT TYPE 2 MON.
US 6 CM-MP 267.10	39° 44′ 39.34611″ N	105' 18' 02.69063" W	1877.117	0. 07, 32.39953,	0.999998870	516953.728	931480.049	US 6 CM-MP 267.10	696634.21	1057103.23	6206.66	FOUND CDOT TYPE 2 MON.
US 6 CM-MP 267.28	39° 44° 37.57724" N	105° 17' 54.33648" W	1865.404	0' 07' 37.66840"	0.999998774	516899.612	931679.071	US 6 CM-MP 267.28	696456.60	1057756.42	6168.29	FOUND CDOT TYPE 2 MON.
US 6 CM-MP 267.30	39° 44° 37.10156" N	105* 17' 50.54127" W	1862.307	0' 07' 40.06200"	0.999998748	516885.142	931769.463	US 6 CM-MP 267.30	696409.11	1058053.08	6158.16	FOUND CDOT TYPE 2 MON.
US 6 CM-MP 267.45	39° 44′ 32.97926″ N	105° 17′ 41.52110″ W	1855.296	0° 07' 45.75093"	0.999998524	516758.486	931984.511	US 6 CM-MP 267.45	695993.42	1058758.87	6135.20	FOUND COOT TYPE 2 MON.
US 6 CM-MP 267.50	39° 44′ 31.84040″ N	105' 17' 36.86540" W	1852.946	0' 07' 48.68723"	0.999998462	516723.613	932095.439	US 6 CM-MP 267.50	695878.97	1059122.93	6127.53	FOUND CDOT TYPE 2 MON.
US 6 CM-MP 267.75	39° 44′ 38.62499″ N	105° 17' 23.89622" W	1852.424	0° 07' 56.86676"	0.999998831	516933.568	932403.744	US 6 CM-MP 267.75	696568.04	1060134.78	6125.95	FOUND CDOT TYPE 2 MON.
US 6 CM-MP 268.10	39° 44′ 30.34137″ N	105° 17' 01.06192" W	1838.526	0° 08' 11.26811"	0.999998381	516679.365	932948.008	US 6 CM-MP 268.10	695733.75	1061921.05	6080.53	FOUND CDOT TYPE 2 MON.
US 6 CM-MP 268.25	39° 44′ 26.20694″ N	105' 16' 49.76929" W	1833.975	0.08, 18.39026,	0.999998156	516552.498	933217.188	US 6 CM-MP 268.25	695316.21	1062805.23	6065.68	FOUND CDOT TYPE 2 MON.
US 6 CM-MP 268.35	39° 44° 26.22910" N	105' 16' 44.05670" W	1833.103	0' 08' 21.99313"	0.999998158	516553.511	933353.203	US 6 CM-MP 268.35	695320.70	1063250.89	6062.88	FOUND CDOT TYPE 2 MON.
US 6 CM-MP 268.45	39° 44′ 29.48031″ N	105° 16′ 39.21010″ W	1830.930	0.08, 25.04983,	0.999998334	516654.065	933468.355	US 6 CM-MP 268.45	695650.72	1063628.82	6055.82	FOUND COOT TYPE 2 MON.
US 6 CM-MP 268.65	39° 44′ 31.59139″ N	105' 16' 29.91428" W	1826.286	0° 08' 30.91260"	0.999998448	516719.719	933689.523	US 6 CM-MP 268.65	695866.19	1064354.69	6040.69	FOUND CDOT TYPE 2 MON.
US 6 CM-MP 268.80	39° 44′ 37.44286″ N	105° 16' 19.91164" W	1820.237	0° 08′ 37.22116″	0.999998766	516900.780	933927.227	US 6 CM-MP 268.80	696460.43	1065134.83	6020.97	FOUND CDOT TYPE 2 MON.
US 6 CM-MP 268.95	39° 44′ 33.49049″ N	105' 16' 10.64173" W	1813.193	0° 08' 43.06760"	0.999998552	516779.440	934148.242	US 6 CM-MP 268.95	696062.19	1065860.20	5997.93	FOUND CDOT TYPE 2 MON.
US 6 CM-MP 269.20	39° 44° 22.82692″ N	105' 16' 11.27248" W	1807.261	0.08, 42.66979,	0.999997974	516450.522	934134.058	US 6 CM-MP 269.20	694982.69	1065813.65	5978.42	FOUND CDOT TYPE 2 MON.
US 6 CM-MP 269.34 US 6 CM-MP 269.50	39° 44° 19.60981" N	105' 16' 01.42017" W	1803.147	0.08, 48.88354,	0.999997800	516351.900	934368.898	US 6 CM-MP 269.34 US 6 CM-MP 269.50	694659.01	1066584.39	5964.97	SET CDOT TYPE 2 MON.
US 6 CM-MP 269.70	39° 44′ 19.95112″ N 39° 44′ 17.76084″ N	105' 15' 52.79711" W 105' 15' 38.82238" W	1798.322 1791.676	0° 08′ 54.32201″ 0° 09′ 03.13573″	0.999997818 0.999997700	516362.956 516296.273	934574.190 934907.113	US 6 CM-MP 269.70	694695.30 694476.45	1067258.16 1068350.80	5949.25 5927.56	FOUND CDOT TYPE 2 MON. FOUND CDOT TYPE 2 MON.
US 6 CM-MP 269.80	39° 44' 21.13103" N	105' 15' 34.73242" W	1787.754	0° 09' 05.71523"	0.999997882	516400.472	935004.223	US 6 CM-MP 269.80	694818.43	1068669.52	5914.75	FOUND COOT TYPE 2 MON.
US 6 CM-MP 270.10	39° 44° 31.79352" N	105° 15' 23.14350" W	1775.534	0' 09' 13.02424"	0.999998459	516730.053	935279.278	US 6 CM-MP 270.10	695900.11	1069572.24	5874.79	FOUND CDOT TYPE 2 MON.
US 6 CM-MP 270.10	39° 44° 32.63969" N	105 15 23.14330 W	1766.171	0° 09' 20.60356"	0.999998505	516756.922	935565.337	US 6 CM-MP 270.10	695988.29	1070511.08	5844.19	FOUND CDOT TYPE 2 MON.
US 6 CM-MP 270.40	39° 44° 41.44134" N	105° 15' 04.70211" W	1763.284	0' 09' 24.65503"	0.999998984	517028.795	935717.541	US 6 CM-MP 270.40	696880.57	1070311.08	5834.83	FOUND CDOT TYPE 2 MON.
US 6 CM-MP 270.76	39° 44° 52.41273" N	105° 15' 04.23320" W	1754.276	0' 09' 24.95076"	0.999999584	517367.199	935727.779	US 6 CM-MP 270.76	697991.21	1071010.02	5805.31	SET CDOT TYPE 2 MON.
US 6 CM-MP 270.84	39' 44' 58.88688" N	105° 15' 04.69246" W	1749.361	0. 09, 54.66111,	0.999999939	517566.842	935716.298	US 6 CM-MP 270.84	698646.43	1071006.54	5789.15	SET CDOT TYPE 2 MON.
US 6 CM-MP 270.95	39° 45' 05.31224" N	105° 14' 51.58851" W	1743.133	0.09, 32.92564,	1.000000292	517765.870	936027.711	US 6 CM-MP 270.95	699299.64	1072028.59	5768.88	FOUND CDOT TYPE 2 MON.
US 6 CM-MP 271.20	39° 45′ 10.72295" N	105° 14′ 40.45925″ W	1739.611	0' 09' 39.94475"	1.000000591	517933.485	936292.187	US 6 CM-MP 271.20	699849.75	1072896.60	5757.53	FOUND CDOT TYPE 2 MON.
US 6 CM-MP 271.30	39° 45' 13.81856" N	105° 14' 32.73956" W	1741,477	0. 09, 44.81347,	1.000000331	518029.477	936475.689	US 6 CM-MP 271.30	700164.80	1072830.00	5763.76	FOUND CDOT TYPE 2 MON.
US 6 CM-MP 271.50	39° 45' 13.63282" N	105° 14° 20.50102" W	1742.577	0' 09' 52.53219"	1.000000751	518024.580	936767.049	US 6 CM-MP 271.50	700104.33	1074455.08	5767.52	FOUND CDOT TYPE 2 MON.
US 6 CM-MP 271.60	39° 45° 15.81255" N	105° 14° 11.71986" W	1738.017	0' 09' 58.07038"	1.000000731	518092.410	936975.893	US 6 CM-MP 271.60	700371.34	1075140.51	5752.65	FOUND CDOT TYPE 5 MON.
SH 119 CM-MP 0.85	39° 45° 17.49117" N	105* 24* 21.66101" W	2126.646	0° 03' 33.38687"	1.000000072	518115.620	922456.036	SH 119 CM-MP 0.85	700447.52	1027486.56	7022.59	FOUND CDOT TYPE 2 MON.
NSRS D447	39° 44′ 43.45384″ N	105° 26' 20.00006" W	2189.349	0' 02' 18.75166"	0.999999094	517063.449	919639.665	NSRS D447	696994.31	1018243.27	7227.23	FOUND NGS VERT. DISK IN ROCK
NSRS E447	39° 44' 33.71370" N	105° 25' 51.40904" W	2186.362	0' 02' 36.78372"	0.999998564	516763.536	920320.598	NSRS E447	696010.00	1020478.09	7217.78	FOUND NGS VERT. DISK IN ROCK
NSRS FOUR	39° 44′ 54.72143″ N	105* 23' 57.33419" W	2097.600	0 03 48.72954"	0.999999710	517413.985	923035.918	NSRS FOUR	698144.76	1029389.72	6927.35	FOUND NGS HORZ. DISK IN ROCK
NSRS G447	39° 43′ 58.46489″ N	105° 25° 35.32795" W	2290.038	0° 02' 46.92590"	0.999996663	515676.711	920704.357	NSRS G447	692443.06	1021737.58	7557.84	FOUND NGS VERT. DISK IN ROCK
NSRS P100	39° 45' 19.30637" N	105° 24' 32.79069" W	2135.742	0' 03' 26.36749"	1.000001065	518171.334	922191.036	NSRS P100	700630.37	1026616.83	7052.35	FOUND NGS VERT. DISK IN ROCK
NSRS RMCL100	39° 42′ 37.86287" N	105° 17' 37.05125" W	2344.860	0' 07' 48.57002"	0.999992428	513208.391	932099.000	NSRS RMCL100	684342.07	1059134.62	7741.10	FOUND NGS GRAV. DISK IN CONC.
NSRS RMCL120	39° 43′ 28.65029″ N	105° 25' 03.21643" W	2379.550	0° 03' 07.17830"	0.999995079	514757.845	921469.850	NSRS RMCL120	689427.35	1024249.91	7851.62	FOUND NGS GRAV. DISK IN CONC.
NSRS RMCL40	39° 41° 45.57974" N	105° 12′ 35.38127" W	1970.705	0 10 58.83012"	0.999989763	511615.568	939289.962	NSRS RMCL40	679114.45	1082735.25	6516.19	FOUND NGS GRAV. DISK IN CONC.
NSRS RMCL60	39° 42' 03.42418" N	105° 14° 22.14132" W	2116.268	0° 09' 51.49767"	0.999990665	512158.198	936744.823	NSRS RMCL60	680895.35	1074382.14	6992.63	FOUND NGS GRAV. DISK IN CONC.
NSRS RMCL80	39° 42′ 42.62474″ N	105° 16' 11.65363" W	2235.924	0.08, 42.42940,	0.999992674	513360.139	934132.810	NSRS RMCL80	684840.10	1065809.55	7384.25	FOUND NGS GRAV. DISK IN CONC.
NSRS STOOGES	39° 44' 31.47367" N	105° 17' 12.80608" W	1850.430	0' 08' 03.86119"	0.999998442	516713.626	932668.303	NSRS STOOGES	695846.19	1061003.06	6119.49	FOUND NGS HORZ. DISK IN ROCK
NSRS THREE	39° 44' 29.18166" N	105° 19′ 45.44337″ W	1976.100	0' 06' 27.59445"	0.999998318	516635.259	929034.229	NSRS THREE	695588.99	1049076.09	6530.56	FOUND NGS HORZ. DISK IN ROCK
									1	1	1	

COOT Form #126Ro 7/00 COLORADO DEPARTMENT OF TRANSPORTATION US HIGHWAY NO. 6 MP 257.0 to MP 271.6 Project Control Diagram Sheet Revisions SITUATE IN SEC. 28, 32 & 33, T. 3 S., R. 70 W.,
SEC. 32, 33, 34, 35 & 36, T. 3 S., R. 71 W., SEC. 36, T. 3 S., R. 72 W.,
SEC. 6, T. 4 S., R. 70 W., SEC. 2, 3, 5 & 6, T. 4 S., R. 71 W., XXXXX Plan Sheet \overline{DOT} Region 1 Address: 18500 E. Colfax Ave. Project Number: STA 119A-048 Aurora, CO 80011 Phone: (303) 757–9744 FAX: (303) 757–9746 SEC. 1, T. 4 S., R. 72 W. OF THE 6TH P.M., COUNTY OF JEFFERSON, AND SEC. 34, 35 & 36, T. 3 S., R. 72 W., SEC. 1, 2 & 3, T. 4 S., R. 72 W. OF Project Location: US HWY 6 - MILEPOST 257.0 TO 271.6 Project Location: JEFFERSON & CLEAR CREEK COUNTIES THE 6TH P.M., COUNTY OF CLEAR CREEK, STATE OF COLORADO.
 Project Code:
 Lost Mod. Date
 Subset Sheets
 Sheet No.
 Total No. of Sheet

 14231
 10-18-04
 XXX of XXX
 6
 15
 Survey Unit: Joseph Conway NH 0061-078 **FOUND** MOUNTAIN SURVEYING & PC 15370 MAPPING, INC. NSRS FOUR SHEET 03C 8751 E. HAMPDEN AVE. SUITE B-1 DENVER, COLORADO 80231 (303) 306-1858 NGS HORZ. DISK IN ROCK SET N: 698144.76 SET US 6 CM-MP 259.80 E: 1029389.72 US 6 CM-MP 259.65 CDOT TYPE 2 MON. EL:6927.35 CDOT TYPE 2 MON. N: 697591.40 N: 697500.46 E: 1028632.40 E: 1027850.32 EL:6914.94 EL:6943.85 SET US 6 CM-MP 259.95 CDOT TYPE 2 MON. US 6 CM-MP 260.05 N: 697703.73 CDOT TYPE 2 MON. E: 1029124.59 N: 697301.38 EL:6916.74 E: 1029780.39 EL:6908.96 SET US 6 CM-MP 259.60 CDOT TYPE 2 MON. N: 696819.98 E: 1027621.32 EL:6974.89 US 6 CM-MP 260.20 SET CDOT TYPE 2 MON. US 6 CM-MP 260.60 N: 696609.04 CDOT TYPE 2 MON. E: 1029952.86 SET N: 695894.69 EL:6914.88 US 6 CM-MP 260.40 E: 1031803.64 CDOT TYPE 2 MON. EL:6868.25 N: 696249.42 E: 1030825.31 EL:6878.48 US 6 CM-MP 260.80 CDOT TYPE 2 MON. N: 694919.94 E: 1032020.81

EL:6866.01

Western states SURVEYING, Inc. 19029 EAST PLAZAD DRIVE, SUITE 252 PARKER, COLORADO BOISA (503) B41-7436

GPS COORDINATE SUMMARY TABLE (ADJUSTED FIELD DATA)

CONTROL SURVEY DIAGRAM

COLORADO DEPARTMENT OF TRANSPORTATION PROJECT NO. STR 0119-044

SR 119 - HWY. 6 to BLACKHAWK (MP 0.05-MP 7.30)

SECTIONS 7, 8, 17, 20, 21, 26, 27, 28, 35 & 36, T. 3 S., R. 72 W., 6th P.M.

GILPIN COUNTY, COLORADO

SHEET 1 OF 4

RIGHT OF WAY
PROJECT CONTROL DIAGRAM

STA 119A-044 GILPIN COUNTY

PROJECT CODE: 12878 SHEET NUMBER: 2

NH 0061-078 PC 15370 SHEET 03D

PROJECT COORDINATE SUMMARY TABLE (ADJUSTED FIELD DATA)

	GEODETIC COORDINATES				T	T			PROJE	PROJECT COORDINATE SUMMARY TABLE		(ADJUSTED	FIELD DATA	4)	
POINT NAME	NAD-83(92) (CHARN)		ELEV. m (NAVD '88)	MAPPING ANGLE	SCALE	NAD 83(92)	ZONE 0502	DESCRIPTION	POINT	NAD 83(92)	ZONE 0502	ELEV. m	PROJECT	COORDINATES	ELEV. ft.
	LATITUDE	LONGITUDE				NORTHING m			NO.	NORTHING m	EASTING m	(NAVD '88)	NORTHING ft	EASTING ft	(NAVD '88)
CM-MP 0.05 GPS PROJECT STATION CM-MP 0.20 GPS PROJECT STATION	39° 44' 52.0154" N	1 105° 23' 53.3054" W 1 105° 23' 55.8765" W	2108.453	0° 03' 51.270"	0.999999562	517330.632	923131.920	SET: CDOT TYPE 2 CONTROL MONUMENT	5	517330.632	923131.920	2108 453	1607071 101	3029704.769	16017 404
CM-MP 0.40 GPS PROJECT STATION	39° 45' 00.2482" N	105° 23' 59.1849" W	2115.715 2123.192	0° 03' 49.649"	1.000000014	1 51/584.481	1923070.423	FOUND: CDOT TYPE 2 CONTROL MONIMENT	20	517584.481	923070.423	2115.715	1698704 310	3029704.769	6917.484
CM-MP 0.60 GPS PROJECT STATION		105° 24' 07.4351" W	2123.192	0° 03' 47.562" 0° 03' 42.359"	1.000000417	1 51/810.480	11 922 991 . 411	FOUND: CDOT TYPE 2 CONTROL MONIMENT	40	517810.480	922991.411	2123.192	1699446.034	3029243.620	6965 839
CM-MP 0.75 GPS PROJECT STATION		105° 24' 13.8215" W	2134.208	0° 03' 42.339"	1.000000862	1 51/935.026	1922/94.874	ISET: CDOT TYPE 2 CONTROL MONIMENT 1	60	517935.026	922794.874	2128.961	1699854.793	3028598.591	6984 765
CM-MP 0.85 GPS PROJECT STATION		105° 24' 21.6607" W	2140.491	0° 03' 33.387"	1.000000862	518058.690	922642.708	SET: CDOT TYPE 2 CONTROL MONUMENT	75	518058.690	922642.708	2134.208	1700260.657	3028099.184	17001.981
CM-MP 1.00 GPS PROJECT STATION	39° 45' 19.3062" N	105° 24' 32.7901" W	2149.561	0° 03' 26.368"	1.000000365	510113.01/	922456.036	SET: CDOT TYPE 2 CONTROL MONUMENT	85	518115.617	922456.036	2140.491	1700447.489	13027486.528	17022 593
CM-MP 1.15 GPS PROJECT STATION		1 105° 24' 38.6333" W	2155.548	0° 03' 22.682"		518431 411	922191.043	SET: CDOT TYPE 2 CONTROL MONUMENT SET: CDOT TYPE 2 CONTROL MONUMENT	100	518171.335	922191.043	2149.561	1700630.356	3026616.825	7052.353
CM-MP 1.30 GPS PROJECT STATION		1 105° 24' 45.5657" W	2160.280	0° 03' 18.310"	1.000001759	518556 352	921886 552	SET: CDOT TYPE 2 CONTROL MONUMENT	115	518431.411	922051.692	12155.5481	1701483.920	13026159.478	17071 995
CM-MP 1.50 GPS PROJECT STATION		N 105° 24' 57.3934" W	2175.185	0° 03' 10.851"	1.000002152	518773.189	1921604.808	ISET: CDOT TYPE 2 CONTROL MONIMENT !	130 150	518556.352	921886.552	2160.280	1701893.974	3025617.490	7087.517
CM-MP 1.65 GPS PROJECT STATION		1 105° 25' 06.6404" W	2178.176	0° 03' 05.019"	1.000002252	1 318828.143	1921384.652	ISET: COOT TYPE 2 CONTROL MONIMENT 1	165	518773.189	921604.808	2175.185	1702605.632	3024692.811	7136.419
CM-MP 1.75 GPS PROJECT STATION		N 105° 25' 15.8858" W	2186.403	0° 02' 59.188"		1 218832.143	1921164.581	ISET: CDOT TYPE 2 CONTROL MONIMENT 1	175	518835.143	921384.652 921164.581	21/8.1/6	1702785.990	3023970.265	7146.233
CM-MP 1.90 GPS PROJECT STATION CM-MP 2.10 GPS PROJECT STATION		1 105° 25' 25.8319" W	2195.274	0° 02' 52.915"	1.000002510	1 5189/0.054	1920927.723	ISET: CDOT TYPE 2 CONTROL MONUMENT	190	518970.054		2100.403	1702808.962	3023247.995 3022470.629	7173.225
CM-MP 2.10 GPS PROJECT STATION	39° 45' 49./516" N	N 105° 25' 36.4328" W N 105° 25' 43.7945" W	2205.205	0° 02' 46.229"		1 213108.323	19206/5.277	ISET: CDOT TYPE 2 CONTROL MONIMENT	210	519108.953	920675.277	2205 205	1703231.737	3021642.104	1202.327
CM-MP 2.30 GPS PROJECT STATION		N 105° 25' 51.2306" W	2211.150 2214.074	0° 02' 41.586"		1 519058.3/4	1920500.092	ISET: CDOT TYPE 2 CONTROL MONIMENT	220		920500.092	2211.150	1703707.002	3021042.104	7254 415
CM-MP 2.40 GPS PROJECT STATION	39° 45' 46 7257" N	1105° 25' 54 6179" W	2215.650	0° 02' 36.896" 0° 02' 34.760"		519090.112	920323.072	SET: CDOT TYPE 2 CONTROL MONUMENT	230	519090.112	920323.072	1 2214.074	11703645.766	13020486.173	R17264 NN71
CM-MP 2.50 GPS PROJECT STATION	39° 45' 44.1147" N	105° 26' 01.3489" W	2220.854	0° 02' 30.515"	1.000002594	519015.285	920242.510	SET: CDOT TYPE 2 CONTROL MONUMENT	240	519015.285	920242.510	2215.650	1703400.186	3020221.769	9 7 7 2 6 9 . 1 7 8 1
CM-MP 2.60 GPS PROJECT STATION	39° 45' 43.8454" N	N 105° 26' 08.0452" W	2225.615	0° 02' 26.291"	1.000002447	510034.041	920082.352	SET: CDOT TYPE 2 CONTROL MONUMENT	250	518934.641	920082.352	2220.854	11703135.513	13019696.134	1 7286.253 L
CM-MP 2.70 GPS PROJECT STATION	39° 45' 41.3128" N	N 105° 26' 11.2573" W	2231.636	0° 02' 24.266"	1.000002432	518848 057	919846 567	SET: CDOT TYPE 2 CONTROL MONUMENT SET: CDOT TYPE 2 CONTROL MONUMENT	260	518926.221	919922.969	2225.615	1703107.880	13019173.042	77301 871
CM-MP 2.80 GPS PROJECT STATION	39° 45' 39.6464" N	N 105° 26' 15.1636" W	2235.502	0° 02' 21.802"		518796.598	91 9753 .621	SET: CDOT TYPE 2 CONTROL MONUMENT	270	518848.057	919846.567	1 2231.636	1702851.347	13018922.291	7321 626
CM-MP 2.90 GPS PROJECT STATION		N 105° 26' 21.7709" W	2239.969	0° 02' 17.635"		518890.711	919596.285	SET: CDOT TYPE 2 CONTROL MONUMENT	280 290		919753.621	2235.502	1702682.458	3018617.245	5 7 3 3 4 . 3 1 0 1
CM-MP 3.15 GPS PROJECT STATION	39° 45' 48.4304" N	N 105° 26' 34.4619" W	2251.761	0° 02' 09.631"	1.000002689	1 519067.211	.1919294.092	ISET: CDOT TYPE 2 CONTROL MONIMENT	315		919596.285	2239.969	1702991.335	3018100.871	7348.965
CM-MP 3.25 GPS PROJECT STATION	39° 45' 48.9769" N	N 105° 26' 41.4648" W	2258.812	0° 02' 05.214"		1 519083.965	1919127.392	SET: CDOT TYPE 2 CONTROL MONIMENT	325	519087.211	919294.092 919127.392	2251.761	1703570.608	3017109.078	3 7387.654
CM-MP 3.40 GPS PROJECT STATION CM-MP 3.60 GPS PROJECT STATION		N 105° 26' 51.1986" W	2269.749	0° 01' 59.075"		1 319286.335	11 918895.592	ISET: CDOT TYPE 2 CONTROL MONIMENT 1	340	519286 339	918895.592	2260 740	1703625.593	3016561.971 3015801.205	7410.785
CM-MP 3.65 GPS PROJECT STATION		N 105° 26' 54.6503" W N 105° 26' 52.9527" W	2277.704	0° 01' 56.898"		1 519498.088	81918813.318	I SET: CDOT TYPE 2 CONTROL MONIMENT	360	519498.088	918813.318	2277 704	1704209.703	3015801.205	7446.669
CM-MP 3.75 GPS PROJECT STATION		N 105° 26' 53.1842" W	2279.987 2283.614	0° 01' 57.969"		1 519610.575	1918853.656	SISET: CDOT TYPE 2 CONTROL MONIMENT	365	519610.575	918853.656	2279.987	1705353.919	3015663.572	7480 257
CM-MP 3.85 GPS PROJECT STATION		N 105° 26' 58.0943" W	2289.834	0° 01' 57.823" 0° 01' 54.726"		1 519/13.425	H 918848.083	SISET: CDOT TYPE 2 CONTROL MONUMENT	375	519713.429	918848.083	2283.614	11705691.485	13015645-281	17492 158
CM-MP 3.95 GPS PROJECT STATION		N 105° 27' 04.9631" W	2297.124	0° 01' 50.394"		1 219803.069	H 918 / 31.1 / 1	ISET: CDOT TYPE 2 COMPROI MONITIMENT !	385	519803.069	918731.171	2289.834	1705985.680	13015261 580	17512 564
CM-MP 4.10 GPS PROJECT STATION	39° 46' 22.9986" 1	N 105° 27' 08.8192" W	2302.609	0° 01' 47.962"	1.000004343	520132 974	010475 744	SET: CDOT TYPE 2 CONTROL MONUMENT	395	519970.338	918567.603	2297.124	11706534.657	13014724.753	17536 481
CM-MP 4.20 GPS PROJECT STATION	39° 46' 28.1426" 1	N 105° 27' 11.3989" W	2309.276	0° 01' 46.335"		520291 496	918414 260	SET: CDOT TYPE 2 CONTROL MONUMENT SET: CDOT TYPE 2 CONTROL MONUMENT	410	520132.876	918475.746	1 2302 . 609	11707068.102	13014423 277	1 7554 477
CM-MP 4.30 GPS PROJECT STATION	39° 46' 31.9795" 1	N 105° 27' 16.4179" W	2314.568	0° 01' 43.169"	1.000005155	520409.769	918294.765	SET: CDOT TYPE 2 CONTROL MONUMENT	420	520291.496	918414.269	1 2309.276	1707588.690	13014221 510	17576 349
CM-MP 4.35 GPS PROJECT STATION	39° 46' 34.6497" 1	N 105° 27' 22.0177" W	2320.657	0° 01' 39.638"	1.000005307	1 520492.058	31918161.461	ISET: CDOT TYPE 2 CONTROL MONUMENT	430 435	520409.769	918294.765	2314.568	1707976.863	3013829.303	7593.712
CM-MP 4.40 GPS PROJECT STATION	39° 46' 36.8431" 1	N 105° 27' 24.9742" W N 105° 27' 30.3663" W	2323.852	0° 01' 37.773"		1 520559.673	31918091.070	ISET: CDOT TYPE 2 CONTROL MONUMENT	440	520492.038	918161.461 918091.070	2320.657	1708246.934	3013391.799	7613.689
CM-MP 4.50 GPS PROJECT STATION CM-MP 4.65 GPS PROJECT STATION	39° 46' 41.9985" 1	N 105° 27' 30.3663" W	2331.309	0° 01' 34.372"	11.000005728	520718.615	1917962.678	SISET: CDOT TYPE 2 CONTROL MONIMENT	450	520718 615	917962.678	2323.852	1708468.845	3013160.776 3012739.398	7624.170
CM-MP 4.05 GPS PROJECT STATION	300 461 40 370611	N 105° 27' 41.5998" W N 105° 27' 44.4357" W		0° 01' 27.287"		1 520816.921	1917695.313	ISET: COOT TYPE 2 CONTROL MONIMENT	465	520816.921	917695.311	2337 090	1700990.491	3012739.398	7648.636
CM-MP 5.05 GPS PROJECT STATION		N 105° 27' 49.0373" W	2340.718	0° 01' 25.499"		1 520942.753	31917627.774	ISET: CDOT TYPE 2 CONTROL MONIMENT	475	520942.753	917627.774	2340.718	1709313.126	3011640.246	7670 504
CM-MP 5.25 GPS PROJECT STATION	39° 47' 10.9257" 1	N 105° 27' 57.3942" W	2363.607	0° 01' 22.597' 0° 01' 17.326'	1.000006828	521307.376	917518.126	SET: CDOT TYPE 2 CONTROL MONUMENT	505	521307.376	917518.126	1 2354 . 727	11710922 794	13011280 384	17725 467 1
CM-MP 5.55 GPS PROJECT STATION	39° 47' 20.9524" 1	N 105° 28' 07.6540" W	2371.330	0° 01' 10.855'		521010.519	91/319.160	SET: CDOT TYPE 2 CONTROL MONUMENT	525	521610.519	917319.160	1 2363.60/	11711917.703	13010627.380	17754 601 [
CM-MP 5.80 GPS PROJECT STATION	39° 47' 30.4673" 1	N 105° 28' 17.2346" W	2383.088	0° 01' 04.813'		522213 053	91/0/4.92	SET: CDOT TYPE 2 CONTROL MONUMENT SET: CDOT TYPE 2 CONTROL MONUMENT	555	521919.668	1917074.926	1 2371.330	1712932.326	13009825 807	17779 940
CM-MP 5.95 GPS PROJECT STATION		N 105° 28' 27.4973" W	2393.438	0° 00' 58.340'	11.000008983	1 522448 334	916602 63	SET: CDOT TYPE 2 CONTROL MONUMENT	580 595	522213.053	916846.878	1 2383.088	11713895-213	13009077 359	17818 5141
CM-MP 6.05 GPS PROJECT STATION	39° 47' 42.2721" 1	N 105° 28' 28.5858" W	2397.726	0° 00' 57.654'	11.000009229	522577.051	11916576.699	HISET: CDOT TYPE 2 CONTROL MONIMENT	605	522448.334	916602.637	1 2393,438	11714667.400	13008275 762	17852 470
CM-MP 6.15 GPS PROJECT STATION		N 105° 28' 33.1771" W	2407.190	0° 00' 54.758'	1.000009542	522741.338	31916467.428	SISET: CDOT TYPE 2 CONTROL MONUMENT	615	522577.051 522741.338		2397.726	1715089.848	3008190.637	7866.541
CM-MP 6.30 GPS PROJECT STATION CM-MP 6.40 GPS PROJECT STATION	39° 47' 52.0369" !	N 105° 28' 36.4488" W		0° 00' 52.695'		1 522878.166	51916389.554	ISET COOT TYPE 2 CONTROL MONITORING	630	522878 166	916467.428 916389.554	2407.190	1715629.037	3007832.010	7897.588
CM-MP 6.40 GPS PROJECT STATION	39 47 33.2431" 1	N 105° 28' 45.2501" W N 105° 28' 55.6372" W	2419.569	0° 00' 47.143'		1 322913.373	01916180.14	LISET: CDOT TYPE 2 CONTROL MONIMENT	640	522915.375	916180.141	2410.024	1716200 222	300/5/6.428	7908.856
CM-MP 6.80 GPS PROJECT STATION	39° 47' 56 7786"	N 105° 29' 11.4922" W	2426.120 2436.882	0° 00' 40.592'	1.000010016	1 522989.076	01915933.013	SET: COOT TYPE 2 CONTROL MONUMENT	655	522989.076	915933.012	2426, 120	1716442 109	3006078.065	7950.203
CM-MP 6.95 GPS PROJECT STATION		N 105° 29' 20.2956" W	2444.185	0° 00' 30.593' 0° 00' 25.041'		523024.239	915555.81	SET: CDOT TYPE 2 CONTROL MONUMENT	680	523024.239	915555.816	2436.882	1716557.510	3004840.112	7995 004
CM-MP 7.10 GPS PROJECT STATION	39° 48' 01.1569" i	N 105° 29' 27.0479" W	2449.707	0° 00' 20.782'		1 523055.978	51915346.380	DISET: CDOT TYPE 2 CONTROL MONIMENT	695	523055.976	915346.380	2444.185	1716661.672	13004152 747	18018 962
CM-MP 7.20 GPS PROJECT STATION	39° 48' 04.3744" 1	N 105° 29' 31.8639" W	2453 993	0° 00' 17.744'		523258 454	2 313183.73.	2 SET: CDOT TYPE 2 CONTROL MONUMENT	710	523159.232	915185.732	12449 707	11717000 555	13003635 501	10027 0021
CM-MP 7.30 GPS PROJECT STATION	39° 48' 07.3957" 1	N 105° 29' 37.0399" W	2455.538	0° 00' 14.480'		523351 620	914948 00	SET: CDOT TYPE 2 CONTROL MONUMENT SET: CDOT TYPE 2 CONTROL MONUMENT	720	523258.456	915071.143	1 2453, 9931	11717326.207	13003249 424	18051 1421
FARID NGS HOR CONTROL STATION	39° 47' 55.8146"	N 105° 29' 04.5328" W	2430.522	0° 00' 34.982'	" 1.000010027	1 522994 52	81915771 38	I FOUND: NCC HORTZONERY COMMENT DOTHER	1/30	1223331.629	1914948.003	1 2455.538	1717632.001	13002845.280	18056.2121
FOUR NGS HOR CONTROL STATION	39° 44' 54.7213"	N 105° 23' 57.3336" W		0° 03' 48.730'	" 0.999999710	1 51/413 98	51 923035 91	SI FOUND. NOC HODITONING COMMON MOTION	1 1000	522994.528	1915/21.381	2430.522	1716460.000	3005383.496	7974.139
HIRSCFELD NGS HOR. CONT. STA.	1 39" 45' 47.1485"	N 105° 26' 27.6288" W		1 0 02 13.940	<u>" 1.0000026</u> 17	519027.77	8 919456.76	1 FOUND: NGS HORIZONTAL CONTROL POINT	950	519027 770	923035.918 919456.761	1	1598144.744	3029389.693	1
BASIS OF BEARINGS: Bearings	used in the calcula	ation of coordinates o	are based	on a arid				77-11/02 2 02112	609	Found 3 1/4	4" CDOT Alum.	_[17153441.18/	3017642.954 3008208.044	7070 130
bearing of N 52°39'31" W from	m NGS FOUR to No	GS FARID as obtained	l from a (Slobal			OF TRANS			Cap CM-MP	6.10			3000200.044	1019.139

BASIS OF BEARINGS: Bearings used in the calculation of coordinates are based on a grid bearing of N 52°39'31" W from NGS FOUR to NGS FARID as obtained from a Global Positioning System (GPS) survey based on the Colorado High Accuracy Reference Network (CHARN).

BASIS OF ELEVATIONS: Project is based on National Geodetic Survey Benchmark C 164 RESET 1938. The orthometric height was determined by differential leveling by the NGS in June of 1991. Elevation is 8105.00 (NAVD 88 Datum).

COORDINATE DATUM: Project coordinates are modified state plane central zone NAD '83 (92) coordinates. The combined factor used to modify the coordinates was 0.999649198. Conversion equation is (SPC(m)*3.2808333)/0.999649198=local coordinates. The CHARN is based on the NAD '83(92) datum.

NOTICE: According to Colorado law you must commence any legal action based upon any defect in this survey within three years after you first discover such defect. In no event, may any action based upon any defect in this survey be commenced more than ten years from the date of the certification shown hereon.



not to scale

△ Control Monument Cap

△ CM-MP - Control Monuments were set by

Western States Surveying, Inc., and were Type 2

monuments, a 3-1/4" dia. aluminum control monument minimum horizontal control tolerances of a Type "Of cap (as shown) on a 3' x 3/4" dia. finned aluminum rod on a 3' x 3/4" dia. smooth aluminum rod, or driven

NOTE: This survey is not a complete boundary survey or right—of—way survey and is prepared for CDOT purposes only.

No warranty is implied or expressed.

SURVEYORS STATEMENT: I, Charles N. Beckstrom, a Professional time of Colorado, hereby state that this Control Survey between was project under my supervision this 21st day of December, 1999, from the survey performed under my supervision from September 1st through 30th, 1995 for and survey performed under States Surveying, Inc., and is not a Land Survey Plat to Blant—of—Way Survey Plat and to the best of my knowledge and belief this control survey as shown not the minimum horizontal control tolerances of a Type "B"/Survey.

Charles N. Beckstrom L.S. 33202

atestamp

TATE OF COLORADO D.O.T. FORM 126Ra EVISED: JULY 1996

19___, AT ___,M., FOR INFORMATIO

DAY OF THE OF THE

CONTROL SURVEY DIAGRAM

RIGHT OF WAY PROJECT CONTROL DIAGRAM STA 119A-044 GILPIN COUNTY PROJECT CODE: 12878 SHEET NUMBER: 2A

COLORADO DEPARTMENT OF TRANSPORTATION PROJECT NO. STR 0119-044

SR 119 - HWY. 6 to BLACKHAWK (MP 0.05-MP 7.30)

SHEET 2 of 4

CM-MP 1.30


CM-MP 1.00

100

115 CM-MP 1.15

SECTIONS 7, 8, 17, 20, 21, 26, 27, 28, 35 & 36, T. 3 S., R. 72 W., 6th P.M. GILPIN COUNTY, COLORADO

NH 0061-078 PC 15370 SHEET 03E

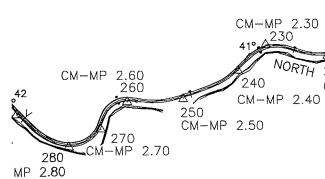

_^230

NORTH 220

Typical Control Monument Cap NOT TO SCALE

CM-MP 2.20

CM-MP - Control Monuments were set by Western States Surveying, Inc. They were CDOT Type 2 monuments, a 3-1/4" dia. aluminum control monument cap (as shown) on a 3' \times 3/4" dia finned aluminum rod on a 3' x 3/4" dia. smooth aluminum rod or to refusal.

CM-MP 2.10

CM-MP 1.90

CM-MP 1.75 175

CM-MP 1.65

165

CM-MP 1.50

210



 □ Typical NGS Horizontal Control Cap NOT TO SCALE

°34 Property / R-O-W monument. Stamped as shown below.

75 CM-MP 0.075 808	
CM-MP 0.60 30 29 40 CM-MP 0.40	
FOUR MANAGEMENT STORY OF THE PROPERTY OF THE P	To Golde
TUNNEL #4	
To Interstate 70 U.S. HIG	B YAWH;

2000

500 1000

CM-MP 0.85

SCALE: 1'' = 1000'

PT. No.	NORTHING	EASTING	ELEV.	DESCRIPTION
29	1699515.026	3029197.646	6976.106	1" YELLOW PLASTIC CAP ON # 4 REBAR M.W. RUST LS 6630 UP 0.1
30	1699616.079	3029067.861	6971.094	4"X4"X2.4' HIGH CONCRETE MONUMENT # 500
31	1699806.185	3028824.812	6992.703	1" YELLOW PLASTIC CAP ON # 4 REBAR M.W. RUST LS 6630 UP 0.5
32	1700227.055	3028285.395	7003.083	4"X4"X2' HIGH CONCRETE MONUMENT # 510
33	1701087.625	3026484.942	7067.413	3/4" RED PLASTIC CAP ON #3 REBAR CO. SIERRA PLS 22094 UP 0.2
34				4"X4"X2.5' HIGH CONCRETE MONUMENT # 550
35	1702370.210	3024818.373	7111.935	1 1/4" RED PLASTIC CAP ON #5 REBAR CO. SIERRA LS 22094 UP 0.2
36	1702821.992	3024209.887	7143.860	4"X4"X2.5' HIGH CONCRETE MONUMENT # 550
37	1702712.481	3023997.095	7132.412	1 1/4" RED PLASTIC CAP ON #5 REBAR CO. SIERRA LS 22094 UP 0.2
38				1 1/4" RED PLASTIC CAP ON #5 REBAR CO. SIERRA LS 22094 UP 0.5 LOOSE IN CLIFF
39	1702874.847	3023240.360	7180.658	4"X4"X2.4' HIGH CONCRETE MONUMENT # 570
41	1703655.962	3020372.539	7274.156	4"X4"X3' HIGH CONCRETE MONUMENT # 600
808	1699986.840	3028420.780	6991.161	2" ALUMINUM CAP ON #4 REBAR WSSI CP 808
809	1703453.390	3022134.020	7216.749	2" ALUMINUM CAP ON #4 REBAR WSSI CP 809

western states 19029 EAST PLAZA DRIVE, SUITE 252 PARKER. COLORADO 80134 (303) 841-7436

To Golden

CDOT Form

COLORADO DEPARTMENT OF TRANSPORTATION

DOT Region Address: Aurora,

DOT Region One Address: 18500 E. Colfax Ave. Aurora, CO 80011

Phone: (303) 757–9744 FAX: (303) 757–9746

Survey Coordinator: Joseph P. Conway

	Sheet Revisions	
/уу	XXXXX	XXX
-		

S.H. 119 MP 1.60 to MP 6.55 Sec's 7,8,17,20,21,28,27,26 T.3 S. R.72 W. GILPIN COUNTY COLORADO

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			Pr
200 100 0	200	400	Pr
200 100 0			Pr
CCAL	E: 1"=200'		Pro
SCAL	E: 1 = 200		

NOTE: THIS DREXEL BARRELL SURVEY CONTROL DIAGRAM (2003) IS SUPPLEMENT TO THE WESTERN STATES CONTROL SURVEY DIAGRAM (1999)

PROJECT COORDINATE SUMMARY TABLE (ADJUSTED FIELD DATA) IN FEET

(112	DOOD I LD					
POINT NAME		OORDINATES	ELEV(ft)	DESCRIPTION		
LIV / V 110 CM MD 1 20	NORTHNG (ft)	EASTING (ft)	7007 517	CDOT TYPE 2 CONTROL MONUMENT		
HWY 119 CM-MP 1.30	1701893.97	3025617.49	7087.517			
HWY 119 CM-MP 1.50	1702605.63	3024692.81	7136.419	CDOT TYPE 2 CONTROL MONUMENT		
HWY 119 CM-MP 1.60	1702781.75	3024110.71	7142.574	CDOT TYPE 2 CONTROL MONUMENT		
HWY 119 CM-MP 1.65	1702785.96	3023970.30	7146.252	CDOT TYPE 2 CONTROL MONUMENT		
HWY 119 CM-MP 1.71	1702791.00	3023326.82	7170.746	CDOT TYPE 2 CONTROL MONUMENT		
HWY 119 CM-MP 1.80	1702876.16	3023055.30	7178.819	CDOT TYPE 2 CONTROL MONUMENT		
HWY 119 CM-MP 1.85	1703118.45	3022672.31	7193,222	CDOT TYPE 2 CONTROL MONUMENT		
HWY 119 CM-MP 2.11	1703704.45	3021678,22	7233.852	CDOT TYPE 2 CONTROL MONUMENT		
HWY 119 CM-MP 2.21	1703535.40	3021008.68	7255.191	CDOT TYPE 2 CONTROL MONUMENT		
HWY 119 CM-MP 2.30	1703645.77	3020486.17	7264.033	CDOT TYPE 2 CONTROL MONUMENT		
HWY 119 CM-MP 2.41	1703292.33	3020091.98	7274.353	CDOT TYPE 2 CONTROL MONUMENT		
HWY 119 CM-MP 2.51	1703127.38	3019721.63	7285.293	CDOT TYPE 2 CONTROL MONUMENT		
HWY 119 CM-MP 2.61	1703103.38	3019176.57	7302.911	CDOT TYPE 2 CONTROL MONUMENT		
HWY 119 CM-MP 2.71	1702873.35	3018930.24	7319,837	CDOT TYPE 2 CONTROL MONUMENT		
HWY 119 CM-MP 2.81	1702680.37	3018654.83	7333,510	CDOT TYPE 2 CONTROL MONUMENT		
HWY 119 CM-MP 2.85	1702859.46	3018308.07	7342.963	CDOT TYPE 2 CONTROL MONUMENT		
HWY 119 CM-MP 2.95	1703186.61	3017988.37	7355.414	CDOT TYPE 2 CONTROL MONUMENT		
HWY 119 CM-MP 3.10	1703545.66	3017402.05	7378.839	CDOT TYPE 2 CONTROL MONUMENT		
HWY 119 CM-MP 3.26	1703626.48	3016574.48	7409.997	CDOT TYPE 2 CONTROL MONUMENT		
HWY 119 CM-MP 3.39	1704211.31	3015863.15	7443,557	CDOT TYPE 2 CONTROL MONUMENT		
HWY 119 CM-MP 3.61	1704987.01	3015543.34	7472.973	CDOT TYPE 2 CONTROL MONUMENT		
HWY 119 CM-MP 3.72	1705605.23	3015725.16	7493.189	CDOT TYPE 2 CONTROL MONUMENT		
HWY 119 CM-MP 3.84	1705987.60	3015285.56	7511.162	CDOT TYPE 2 CONTROL MONUMENT		
HWY 119 CM-MP 3.96	1706562.86	3014706.97	7536.981	CDOT TYPE 2 CONTROL MONUMENT		
HWY 119 CM-MP 4.15	1707286.74	3014300.70	7564.554	CDOT TYPE 2 CONTROL MONUMENT		
HWY 119 CM-MP 4.31	1707994.13	3013813.07	7594.603	CDOT TYPE 2 CONTROL MONUMENT		
HWY 119 CM-MP 4.36	1708252.66	3013367.26	7615.300	CDOT TYPE 2 CONTROL MONUMENT		
HWY 119 CM-MP 4.45	1708849.59	3012846.13	7641.641	CDOT TYPE 2 CONTROL MONUMENT		
HWY 119 CM-MP 4.66	1709353.61	3011820.35	7668.355	CDOT TYPE 2 CONTROL MONUMENT		
HWY 119 CM-MP 5.04	1710868.27	3011289.90	7723.787	CDOT TYPE 2 CONTROL MONUMENT		
HWY 119 CM-MP 5.26	1712004.24	3010561.72	7756.686	CDOT TYPE 2 CONTROL MONUMENT		
HWY 119 CM-MP 5.56	1713025.36	3009781.37	7781.932	CDOT TYPE 2 CONTROL MONUMENT		
HWY 119 CM-MP 5.81	1713895.37	3009059.47	7819.523	CDOT TYPE 2 CONTROL MONUMENT		
HWY 119 CM-MP 5.96	1714674.62	3008274.06	7853.172	CDOT TYPE 2 CONTROL MONUMENT		
HWY 119 CM-MP 6.06	1715240.10	3008176.79	7873.247	CDOT TYPE 2 CONTROL MONUMENT		
HWY 119 CM-MP 6.10	1715349.18	3008208.10	7879.116	CDOT TYPE 2 CONTROL MONUMENT		
HWY 119 CM-MP 6.16	1715609.62	3007858.92	7897.242	CDOT TYPE 2 CONTROL MONUMENT		
HWY 119 CM-MP 6.29	1716064.87	3007672.40	7910.688	CDOT TYPE 2 CONTROL MONUMENT		
HWY 119 CM-MP 6.40	1716200.22	3006889.14	7938.186	CDOT TYPE 2 CONTROL MONUMENT		
HWY 119 CM-MP 6.55	1716442.11	3006078.07	7959.696	CDOT TYPE 2 CONTROL MONUMENT		
	1					

CONSTRUCTION SURVEYING AND MONUMENTATION REQUIREMENTS:

- 1). This Control Survey Diagram represents the horizontal and vertical control for the project established by the Division. It is possible that some of the survey control monuments listed have been disturbed or obliterated. It is the Contractor's responsibility to verify the existence and stability of the control monuments before submitting a bid price.
- 2). All Type 1 and Type 2 monuments shall be set flush with the ground. Witness posts shall be installed 1 foot from and facing all Type 1 and Type 2 monuments, or as directed by the Project Engineer.
- Installation of Type 3 and Type 3-A monuments shall be completed in the sane day that installation is commenced. Under no circumstances shall holes in the roadway be left open overnight.
- 4). When Installing Type 3-A monuments, the aluminum access cover shall be positively secured to the PVC pipe with screws or glue. The access cover shall be caulked with asphalt caulking between the cover and the edges of the roadway surface to provide a positive moisture barrier around the access cover.
- Control survey procedures, statistical analysis, and accuracy obtained for horizontal and vertical control shall be documented in the field book.
- 6). Legible copies of the field books shall be submitted to the Project Engineer for review on a monthly basis.
- 7). It is ultimately the prime Contractors responsibility to insure that these requirements, as well as any contained in the CDOT specifications, project special provisions, and CDOT Survey Manual are fulfilled under this contract.
- 8). The minimum staking intervals for each item are described on the plans or in the CDDT Survey Manual. If the contractor wishes to reduce the minimum intervals, a Contract Modification Order must be negotiated and the cost of the item reduced accordingly.

BASIS OF BEARINGS: Bearings were based upon existing control monuments, MP 1.30, MP 1.50, MP 2.30, MP 6.40 AND MP 6.55. Project control coordinates used were obtained from a survey by Jehn and Assoc. for the Blackhawk Sanitary Interceptor project.

BASIS OF ELEVATIONS: Project is based on a elevation of 8105.00 on NGS benchmark C164 reset 1938. The orthometric height was determined by differential levelling by the NGS in June of 1991.

COORDINATE DATUM: Coordinates on this project are for the exlusive use of the CDOT for the construction of this project and are considered Project Coordinates only.



CP - Control Point Monuments. They were CDDT type 2 monuments, a 3-1/4" dia. aluminum control monument cap (as shown) on a 3' X 3/4" dia. finned aluminum security rod on a 3' X 3/4" dia. smooth aluminum rod.

NOTE: This control survey is for the use of the Colorado Department of Transportation personnel. The survey is not a complete Boundary Survey. Title Policy, Title Commitment, and Title Research were not part of this control survey, therefore, easements, rights, and restrictions of record are not shown. The verification of the physical evidence with relation to easements, rights of way, property boundaries, and restriction, as described in the instruments of record, were not included in this control survey.

NOTE: According to Colorado law you must commence any legal action based upon any defect in this survey within three years after you first discover such defect. In no event may any action based upon any defect in this survey be commenced more than ten years from the date of the statement shown.

NOTE: No guarantee as to the accuracy of the information contained on the attached drawing is either stated or implied unless this copy bears an original signature of the professional land surveyor hereon named.

SURVEYORS STATEMENT: I, Earl F. Henderson, a Professional Land Surveyor in the State of Colorado, hereby state that this Control Survey Diagram was prepared under my direct supervision this 8th day of July 2003, from a field survey performed under my supervision and checking for and on behalf of the Department of Transportation, State of Colorado, and is not a Land Survey Plat or Right-of-Way Survey Plat and to the best of my knowledge and belief this control survey, as shown, meets the minimum horizontal control tolerances of a Type B Survey.



EARL F. HENDERSON PLS #34933



Region One
Address: 18500 E. Colfax Ave.
Aurora, CO 80011
Phone: (303) 757-9744 FAX: (303) 757-9746

Survey Coordinator: Joseph P. Conway

	Sheet Revisions	
mm/yy	XXXXX	XXX
		
1 1		

S.H. 119 MP 1.60 to MP 6.55 Sec's 7,8,17,20,21,28,27,26 T.3 S. R.72 W. GILPIN COUNTY COLORADO

				Sur
#				
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200 100 0	200	400	Project Lo	cation:
200 100 0	200	#00	Project Lo	cation:
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SCALE:	1"=200'		XXXXX	08-06

rvey Control Diagram Plan Sheet Proj Loc. od. Date | Subset Sheets | Sheet No. | Total No. of Sheets | Sheets No. | Total No. of Sheet

GEODETIC COORDINATE SUMMARY TABLE (ADJUSTED FIELD DATA)


DEINIT NIAME	GEODETIC COORDINATES NAD-83(92) (CHARN		ELLIP.	TELEV.	ELEV. MAPPING	CCALE	NAD 83(92) ZONE 0502		
POINT NAME	LATITUDE(N)	LONGITUDE(W)	HEIGHT	(NAVD '88)m	ANGLE	SCALE	NORTHING (m)	EASTING (m)	
HWY 119 CM-MP 1.30	39°45′31.79956″	105°24′45.56634″	2146.430	2160.280	0°03′18.31002″	1.000001759	518556.347	921886.542	
HWY 119 CM-MP 1.50	39°45′38.83881″	105°24′57.39396″	2161.356	2175.185	0°03′10.85047″	1.000002152	518773.184	921604.799	
HWY 119 CM-MP 1.60	39°45′40.58398″	105°25′04.84317″	2163.246	2177.061	0°03′06.15233 ″	1.000002250	518826.846	921427.436	
HWY 119 CM-MP 1.65	39°45′40.62683″	105°25′06,64046″	2164.370	2178.182	0°03′05.01880″	1.000002252	518828.129	921384.654	
HWY 119 CM-MP 1.71	39°45′40.68226″	105°25′14.87736″	2171.852	2185.648	0°02′59.82387″	1.000002255	518829.665	921188.590	
HWY 119 CM-MP 1.80	39°45′41.52591″	105°25′18.35208″	2174.318	2188.108	0°02′57.63240″	1.000002302	518855.613	921105.859	
HWY 119 CM-MP 1.85	39°45′43.92277″	105°25′23.25197″	2178.716	2192.498	0°02′54.54209″	1.000002436	518929.437	920989.165	
HWY 119 CM-MP 2.11	39°45′49.72012″	105°25′35.97113″	2191.118	2204.882	0°02′46.52025″	1.000002761	519107.987	920686.271	
HWY 119 CM-MP 2.21	39°45′48.05527″	105°25′44.54366″	2197.639	2211.387	0°02′41.11365″	1.000002668	519056.478	920482.267	
HWY 119 CM-MP 2.30	39°45′49.14962″	105°25′51.23123″	2200.345	2214.082	0°02′36.89586″	1.000002729	519090.107	920323.062	
HWY 119 CM-MP 2.41	39°45′45.66086″	105°25′56.28066″	2203.500	2217.227	0°02′33.71124″	1.000002534	518982.417	920202.955	
HWY 119 CM-MP 2.51	39°45′44.03398″	105°26′01.02305″	2206.844	2220.562	0°02′30.72027″	1.000002443	518932.158	920090.111	
HWY 119 CM-MP 2.61	39°45′43.80071″	105°26′08.00047″	2212.225	2225.932	0°02′26.31968″	1.000002430	518924.844	919924.035	
HWY 119 CM-MP 2.71	39°45′41.52992″	105°26′11.15575″	2217.391	2231.091	0°02′24.32968″	1.000002303	518854.756	919848.980	
HWY 119 CM-MP 2.81	39°45′39,62531″	105°26′14.68295″	2221.564	2235.258	0°02′22.10511″	1.000002196	518795.956	919765.063	
HWY 119 CM-MP 2.85	39°45′41.39693″	105°26′19.12012″	2224.453	2238.140	0°02′19.30663″	1.000002295	518850.524	919659.408	
HWY 119 CM-MP 2.95	39°45′44.63103″	105°26′23.20970″	2228.253	2241.935	0°02′16.72738″	1.000002476	518950.204	919561.998	
HWY 119 CM-MP 3.10	39°45′48.18197″	105°26′30.71220″	2235.404	2249.075	0°02′11.99563″	1.000002675	519059.605	919383.349	
HWY 119 CM-MP 3.26	39°45′48.98550″	105°26′41.30532″	2244.918	2258.572	0°02′05.31466″	1.000002720	519084.230	919131.194	
HWY 119 CM-MP 3.39	39°45′54.76735″	105°26′50.40674″	2255.160	2268.801	0°01′59.57449″	1.000003045	519262.424	918914.457	
HWY 119 CM-MP 3.61	39°46′02.43249″	105°26′54.49516″	2264.123	2277.767	0°01′56.99597″	1.000003477	519498.775	918817.012	
HWY 119 CM-MP 3.72	39°46′08.53902″	105°26′52.16297″	2270.286	2283.929	0°01′58.46685″	1.000003822	519687.143	918872.412	
HWY 119 CM-MP 3.84	39°46′12.31900″	105°26′57.78802″	2275.772	2289.407	0°01′54.91919″	1.000004036	519803.649	918738.469	
HWY 119 CM-MP 3.96	39°46′18.00521″	105°27′05.19140″	2283.651	2297.276	0°01′50.24996 ″	1.000004359	519978.926	918562.175	
HWY 119 CM-MP 4.15	39°46′25.15870″	105°27′10.38785″	2292.063	2305.681	0°01′46.97261″	1.000004765	520199.488	918438.388	
HWY 119 CM-MP 4.31	39°46′32.14960″	105°27′16.62643″	2301.236	2314.840	0°01′43.03801″	1.000005164	520415.025	918289.810	
HWY 119 CM-MP 4.36	39°46′34.70585″	105°27′22.33264″	2307.554	2321.148	0°01′39.43916″	1.000005310	520493.798	918153.975	
HWY 119 CM-MP 4.45	39°46′40.60548″	105°27′29.00139″	2315.593	2329.177	0°01′35,23325″	1.000005648	520675.679	917995.189	
HWY 119 CM-MP 4.66	39*46′45.58924″	105*27′42.13242″	2323.758	2337.319	0°01′26.95164″	1.000005934	520829.250	917682.641	
HWY 119 CM-MP 5.04	39°47′00.55503 ″	105°27′48.91652″	2340.663	2354.215	0°01′22.67298″	1.000006797	521290.758	917521.016	
HWY 119 CM-MP 5.26	39°47′11.78025″	105*27′58.23520″	2350.703	2364.243	0°01′16.79579″	1.000007447	521636.881	917299.145	
HWY 119 CM-MP 5.56	39*47′21.87079″	105°28′08.22339″	2358.411	2371.938	0°01′10.49634″	1.000008034	521948.009	917061.376	
HWY 119 CM-MP 5.81	39°47′30.46810″	105°28′17.46439″	2369.878	2383.395	0°01′04.66814″	1.000008536	522213.096	916841.418	
HWY 119 CM-MP 5.96	39°47′38.16871″	105°28′27.51974″	2380.150	2393.652	0°00′58.32634″	1.000008988	522450.528	916602.108	
HWY 119 CM-MP 6.06	39°47′43.75546″	105°28′28.76339″	2386.268	2399.770	0°00′57.54198″	1.000009316	522622.827	916572.471	
HWY 119 CM-MP 6.10	39°47′44.83299″	105°28′28.36202″	2388.056	2401.559	0°00′57.79512″	1.000009379	522656.063	916582.011	
HWY 119 CM-MP 6.16	39°47′47,40684″	105°28′32.83306″	2393.589	2407.084	0*00′54.97528″	1.000009531	522735.417	916475.618	
HWY 119 CM-MP 6.29	39°47′51.90481″	105°28′35.22031″	2397.691	2411.183	0°00′53.46966 ″	1.000009796	522874.129	916418.787	
HWY 119 CM-MP 6.40	39°47′53.24382″	105°28′45,25141″	2406.089	2419.564	0°00′47.14316″	1.000009875	522915.369	916180.132	
HWY 119 CM-MP 6.55	39°47′55,63521″	105°28′55.63849″	2412.662	2426.120	0°00′40.59213″	1.000010016	522989.072	915933.004	

COORDINATE DATUM: Project coordinates are modified state plane central zone NAD '83 (92) coordinates. The combined factor used to modify the coordinates was 0.999649198


Region One
Address: 18500 E. Colfax Ave.
Aurora, CO 80011
Phone: (303) 757-9744 FAX: (303) 757-9746

Sheet Revisions

S.H. 119 MP 1.60 to MP 6.55 Sec's 7,8,17,20,21,28,27,26 T.3 S. R.72 W. GILPIN COUNTY COLORADO

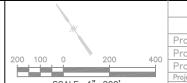

Survey Control Diagram Plan Sheet Project Number: Proj # Project Location: Proj Loc. Project Location:

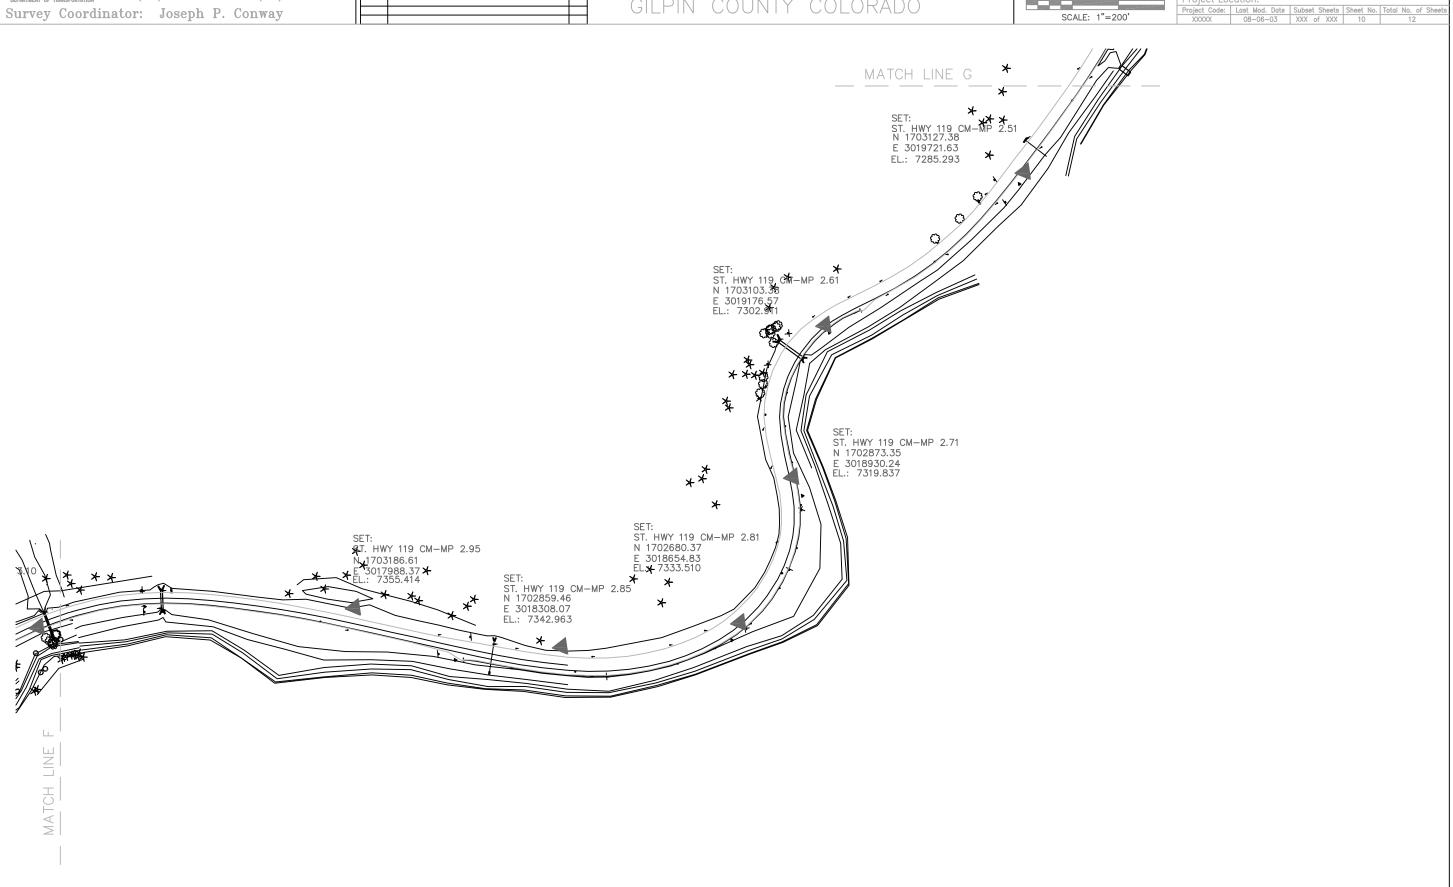

CD0T Form	## Region 1 16500 E. Colfax Avarora, CO 80011 Phone: (303) 757	ve.	Sheet Revisions	xxx SEC	SH 119 MP 0.05 to CTIONS 7, 8, 17, 18, 20, 21, 2 DWNSHIP 3 SOUTH, RANGE 72 W SECTION CORNER LOCAT GILPIN COUNTY, CO	22, 26, 27, 28, 35, 36, WEST OF THE 6th P.M., TION DIAGRAM	Section Corner Location Diagram Title Sheet Project Number: STA 119 - 044 Project Location: BLACKHAWK - SOUTH Project Location: Project Location: 1° = 3000' 1° = 3000' Section Corner Location Diagram Title Sheet Project Number: STA 119 - 044 Project Location: BLACKHAWK - SOUTH Project Location: 12878 02-19-01 1 of 6 3 6
		TOWNSHIP 3 SOUT	TH - RANGE 72 WES	T		BASIS OF BEARINGS: bearing of N 52'39'31 Dated 12/21/1999, pr	NH 0061-078 PC 15370 SHEET 03F Bearings used in the calculation of coordinates are based on a grid "W from NGS FOUR to NGS FARID as shown on Survey Control Diagram repared for CDOT by Western States Surveying, Inc.
			E PL	Commence of Commen	Secondary Community of	NOTE: This survey is The survey is not a construction of the surve	Colorado law you must commence any lead action based upon any
"18, ATM, FOR INFORMATION LAND SURVETS/RIGHT OF WAY NUMBER	Elementorius (1) (2) (2) (3) (3) (4) (4) (4) (4) (4) (4) (4) (4) (4) (4	The second secon				defect in this survey may any action base from the date of the NOTE: No guarantee drawing is either state professional land survey. SURVEYORS STATEMET of Colorado, hereby supervision this 19th my supervision and action of Colorado, and is not my knowledge and control tolerances of the survey.	within three years after you first discover such defect. In no event dupon any defect in this survey be commenced more than ten years e statement shown. as to the accuracy of the information contained on the attached ted or implied unless this copy bears an original signature of the veyor hereon named. NT: I, Michael D. Heimbuck, a Professional Land Surveyor in the State state that this Section Breakdown Diagram was prepared under my direct day of Feburary, 2001, from a field survey performed under shecking for and on behalf of the Department of Transportation, State not a Land Survey Plat or Right—of—Way Survey Plat and to the best did belief this survey, as shown, meets the minimum horizontal for Type B Survey as listed in the Colorado Department of
DEPOSITED THIS DAY OF THE ONLY IN BOOK OF THE SURVEYS AT PAGE	(d a		21	22		Transportation Survey	Michael D. Henrick PLS 17488
T/EDIT by DAW			2:3	27	33		
Ingram dwo 18 FFB 2001 07:42:35.4 PLO	Management of the Application of					33	= ALIQOUT LINES WITH CORNERS = APPROXIMATE ALIQOUT LINES

CDOT	Fo	erm.
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Survey Unit:	Pho

egion 1 6500 E. Colfax Ave. urora, CO 80011 Phone: (303) 757-9744 FAX: (303) 757-9748 Joseph P. Conway

Sheet Revisions						
nm/yy	XXXXX		XXX			

SH 119 MP 0.05 to MP 7.30 SECTIONS 7, 8, 17, 18, 20, 21, 22, 26, 27, 28, 35, 36, TOWNSHIP 3 SOUTH, RANGE 72 WEST OF THE 6th P.M.,


SECTION CORNER LOCATION DIAGRAM GILPIN COUNTY, COLORADO


Section Corner Location Diagram							
Plan Sheet							
Project Number: STA 119 - 044							
Project Loc	cation: BLACK	CHAWK - SO	UTH	***************************************			
Project Location:							
Project Code:	Last Mod. Date	Subset Sheets	Sheet No.	Total No. of Sheets			
 12878	02-19-01	2 of 6	3.4	6			

NH 0061-078 PC 15370 SHEET 03G

PROJECT COORDINATE SUMMARY TABLE (ADJUSTED FIELD DATA)

POINT #	PROJECT COORDINATES		DECODICTION
FOINT #	NORTH (F)	EAST (F)	DESCRIPTION
2103	1715225.42	3006898.83	SE SECTION 7 - 3" BRASS BLM CAP
3019	1709990.44	3006962.19	SW SECTION 17 - 2 1/2" BRASS CAP LS 7234
3045	1715417.57	3012109.95	NE SECTION 17 - 3" BRASS BLM CAP
999	1715236.49	3001104.95	NW SECTION 18 - 3" BRASS BLM CAP
3004	1710159.01	3012127.93	NW SECTION 21 - 3" BRASS BLM CAP
3035	1710399.48	3017155.94	NE SECTION 21 - 1 1/2" ALUM. CAP LS 865
3040	1705035.24	3012161.57	SW SECTION 21 - STONE
3023	1705752.28	3027398.27	NE SECTION 26 - 3" ALUM. CAP
3029	1700299.05	3022266.53	SW SECTION 26 - 3" BRASS BLM CAP
2184	1705395.58	3022269.38	NW SECTION 26 - STONE W/ 1 1/2" ALUM. CAP - LS 865
2708	1705158.92	3017178.42	NW SECTION 27 - STONE
3031	1700107.92	3017172.09	SW SECTION 27 - 3" BRASS BLM CAP
2002	1700514.68	3027354.02	NW SECTION 36 - 2" ALUM CAP - LS 14112
2051	1720513.07	3004206.82	N 1/4 SECTION 7 - 3" BRASS BLM CAP
2053	1717835.61	3001117.41	W 1/4 SECTION 7 - 3" BRASS BLM CAP
2105	1718150.63	3006908.98	E 1/4 SECTION 7 - 1 1/2" ALUM CAP - LS 865
2052	1717775.15	3001116.59	E 1/4 SECTION 12 - 3" BRASS BLM CAP
3015	1712789.07	3012117.18	E 1/4 SECTION 17 - BLM BRASS CAP
3017	1710031.20	3009592.60	S 1/4 SECTION 17 - BLM BRASS CAP
3043	1712614.47	3006963.09	W 1/4 SECTION 17 - 3" BRASS BLM CAP
3047	1715368.64	3009525.37	N 1/4 SECTION 17 - 3" BRASS 3" BRASS BLM CAP
4042	1704937.53	3009429.46	S 1/4 SECTION 20 - STONE
2170	1707763.59	3017169.37	E 1/4 SECTION 21 - STONE
3002	1710275.81	3014578.27	N 1/4 SECTION 21 - STONE
3007	1705101.45	3014689.71	S 1/4 SECTION 21 - 1 1/2" ALUM. CAP 865
3009	1707616.71	3012124.08	W 1/4 SECTION 21 - STONE
2151	1702992.11	3024820.64	C 1/4 SECTION 26 - #1 - 3.5" ALUM. CAP - LS 22094
2153	1702993.78	3024828.20	C 1/4 SECTION 26 - #2 - 2" ALUM. CAP - LS 14112
2159	1700761.93	3024821.95	S 1/4 SECTION 26 - #1 - STONE
2161	1700337.00	3024814.88	S 1/4 SECTION 26 - #2 - 3 1/4" ALUM. CAP - LS 22094
2178	1702854.00	3022277.80	W 1/4 SECTION 26 - STONE
2186	1703133.19	3027376.77	E 1/4 SECTION 26 - 3 1/4" ALUM. CAP - LS 22094
3025	1705570.20	3024835.50	N 1/4 SECTION 26 - #1 - 3 1/4" ALUM. CAP LS 22094
9304	1705411.82	3024796.33	N 1/4 SECTION 26 - #2 - STONE
2701	1705196.34	3019762.96	N 1/4 SECTION 27 - STONE
4006	1702699.04	3017165.47	E 1/4 SECTION 28 - STONE
4009	1700039.77	3014610.68	S 1/4 SECTION 28 - STONE
4040	1702530.83	3012078.92	W 1/4 SECTION 28 - STONE
2004	1698025.22	3027349.87	W 1/4 SECTION 36 - 3 1/4" ALUM CAP - LS 3090
2307	1700998.71	3030027.69	N 1/4 SECTION 36 - 1 1/2" ALUM. CAP - LS 865
1052	1713919.14	3001099.37	N 1/16 SECTION 18 - 3" BRASS BLM CAP

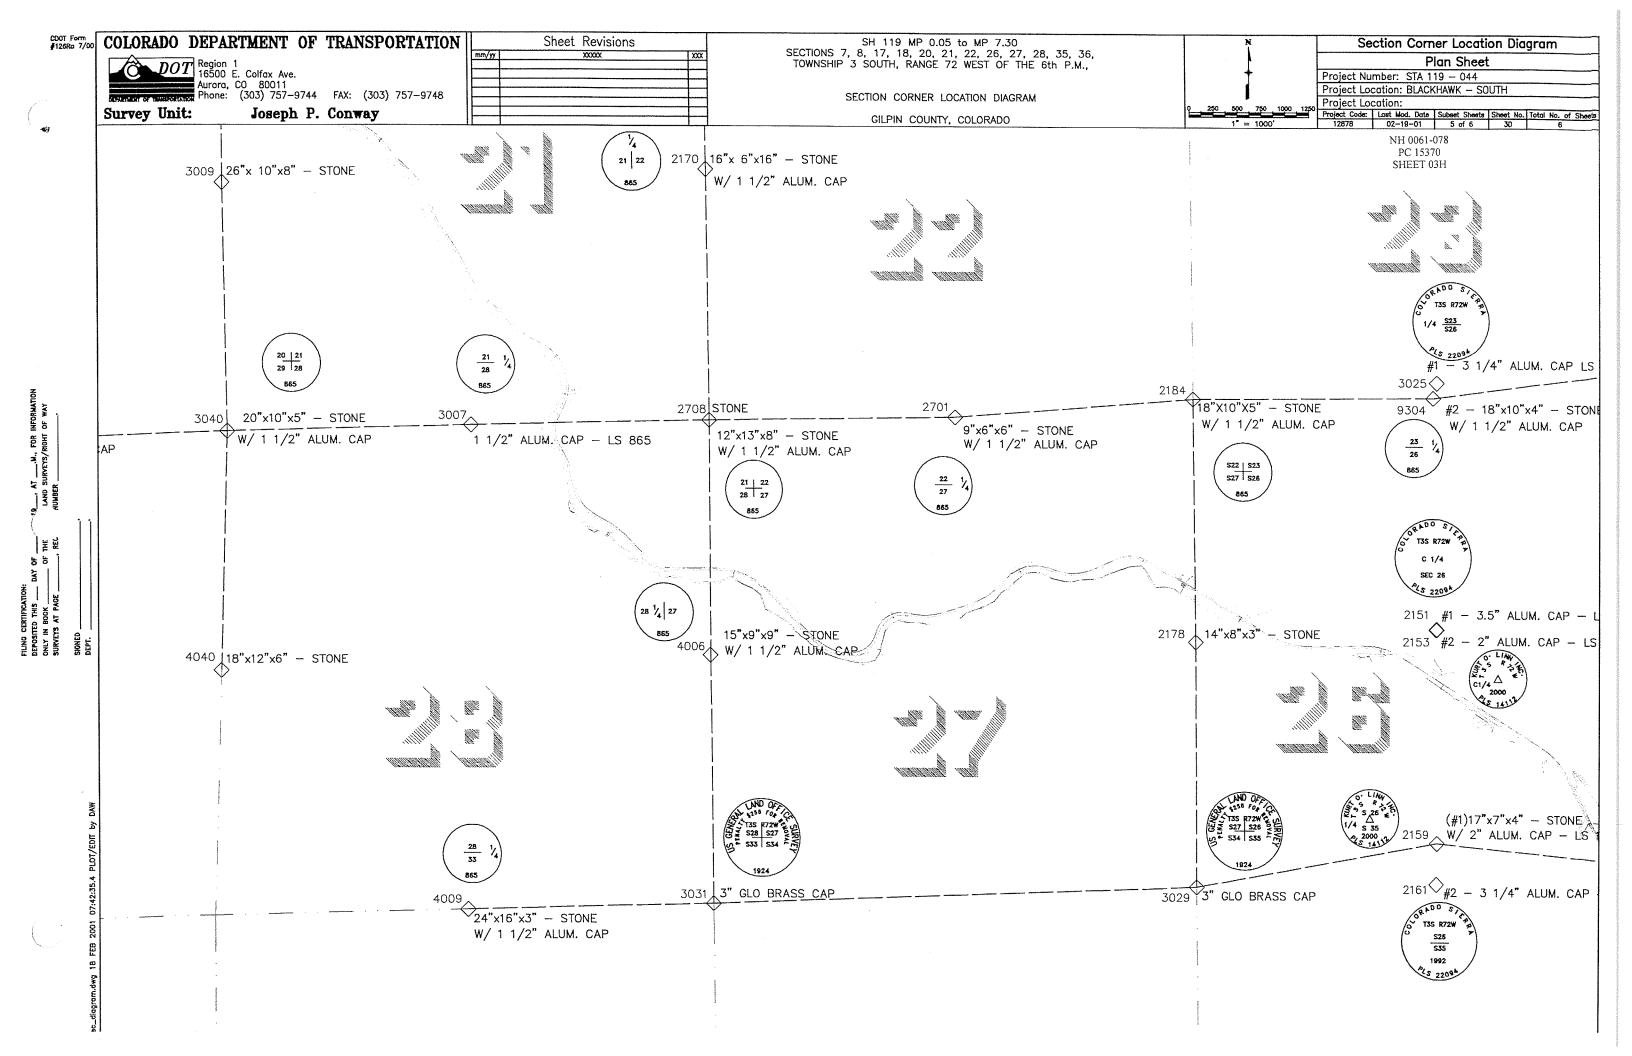

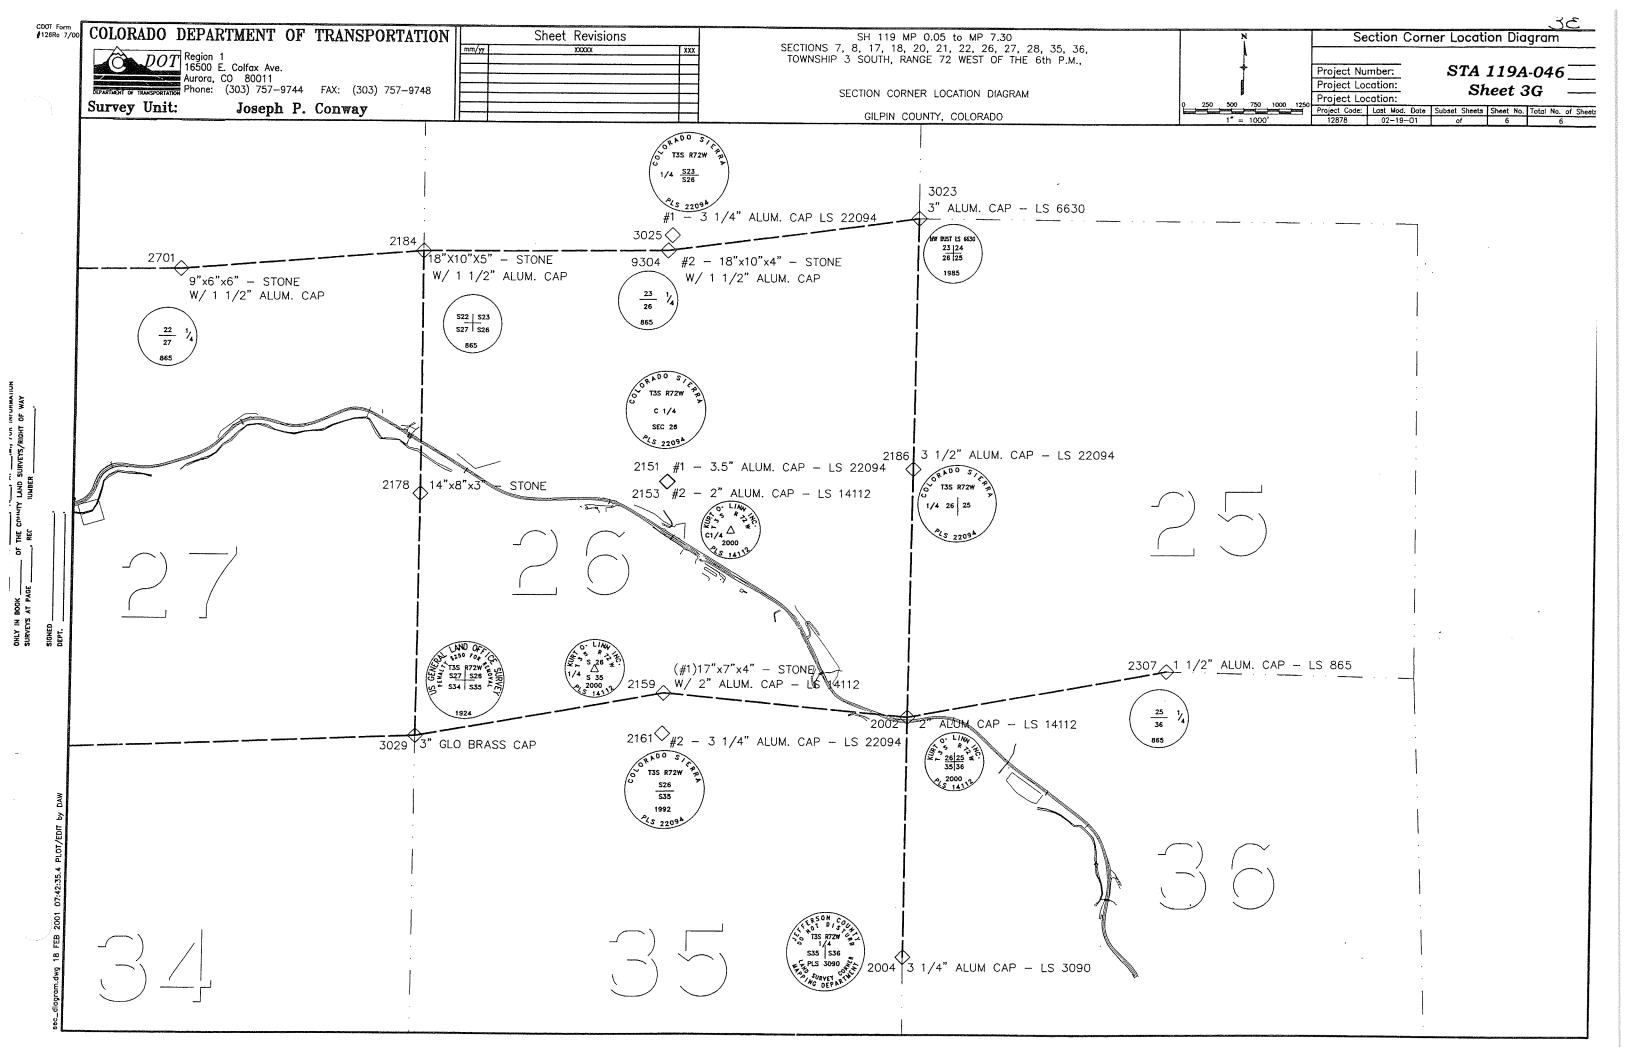

Colorado Department of Transportation

DOT18500 East Colfax Avenue Aurora, CO 80011

hone: 303-365-7410 FAX: 303-365-7350 KAW Region 1

	Sheet Revisions		Sheet Revisions		Sheet Revisions		F
Date	Description	Initials		Date	Description	Initials	ı

8181 East Tufts Avenue Denver, CO 80237 (303) 740–2600

INIGHT OF Way Fluids							
Monumentation Sheet							
Project Number: STA R100-140							
Project Location: US6 & SH 119, CLEAR CREEK ROCKFALL							
Project Location: JEFFERSON & GILPIN COUNTIES							
Project Code: Last Mod. Date Subset Sheets Sheet No.							

1 of 1

4.01

Pight of Way Plans

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TABULATION OF R.O.W. MARKERS TO BE SET FOR SITE 1

Point No.	Northing	Easting	Туре
517	697457.82	1029918.27	1
531	696508.30	1030416.51	1
532	696645.02	1030225.78	1
533	696688.30	1030189.46	1
534	696963.62	1030072.59	1
535	697034.50	1030039.36	1
536	697140.20	1029984.91	1
5.37	697576.29	1029925.62	1

TABULATION OF PERMANENT FASEMENT MARKERS TO BE SET FOR SITE 1

Point No.	Northing	Easting	Туре
499	697577.18	1029966.13	6
500	697636.31	1029925.94	6
501	697636.98	1029955.94	6
502	697420.23	1029992.86	6
503	697088.50	1030137.19	6
504	696851.24	1030300.86	6
506	696490.44	1030462.37	6

TABULATION OF TEMPORARY EASEMENT POINTS TO BE STAKED FOR SITE 1

Point No.	Northing	Easting	Туре
420	697465.64	1029985.12	
421	697352.67	1030383.30	
422	696896.51	1030513.90	
423	696647.14	1030392.23	

TABULATION OF MONUMENTS FOUND

QUANTIT	Y D	FM	'DNU.	MEN	TS	TO .	BE .	SET		
CAP				MΩΛ	IUMEN	T TY	PE			
TYPE	1	1A	2	2A	3	3A	4	5	5(S)	6
EFERENCE										
OW	8									
ONTROL										
LIQUOT CORNER										
ERMANENT EASEMENT										12
ROJECT POINTS										
/ITNESS POST (REQUIRED)	8									

BY U.R.S. (Site 1) Northing Easting Point No. Description 698094.68 1032373.68 E1/4 SECTION 36 - STONE 1004 1005 698061.11 1029949.14 C1/4 SECTION 36 - PLS 3090 1010 698138.49 1029849.44 EVERGREEN SURV. PLS 20136 1030027.69 50003 700998.74 $N^{1}/_{4}$ SECTION 36 - PLS 865 50006 696708.64 1029912.74 EMK - PLS 12405 1032379.22 50011 695464.67 SE CORNER SEC 36 - 1.5' VERTICAL STONE IN MOUND OF STONES 50015 1027349.88 W1/4 SECTION 36 - PLS 3090 698025.28 50017 697132.07 1029795.08 COUNTY CORNER #287 - CUT "+" 50020 695467.20 1029877.97

TABULATION OF R.O.W. MARKERS SET ON PROJ. NO. STA 119A-044

Point No.	Northing	Easting	Туре
426	1702909.52	3018862.13	1
427	1702912.94	3018842.43	1
428	1702776.92	3018639.77	1
429	1702757.39	3018635.46	1
887	1702948.98	3018868.97	6

TABULATION OF PERMANENT EASEMENT MARKERS TO BE SET FOR SITE 2

Point No.	Northing	Easting	Type
520	1702960.93	3018800.00	6
521	1702921.48	3018793.16	6
522	1702825.75	3018650.53	6
523	1702852.42	3018556.23	6
524	1702786.30	3018533.26	6

TABULATION OF FOUND MONUMENTS (Site 2)

Point No.	Northing	Easting	Description
2178	1702854.00	3022277.80	W 1/4 SECTION 26 - STONE
2708	1705158.92	3017178.42	NW SECTION 27 - STONE
4006	1702699.04	3017165.47	W 1/4 SECTION 27 - STONE

GENERAL NOTES:

- 1. This Right-of-Way plan is not a complete boundary survey of all the adjoining property owners and is prepared for the Transportation Department purposes ONLY.
- 2. Survey Control Points have a higher degree of accuracy than R.O.W. Markers


16521 08-11-08

- 3. Title Commitments / Policies supplied were supplied by Front Range Title of Downtown Denver, LLC. (Issued by Stewart Title Guaranty Company)
- 4. NOTICE: According to Colorado law you must commence any legal action based upon any defect in this survey within three years after you first discover such defect. In no event, may any action based upon any defect in this survey be commenced more than ten years from the date of certification
- 5. All R.O.W. Markers set from survey control points.
- 6. All centerline and offset stationing is theoretical only and may not represent the centerline as constructed in the field.
- 7. All coordinates listed are PROJECT COORDINATES.
- 8. BASIS OF BEARINGS: Site (1) Bearings shown herein are grid bearings based upon the Mountain Surveying and Mapping Inc. Control Diagram for the US Hwy 6 corridor to the CDOT. More particularly a line connecting the S 1/4 corner of Section 36, T. 3S., R. 72W., 6th P.M. (being a found 3-1/4" Brass Cap on pipe stamped: BLM S 1/4 Sec 36 1996), and the SE corner of Section 36, T. 3S., R. 72W., 6th P.M. (being a found 1.5' Vertical Stone in Mound of Stones) as Bearing S. 89°56'31" E, a distance of 2501.25 feet.
- 9. BASIS OF BEARINGS: Site (2) Bearings shown herein are grid bearings based upon the Mountain Surveying and Mapping Section Corner Location Diagram which is also based on the Western States Survey Control Diagram for the SH 119 corridor to the CDOT. More particularly a line connecting the W 1/4 corner of Section 27, T. 3S., R. 72W., 6th P.M. (being a found 15"X9"X9" Stone w/ 1-1/2" Alum. Cap stamped: 1/4 28 27 865) and the NW corner of Section 27, T. 3S., R. 72W., 6th P.M. (being a found 12"X13"X8" Stone w/ 1-1/2" Alum. Cap stamped: 21, 22, 28, 27 865) as Bearing N. 00°18'06" E., a distance of 2459.91 feet.

SURVEYOR STATEMENT (ROW PLAN)

___, a professional land surveyor licensed in the State of Colorado, do hereby state to the Colorado Department of Transportation that based upon my knowledge, information and belief, research, calculations and evaluation of the survey evidence were performed and this Right-of-Way Plan was prepared under my responsible charge in accordance with applicable standards of practice defined by Colorado Department of Transportation publications. This statement is not a guaranty or warranty, either expressed or implied.

PLS No. 25381

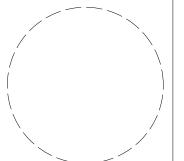


SURVEYOR STATEMENT (ROW MONUMENTS)


I, <u>Stan K. Vermilyea</u>, a professional land surveyor licensed in the State of Colorado, do hereby state to the Colorado Department of Transportation that based upon my knowledge, information and belief, adequate research, calculations and evaluation of survey evidence were performed and the Right-of-Way monuments depicted on this Right-of-Way Plan were set under my responsible charge in accordance with applicable standards of practice defined by Colorado Department of Transportation publications. This statement is not a guaranty or warranty, either expressed or implied.


PLS No. 25381


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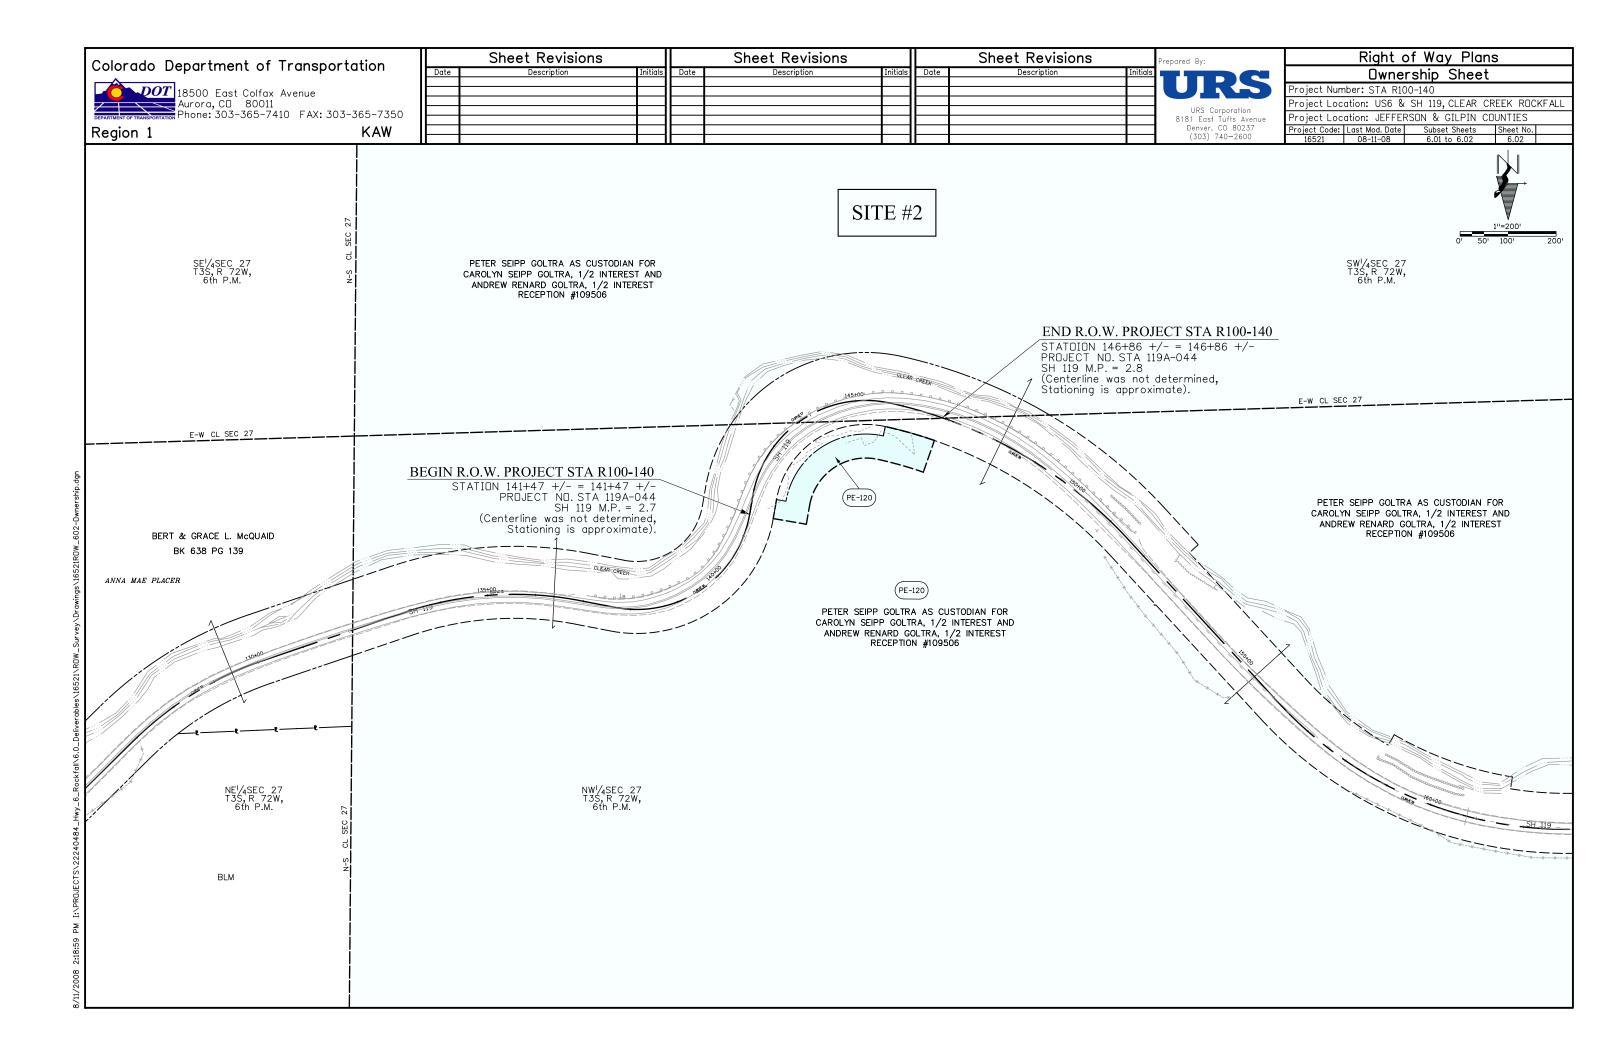
S1/4 SECTION 36 - PLS 3090




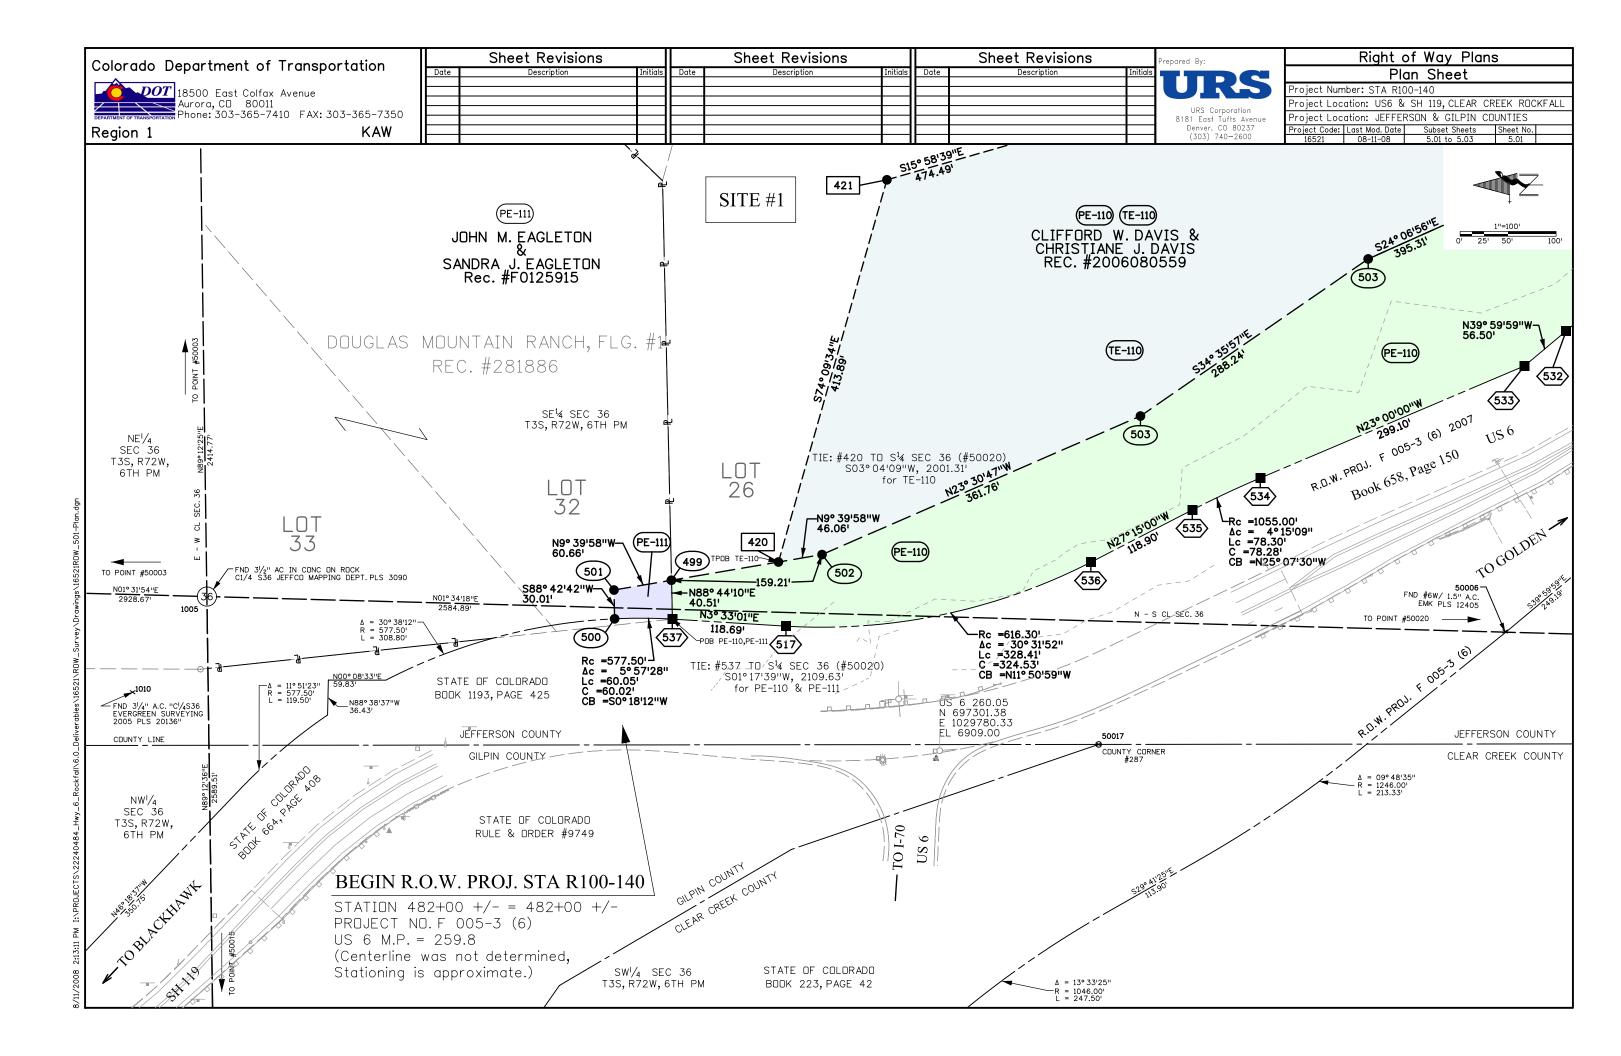


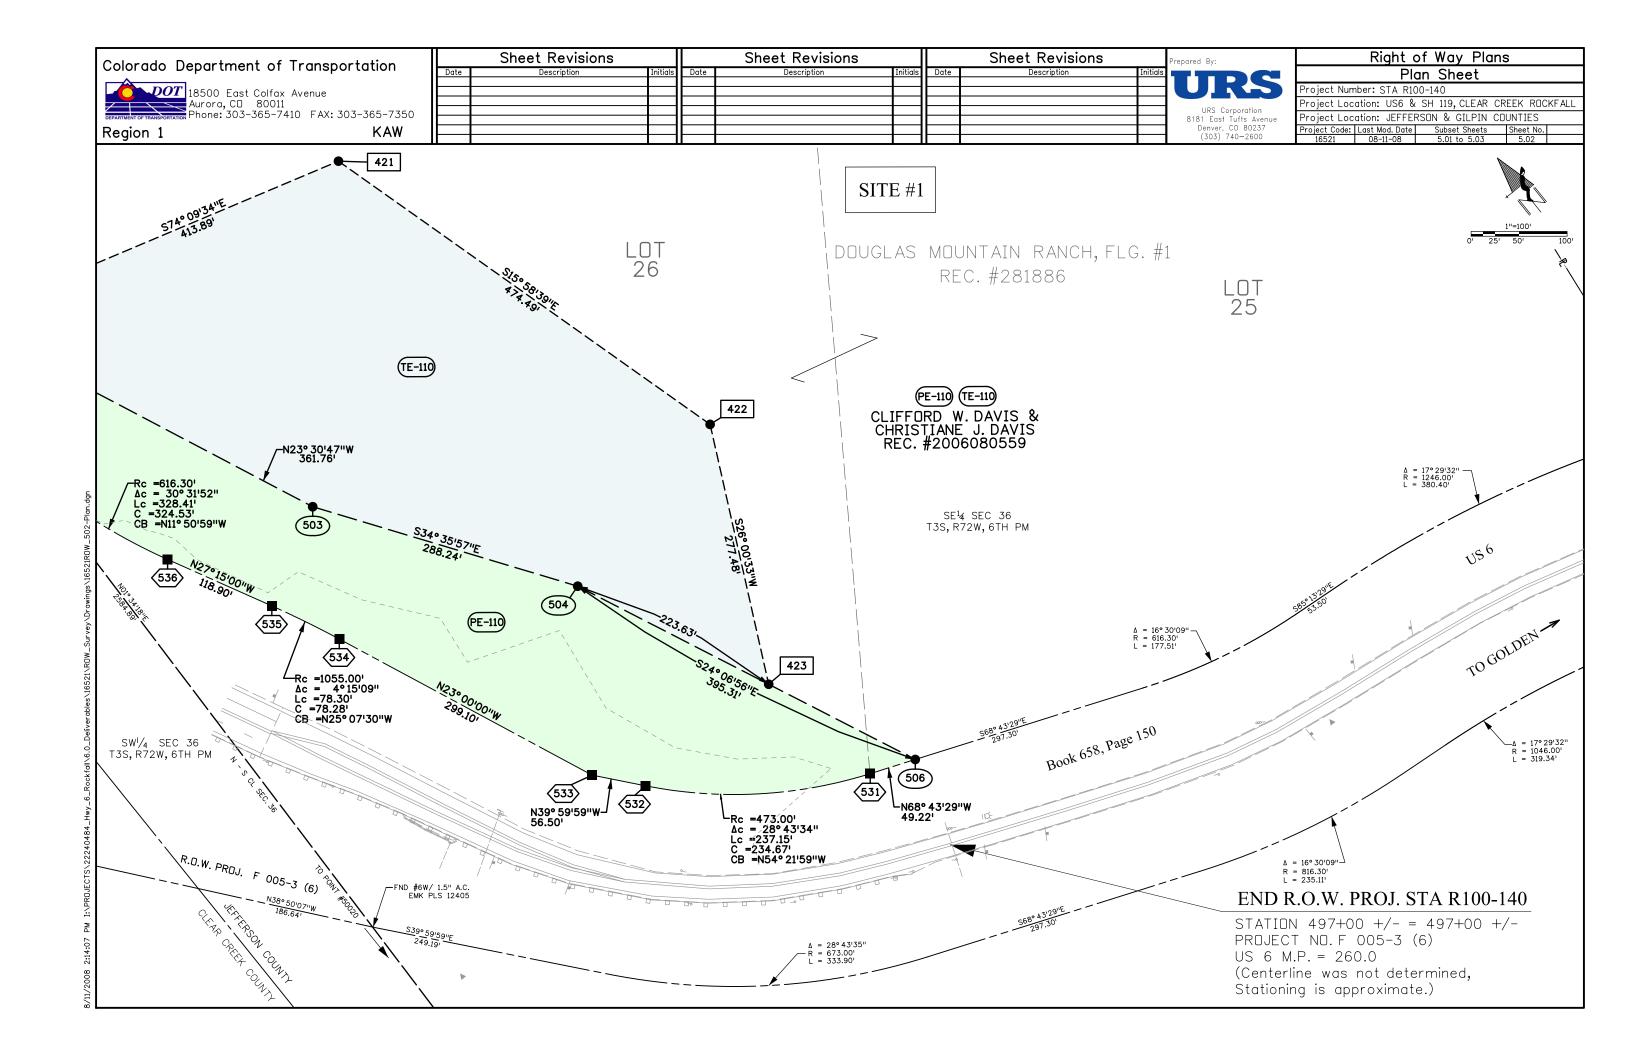


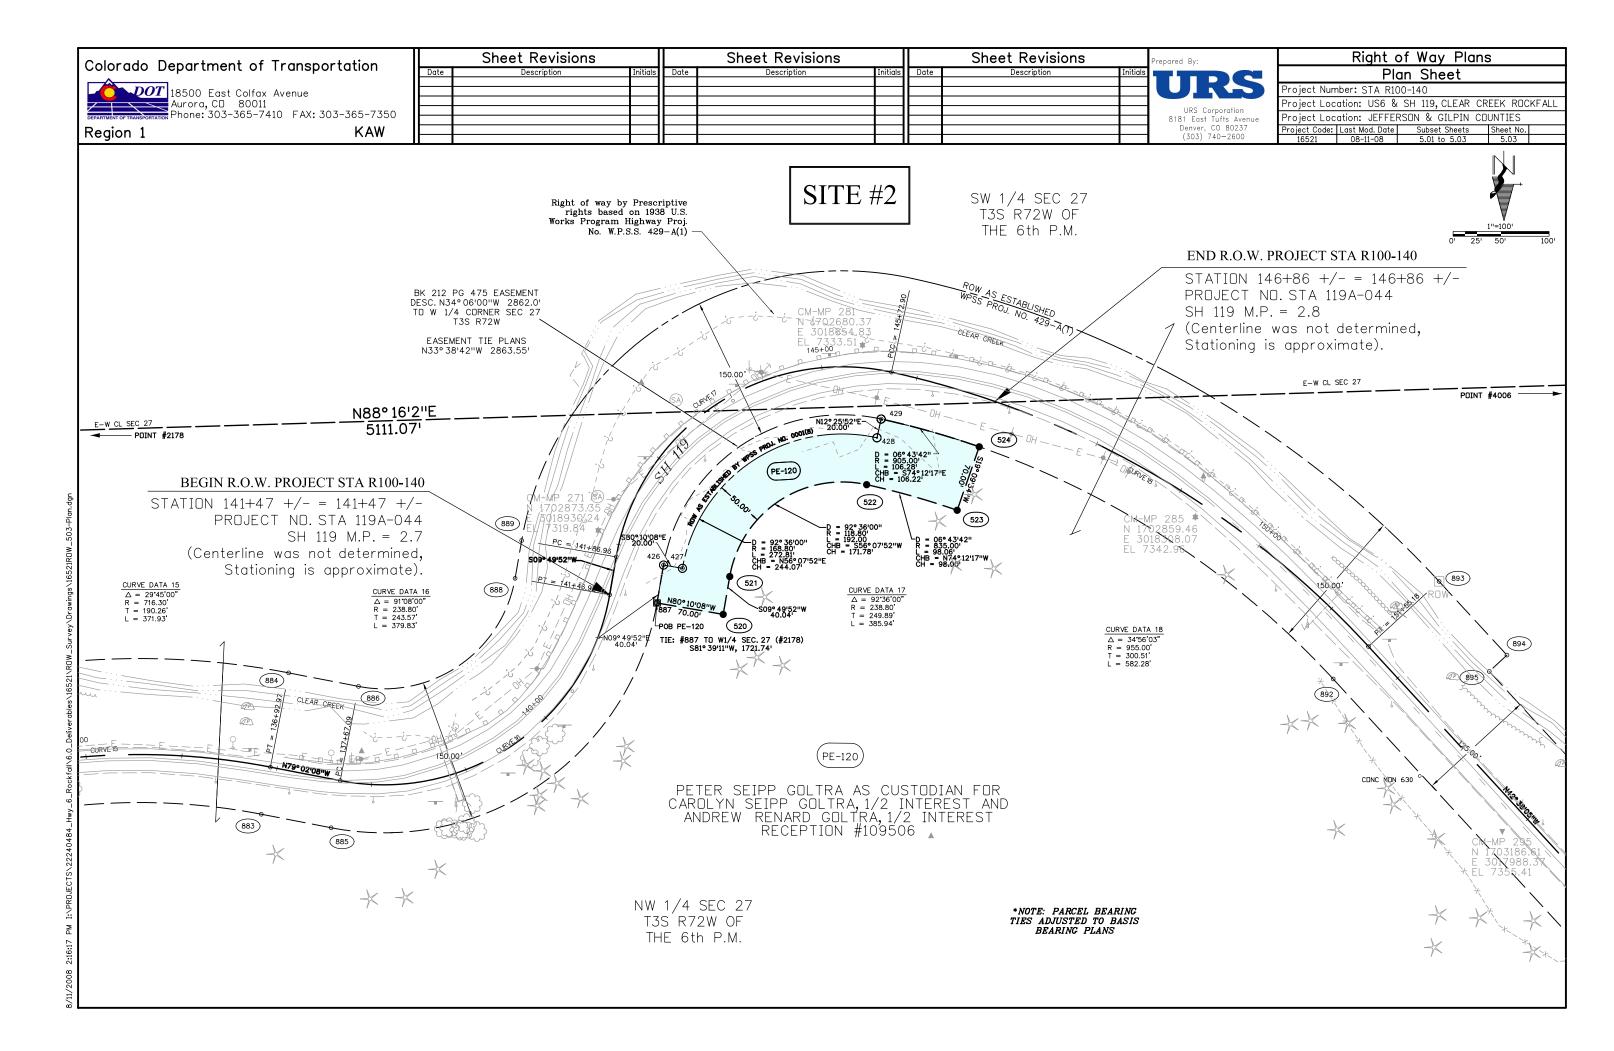


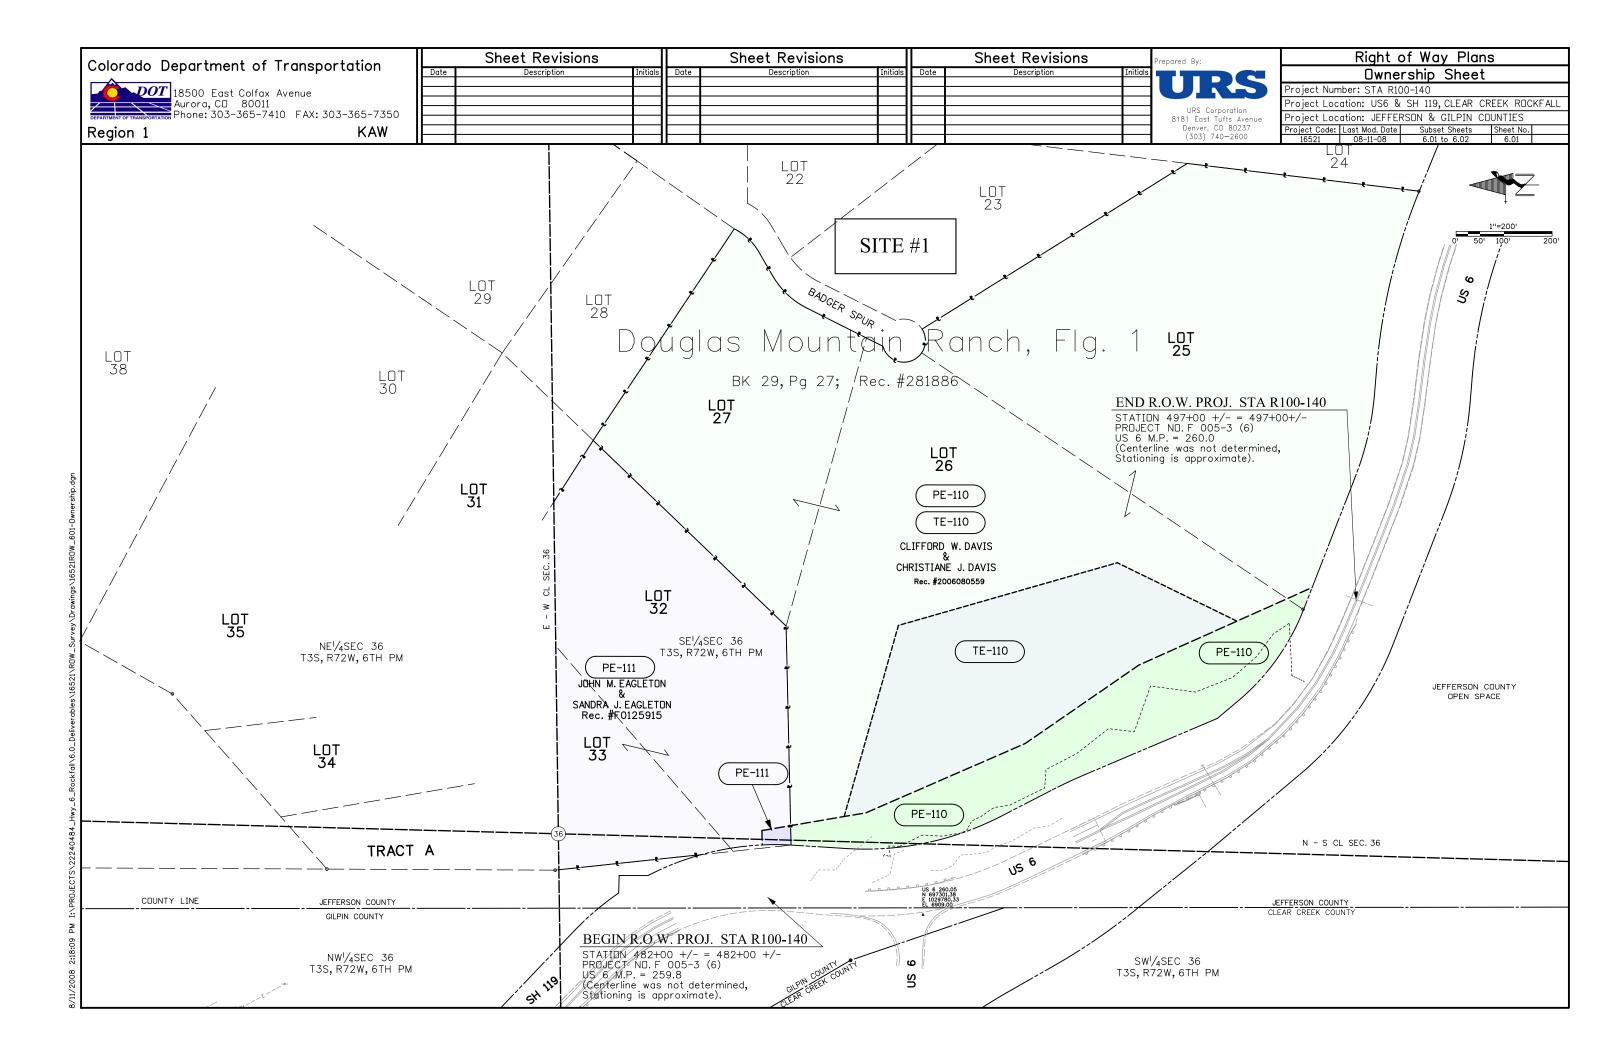


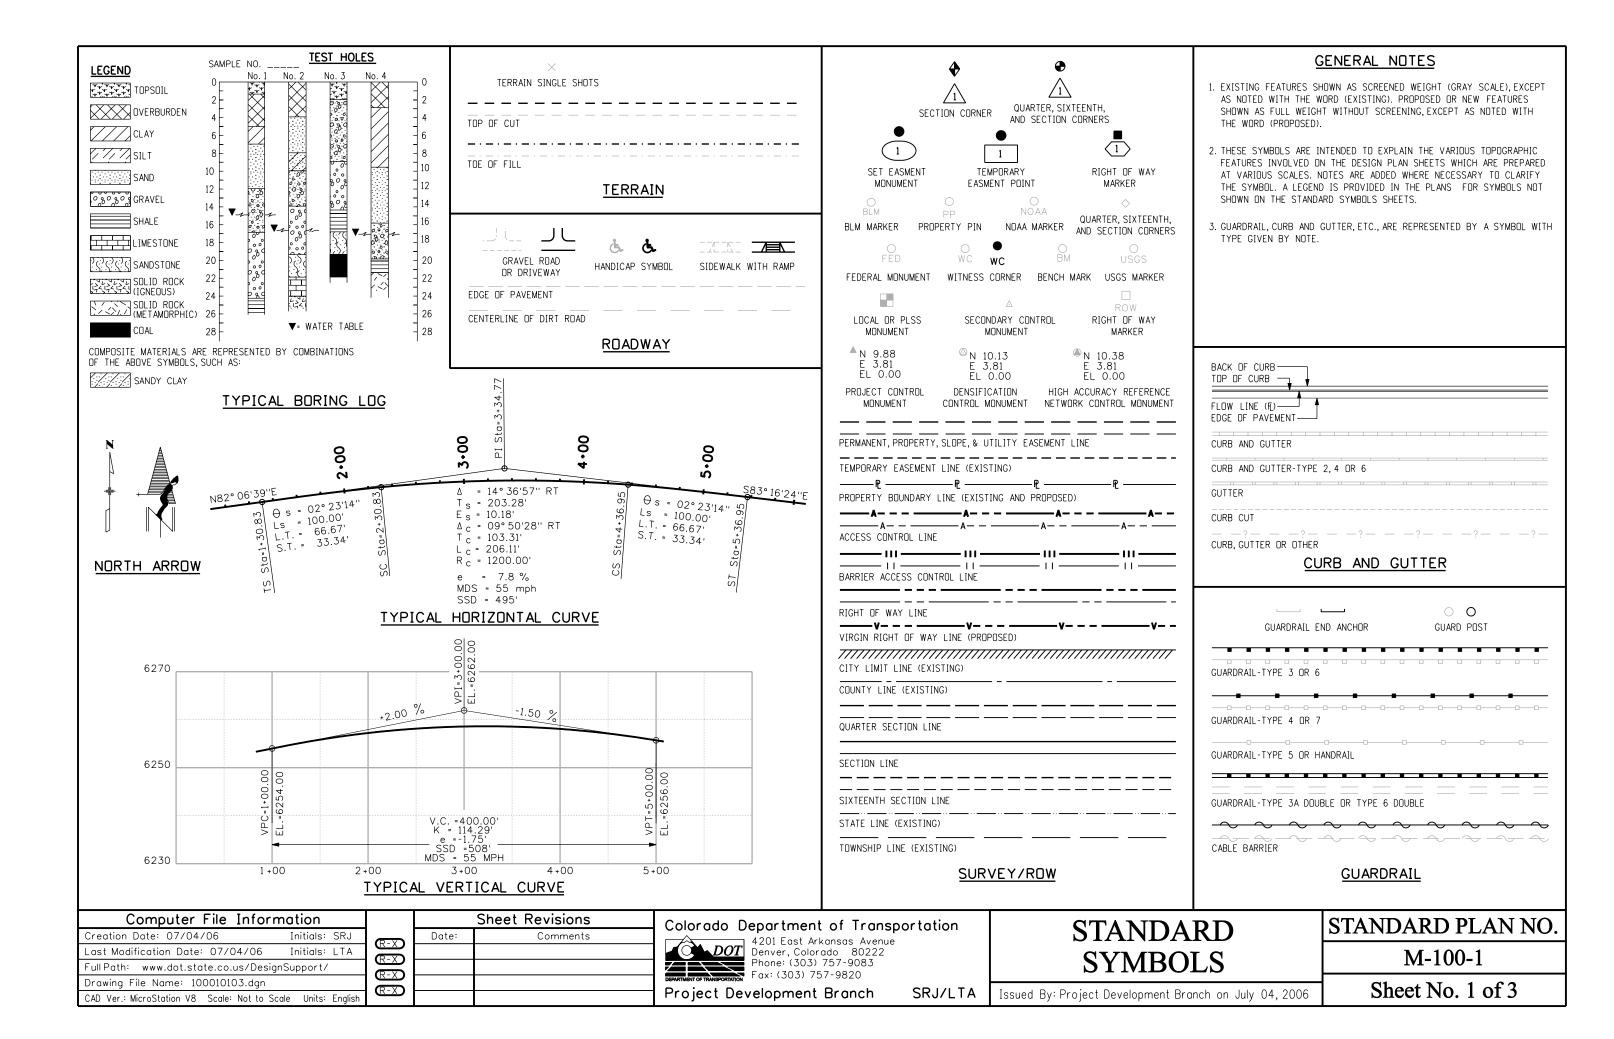

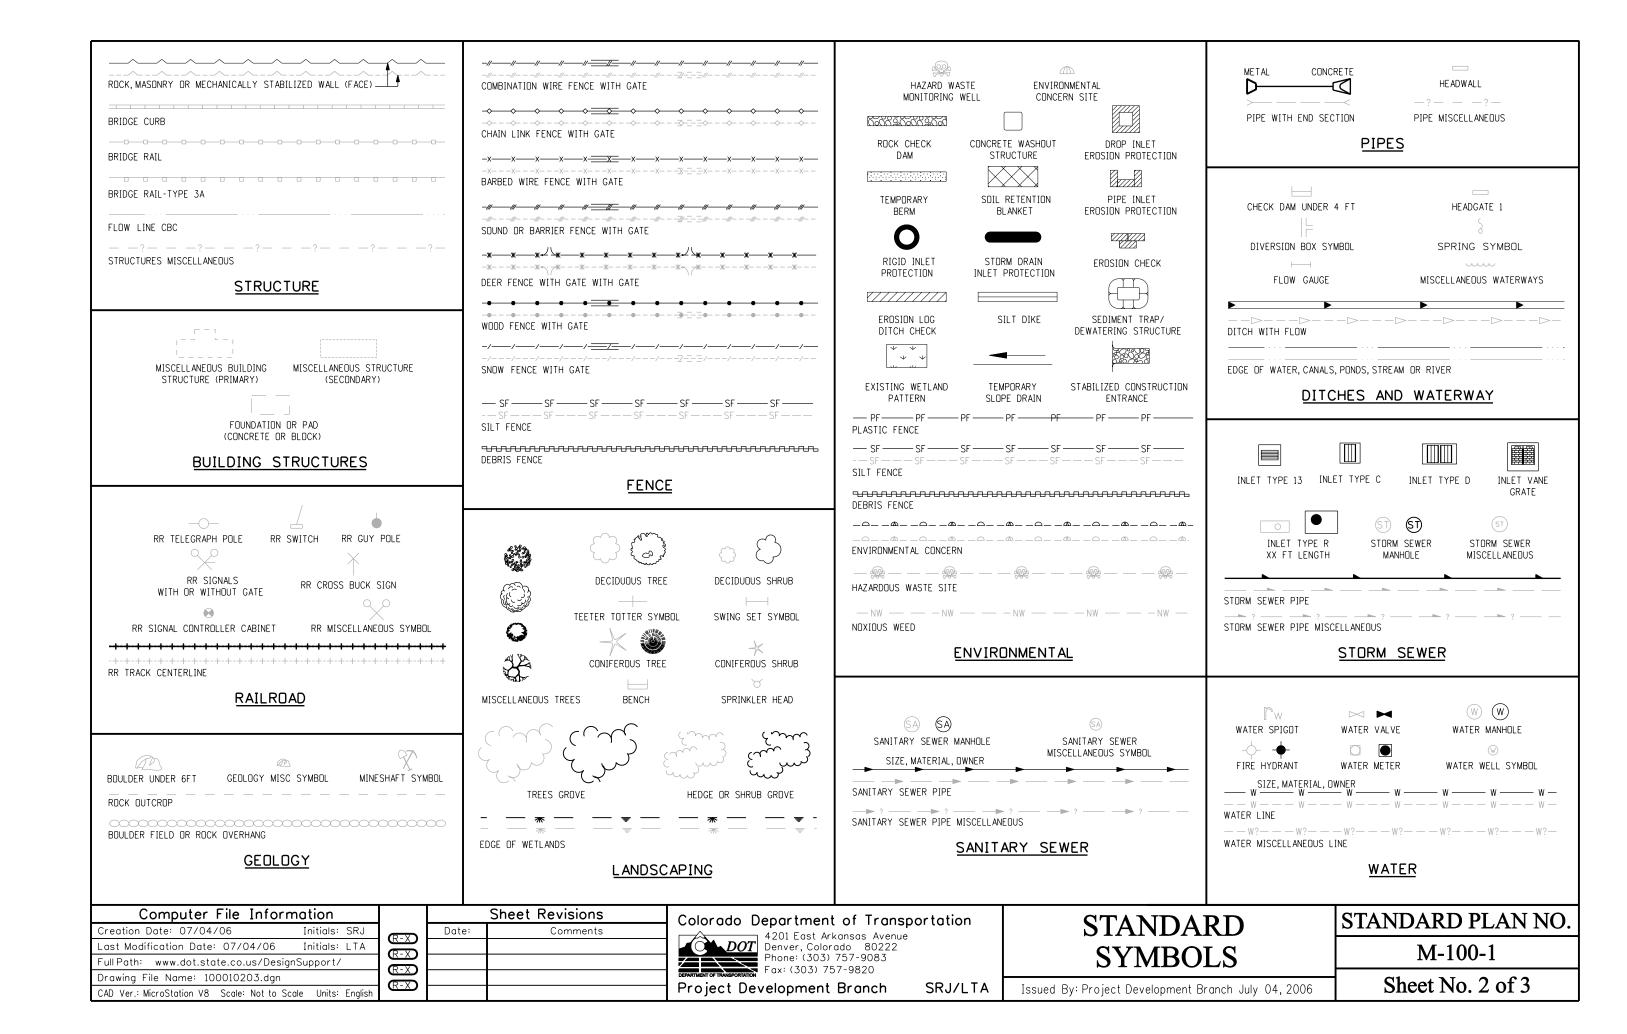


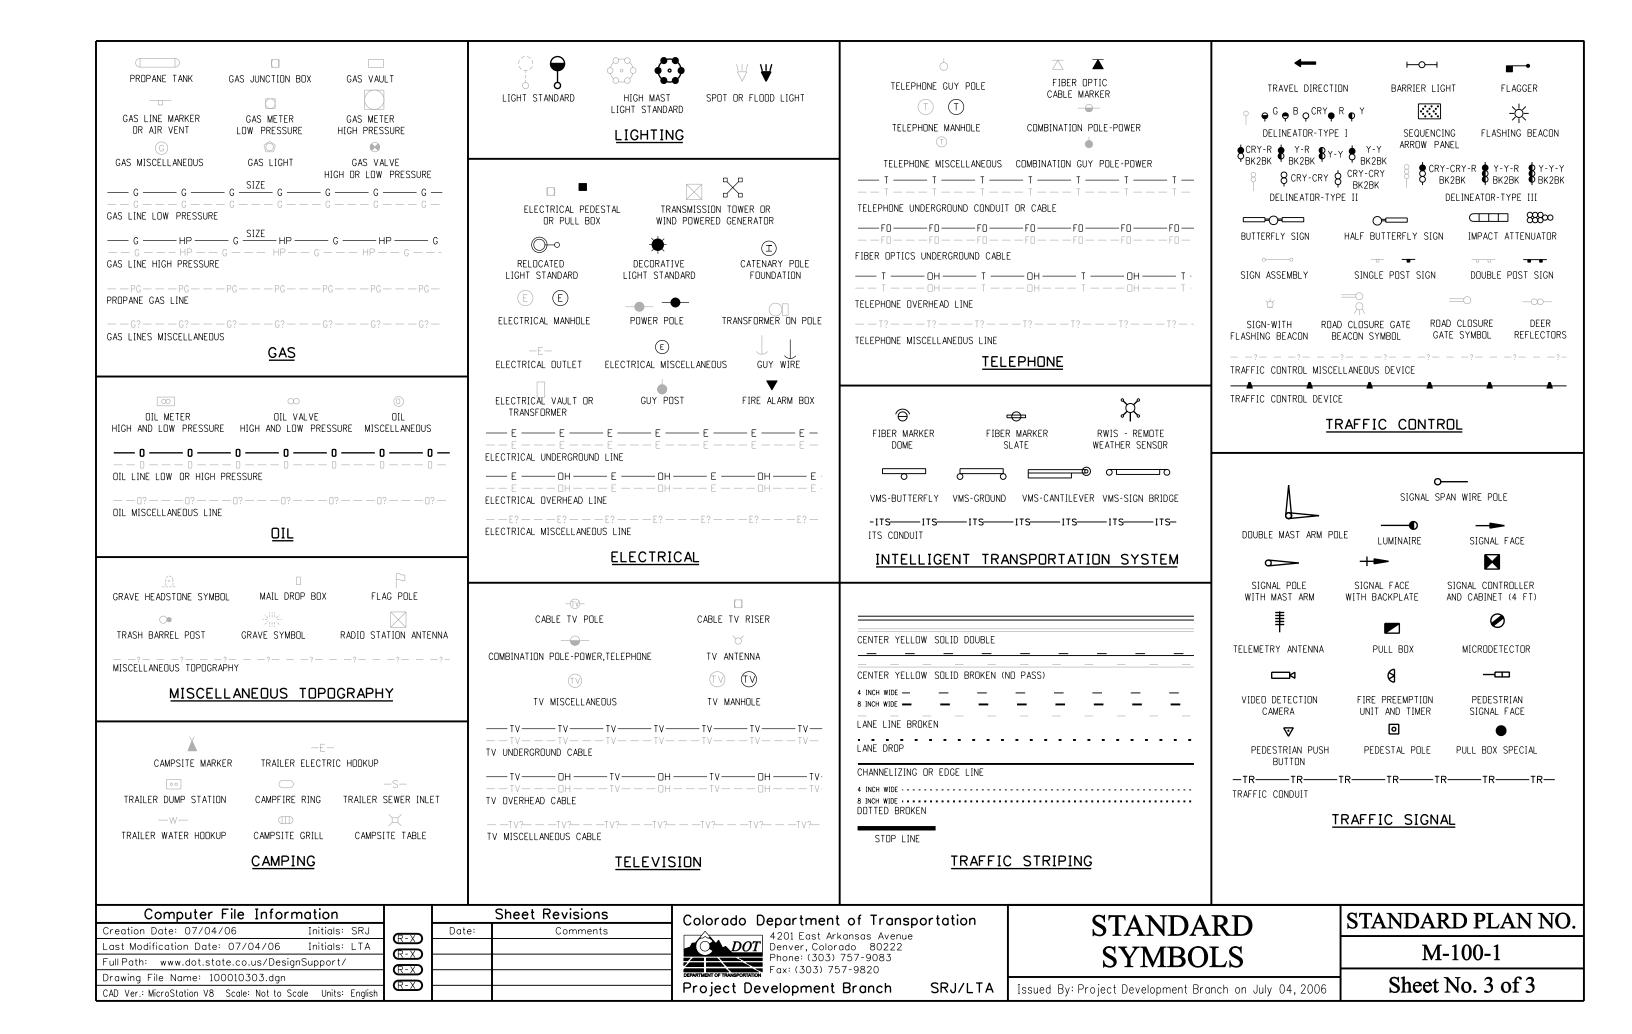

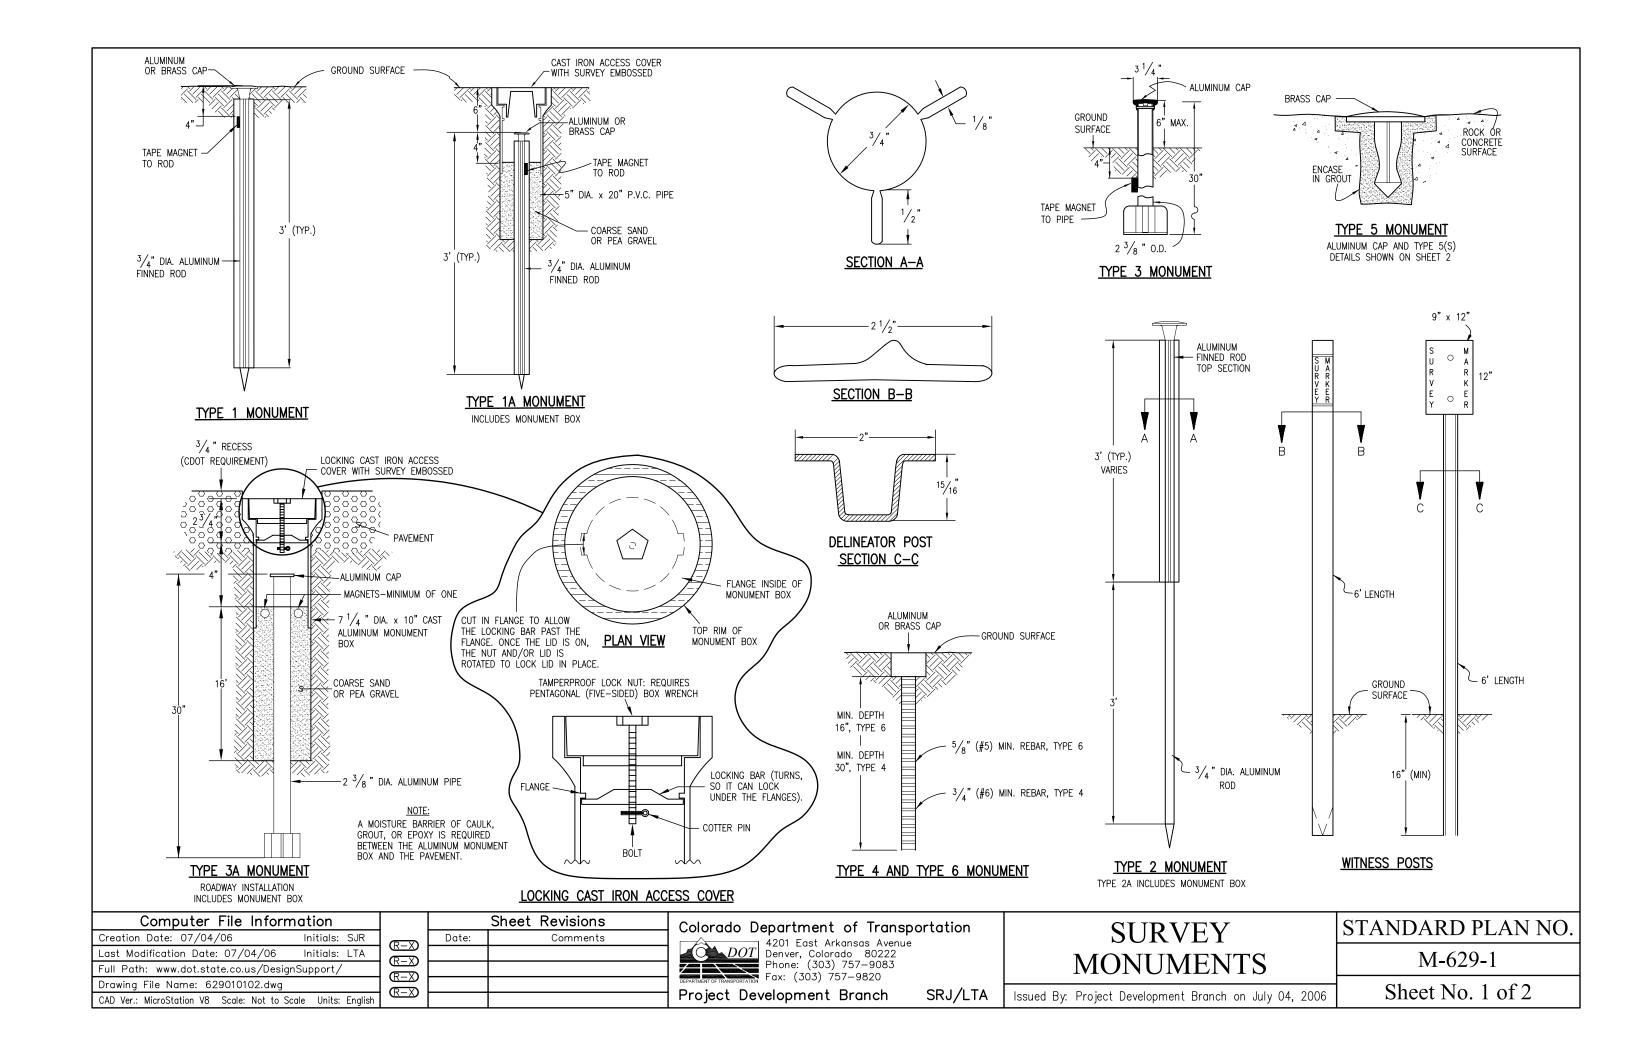

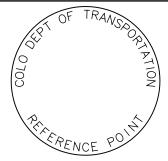



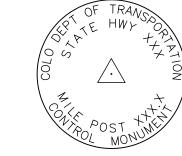



—TY.4, 2"-

−TY.6, 1 ¹/₂"−

ALUMINUM CAP



REFERENCE MONUMENT CAP

ROW MONUMENT CAP


CONTROL MONUMENT CAP

ALIQUOT CORNER MONUMENT CAP

ALUMINUM CAP


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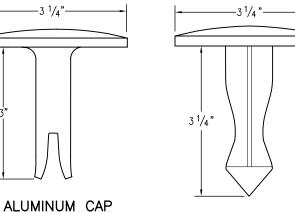
NOTE: A BLANK CAP MAY BE SUBSTITUTED IF THE APPROPRIATE CAP SHOWN ABOVE IS NOT AVAILABLE. IF A BLANK CAP IS USED, ALL INFORMATION NORMALLY INCLUDED ON THE APPROPRIATE STANDARD CAP, SHALL BE STAMPED ON THE BLANK CAP ALONG WITH SPECIFIC PROJECT INFORMATION SUCH AS PROJECT NO., DATE, POINT NO., ETC..

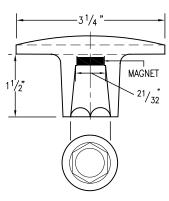


ALUMINUM CAP

USED WITH ALUMINUM ROD



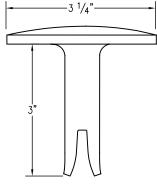

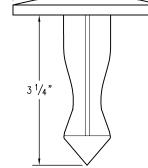


BRASS CAP FOR PLACING IN EXISTING TYPE 5 CONCRETE OR ROCK

FOR PLACING IN EXISTING CONCRETE OR ROCK

MONUMENT APPLICATION

TYPE 5

	MONUMENT TYPE									
CAP TYPE	1	1A	2	2A	3	3A	4	5	5(S)	6
REFERENCE	Х	Х						Х	Х	Х
ROW	Х	Х						Х	Х	
CONTROL			Х	Х				Х	Х	
ALIQUOT CORNER	Х	Х			Х	Х	Х	Х		
PERMANENT EASEMENT								Х	Х	Х
PROJECT POINTS								Х	Х	Х
WITNESS POST * (REQUIRED)	Х		Х	х	Х			х		

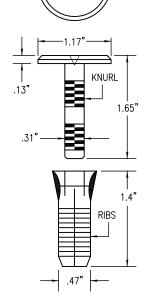

0

COPPER ALLOY CAP TYPE 5(S)

FOR PLACING IN EXISTING SIDEWALK, CURB, OR GUTTER

ALL MONUMENTATION MATERIALS WILL BE FURNISHED BY CDOT

THE MONUMENT TYPE SHALL MEET THE MINIMUM STANDARDS AS DETERMINED BY THE COLORADO STATE BOARD OF REGISTRATION FOR PROFESSIONAL LAND SURVEYORS RULES (STATE BOARD RULES).

THE CDOT SURVEY COORDINATOR SHALL APPROVE ALL EXCEPTIONS FOR STAMPING MONUMENTS DIFFERING FROM THE STANDARDS.

TYPE 1 AND TYPE 1A ALUMINUM FINNED ROD MONUMENTS

THIS MONUMENT SHALL BE USED FOR ROW OR REFERENCE MONUMENTS OR MAY BE USED FOR AN ALIQUOT CORNER MONUMENT. WHEN USED AS AN ALIQUOT CORNER MONUMENT, INSTALLATION AND RECORD FILING REQUIREMENTS SHALL BE AS STATED FOR TYPE 3 AND TYPE 3A MONUMENTS.

MONUMENTS SHALL BE INSTALLED BY ATTACHING THE PROPER SIZE TIP TO ONE END OF A SECTION OF FINNED ROD. AND A 3 IN. LONG X 3/4 IN. DIA. STAINLESS STEEL ADAPTER TO THE OTHER END. THE DRIVER IS THEN PLACED OVER THE STAINLESS STEEL ADAPTER FOR THE HAMMER TO CONTACT. TYPE 1 MONUMENTS SHALL USE A MINIMUM 3 FT. SECTION OF FINNED ROD. WHEN SUBSURFACE ROCK OR CONCRETE IS ENCOUNTERED LESS THAN 3 FT. BELOW THE GROUND SURFACE, THE ROD SHALL BE EMBEDDED IN THE ROCK OR IN CONCRETE AT LEAST 6 IN. AND GROUTED IN PLACE. THE ROD MAY BE SHORTENED TO ACCOMMODATE THE CONDITIONS.

WHEN UNSTABLE SOIL CONDITIONS ARE ENCOUNTERED, ADDITIONAL SECTIONS OF ROD SHALL BE ADDED TO ACHIEVE STABILITY. HORIZONTAL AND VERTICAL STABILITY ARE REQUIRED.

TYPE 1A MONUMENT INCLUDES MONUMENT BOX. A LOCKING CAST IRON ACCESS COVER SHALL BE INSTALLED WHEN THE MONUMENT IS LOCATED IN THE ROADWAY PAVEMENT.

TYPE 2 AND TYPE 2A ALUMINUM FINNED ROD MONUMENTS

THIS MONUMENT SHALL BE USED FOR HORIZONTAL AND VERTICAL CONTROL MONUMENTS. WHEN UNSTABLE SOIL CONDITIONS ARE ENCOUNTERED, ADDITIONAL SECTIONS OF ROD SHALL BE ADDED TO ACHIEVE STABILITY. HORIZONTAL AND VERTICAL STABILITY ARE REQUIRED. IN MOST SOIL CONDITIONS THE TYPE 2 MONUMENT IS EMBEDDED 6 FT. INTO THE GROUND.

THE MONUMENT SHALL BE INSTALLED BY FIRST ATTACHING THE PROPER SIZE TIP TO A 3 FT. LONG X 3/4 IN. DIA. ROD, THEN DRIVING THE ROD AT LEAST 30 IN. INTO THE GROUND. ADDITIONAL 3 FT. LONG X 3/4 IN. FINNED ROD SECTIONS SHALL BE ADDED AND DRIVEN FLUSH WITH THE GROUND UNTIL THE MONUMENT IS IN A STABLE POSITION. THE FINS ARE BENT OVER USING PLIERS TO ACCOMMODATE INSTALLING THE CAP. THE CAP IS FIRMLY SEATED ONTO THE LAST FINNED SECTION OF ROD USING A DEAD BLOW SLEDGE HAMMER.

TYPE 2A MONUMENT INCLUDES MONUMENT BOX. A LOCKING CAST IRON ACCESS COVER SHALL BE INSTALLED WHEN THE MONUMENT IS LOCATED IN THE ROADWAY PAVEMENT.

TYPE 3 AND TYPE 3A ALUMINUM PIPE MONUMENTS

THIS MONUMENT SHALL BE USED FOR AN ALIQUOT CORNER MONUMENT. THE INSTALLATION OF THIS MONUMENT AND RECORD FILING SHALL BE DONE IN ACCORDANCE WITH THE STATE BOARD RULES. ALSO REFER TO THE CDOT SURVEY MANUAL AND THE BUREAU OF LAND MANAGEMENT REQUIREMENTS FOR MONUMENT INSTALLATION. THE LAND SURVEYOR'S LICENSE NUMBER AND THE YEAR SHALL BE STAMPED ON THE CAP.

TYPE 3A MONUMENT INCLUDES MONUMENT BOX. A LOCKING CAST IRON ACCESS COVER SHALL BE INSTALLED WHEN THE MONUMENT IS LOCATED IN THE ROADWAY PAVMENT.

TYPE 4 ALUMINUM MONUMENT

THIS MONUMENT MAY BE INSTALLED IN LIEU OF REPLACING THE ENTIRE MONUMENT WHEN REBAR IS IN PLACE AT AN ALIQUOT CORNER LOCATION. REFER TO THE STATE BOARD RULES. A MINIMUM 2 IN. DIA. CAP SHALL BE USED ON 3/4 IN. (#6) REBAR.

TYPE 5 BRASS/ALUMINUM CAP MONUMENT

THIS MONUMENT MAY BE INSTALLED IN LIEU OF ALL OTHER CDOT MONUMENTS, WHEN THE POSITION IS LOCATED IN CONCRETE OR STABLE ROCK FORMATION.

TYPE 5(S) COPPER ALLOY CAP MONUMENT - SMALL

THIS MONUMENT MAY BE INSTALLED IN LIEU OF A TYPE 5 MONUMENT, WHEN THE POSITION IS LOCATED IN A CONCRETE SIDEWALK, CURB OR GUTTER, OR WHEN SETTING A TYPE 5 WOULD COMPROMISE THE INTEGRITY OF THE RECEIVING STRUCTURE.

STAMPING REQUIREMENTS:

- "RP", WHEN THE APPLICATION IS A REFERENCE POINT.
- "ROW", POINT NUMBER, "LS", AND REGISTRATION NUMBER WHEN THE APPLICATION IS A ROW POINT
- "CP" AND A UNIQUE IDENTIFIER PROVIDED BY THE REGION SURVEY COORDINATOR, WHEN THE APPLICATION IS A CONTROL POINT.
- "PE", POINT NUMBER, "LS", AND REGISTRATION NUMBER, WHEN THE APPLICATION IS A PERMANENT EASEMENT POINT.
- "PP" AND POINT NUMBER, WHEN THE APPLICATION IS A PROJECT POINT.

TYPE 6 ALUMINUM MONUMENT

THIS MONUMENT SHALL BE USED FOR PERMANENT EASEMENTS, PROJECT BENCH MARKS, PROJECT POINTS, AND REFERENCES. AN ALUMINUM CAP WITH A MINIMUM DIAMETER OF 11/2 IN., SHALL BE USED ON 5/8 IN. (#5) MINIMUM REBAR.

* WITNESS POSTS

THE WITNESS POST WILL BE SUPPLIED BY CDOT AND INSTALLATION SHALL BE INCLUDED IN THE WORK. IT SHALL BE DRIVEN WITHIN 1 FT. OF THE MONUMENT WHEN POSSIBLE. A DELINEATOR POST WITH A 9 IN. X 12 IN.METAL SIGN PANEL MAY BE USED IN LIEU OF THE PLASTIC POST. THIS POST SHALL CONFORM TO STANDARD PLAN S-612-1. A REQUIRED WITNESS POST MAY BE OMITTED WITH THE APPROVAL OF THE ENGINEER IF THE WITNESS POST LOCATION IS WITHIN A TRAVELED WAY, DRIVEWAY, OR ACCESS OPENING.

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Project Development Branch

SRJ/LTA

SURVEY
MONUMENTS

STANDARD PLAN NO

M-629-1

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Sheet No. 2 of 2