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303-972-9114		
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Sheet Revisions





Denver, CO 80202 Phone 303-572-0200 Fax 303-572-0202

Inglit of way Plans				
TITLE SHEET				
Project Number: STU 0021-031				
Project Location: 88th Avenue / SH 2 Intersection				
Project Location: Improvements				
Project Code: Lock Mark District				

Region 6 Design

CONVENTIONAL SIGNS LAND LINES SECTION LINE 4-SECTION LINE PROPERTY OR TRACT LINE
EXISTING ROAD = = = = = = = = =
NEW ROAD
RIGHT OF WAY LINE ROW MONUMENT
PROTECTED BY FREEWAY LAW (VIRGIN LOCATION)
TOP OF CUTS
TOE OF FILLS
FENCE
GUARDRAI TYPE DEST. TYPE NEW (METAL TYPES)
SOEWALK DUST. ————NEW
CURB OR TYPE DIST. TYPE NEW
GUTTER TYPE DOST. TYPE NEW
ELECTRIC LINES PERST. NEW PRELOCATED TO BE REMOVE

DEPARTMENT OF TRANSPORTATION STATE OF COLORADO

RIGHT OF WAY PLANS OF PROPOSED 88th Avenue/SH 2 Intersection Improvements ADAMS COUNTY

RIGHT OF WAY

SCALES OF ORIGINAL DRAWINGS: CONTROL DIAGRAM 1" = 400" PLAN SHEETS 1" = 100'

TITLE SHEET 2 PROJECT CONTROL DIAGRAM

INDEX OF SHEETS

3-4 PLAN SHEETS

SHEET NO.

-O BEST. --- ONEW --- O RELOCATED ---(DOUBLE POST)

BEGIN PROJECT

BUTTERFLY SIGN HALF BUTTERFLY SICE

STA. 31+40.00 & S.H. 2

DEER GATE

GENERAL NOTES

THESE SYMBOLS ARE INTENDED TO EXPLAIN THE VARIOUS TOPOGRAPHIC FEATURES INVOLVED ON THE ROADWAY PLAN SHEETS WHICH ARE PREPARED AT SCALES OF 1 INCH = 50 FEET OR 1 INCH = 100 FEET. NOTES ARE ADDED WHERE NECESSARY TO CLARIFY THE SYMBOL IF THESE SYMBOLS ARE NOT APPROPRIATE FOR USE WITH OTHER SCALES, A LEGEND IS PROVIDED IN THE PLANS TO EXPLAIN THE SYMBOLS THAT ARE USED.

GUARDRAIL, CURB & GUTTER, ETC., ARE REPRESENTED BY A SYMBOL WITH TYPE GIVEN BY NOTE.

EXISTING BUILDINGS AND OTHER MAN-MADE TOPOGRAPHICAL FEATURES NOT SYMBOLED HERE ARE SHOWN BY DASHED LINES WITH EXPLANATORY NOTES AS NECESSARY. NEW FEATURES TO BE CONSTRUCTED ARE SHOWN BY SOLID LINES.

BASIS OF BEARINGS: THE BEARINGS FOR THIS SURVEY ARE REFERENCED TO THE COMMERCE CITY "HARN" NETWORK, BEING A MIDIFIED COLORADO STATE PLANE COORDINATE SYSTEM BASED ON GPS OBSERVATIONS MADE ON THE FOLLOWING MONUMENTS:

CENTRAL ZONE SPC MODIFIED (GROUND) COORDINATES E1/4 S8 N = 1718900.73N = 1719258.35T3S, R67W E = 3167577.29E = 3168236.32

3" BRASS CAPPED MONUMENT, ILLEGIBLE, IN RANGE BOX

E = 3164957.96E = 3165616.433-1/4" ALUMINUM CAPPED MONUMENT, STAMPED: LS 17488, IN RANGE BOX

THE BEARING BETWEEN THESE MONUMENTS IS \$89"14'31"W, 2620.12 FEET.

Project Code: XXXXX DATE: October 25, 2005 R.O.W. LENGTH OF PROJECT: 3,293.14' / 0.64 MI. END PROJECT STA. 57+70.00 € S.H. 2

DEPARTMENT OF TRANSPORTATION FEDERAL HIGHWAY ADMINISTRATION

DIVISION ADMINISTRATOR

AUTHORIZED:

 $\frac{\text{VICINITY MAP}}{1" = 1000'}$

100

DATE

COLORADO DEPARTMENT OF TRANSPORTATION

DOT Region 6 2000 S. Holly Street Denver, CO 80222

Phone: 303-972-9112 FAX: 303-972-9114

Region 6 Design

Sheet Revisions






1601 Blake Street, Suite 200 Denver, CO 80202 Phone 303-572-0200 Fax 303-572-0202

Project Number: STU 0021-031 Project Location: 88th Avenue / SH 2 Intersection Project Location: Improvements roject Code: Last Mod. Date Subset Sheets Sheet No. Total No. of Sheet 15500 1/05/2006 2 of 4

Right of Way Plans

SURVEY CONTROL DIAGRAM

TOWNSHIP 2 SOUTH, RANGE 68 WEST, 6th P.M. NE1/4 SECTION 28, SE1/4 SECTION 21, SW1/4 SECTION 22, NW 1/4 SECTION 27

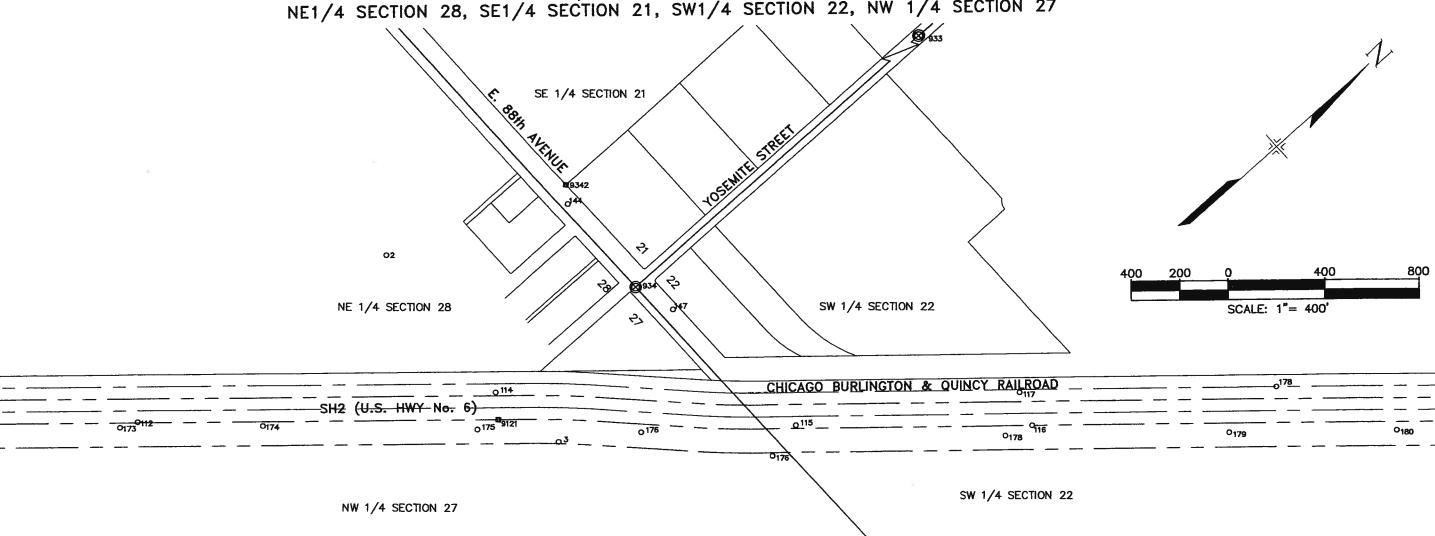

05

EXISTING C.D.O.T. MONUMENTS

POINT NORTHING EASTING ELEVATION DESCRIPTION

9121 736921.754 173543.249 5133.27 FND. CONCRETE RIGHT OF WAY MONUMENT

EXISTING ALIQUOT CORNERS

POINT NORTHING EASTING ELEVATION DESCRIPTION

933 740360.922 173504.191 5116.34 E1/4 S21 FND 3.25"AV LS13155 199 934 737708.982 173506.386 5134.27 "SE S21 FND 3.25AC, RB ILL"

PROJECT PANEL POINTS

POINT NORTHING EASTING ELEVATION DESCRIPTION

2 737034.806 172720.868 5135.68 #5 REBAR W/ALUMINUM CAP STAMPED "MATRIX, LS34977" 3 737044.554 173778.051 5131.85 #5 REBAR W/ALUMINUM CAP STAMPED "MATRIX, LS34977" 5 735255.842 172789.859 5134.76 #5 REBAR W/ALUMINUM CAP STAMPED "MATRIX, LS34977"

BENCHMARK

POINT NORTHING EASTING ELEVATION DESCRIPTION

902 719258.364 168236.358 5200.76 FND 3" BRASS CAP, ILL 200 731989.832 169056.716 5154.08 RODRIGUEZ GPS ADAMS CO. GIS

CONTROL POINTS & PROPERTY CORNERS

CUI	HIKOL F	Ollaro &	I IVOI	EKTT COMAEKS
POINT	NORTHING	EASTING E	LEVATION	DESCRIPTION
112	732543.960	169536.536	5153.35	#5 REBAR W/ALUMINUM CAP STAMPED "FLATIRONS SURV, CP, LS28283"
114	736989.709	173451.047	5134.51	#5 REBAR W/ALUMINUM CAP STAMPED "FLATIRONS SURV, CP, LS28283"
115	737815.410	174379.659	5128.53	#5 REBAR W/ALUMINUM CAP STAMPED "FLATIRONS SURV, CP, LS28283"
116	738536.440	175032.505	5125.52	#5 RFBAR W/ALUMINUM CAP STAMPED "FLATIRONS SURV, CP, LS28283"
117	738588.736	174894.443	5126.05	#5 REBAR W/ALUMINUM CAP STAMPED "FLATIRONS SURV, CP, LS28283
144	737733.380	173061.113	5126.81	#5 REBAR W/ALUMINUM CAP STAMPED "FLATIRONS SURV, CP, LS28283"
147	737761.574	173679.383	5136.09	#5 REBAR W/ALUMINUM CAP STAMPED "FLATIRONS SURV, CP, LS28283
173	735744.486	172531.343	5137.28	#5 REBAR W/ALUMINUM CAP STAMPED "FLATIRONS SURV, CP, LS28283
174	736183.856	172916.050	5132.26	#5 REBAR W/ALUMINUM CAP STAMPED "FLATIRONS SURV, CP, LS28283
175	736829.726	173515.609	5133.26	#5 REBAR W/ALUMINUM CAP STAMPED "FLATIRONS SURV, CP. LS28283
176	737321.103	173973.329	5135.85	#5 REBAR W/ALUMINUM CAP STAMPED "FLATIRONS SURV, CP, LS28283
177	737658.706	174409.869	5132.88	#5 REBAR W/ALUMINUM CAP STAMPED "FLATIRONS SURV, CP, LS2828."
178	738424.171	174989.006	5127.01	#5 REBAR W/ALUMINUM CAP STAMPED "FLATIRONS SURV, CP, LS28283
179	739117.908	175597.302	5128.92	#5 REBAR W/ALUMINUM CAP STAMPED "FLATIRONS SURV, CP, LS28283
180	739647.039	176058.152	5132.23	#5 REBAR W/ALUMINUM CAP STAMPED "FLATIRONS SURV, CP, LS28283
9342	737780.845	172996.068	0.00	FND 1.5"ALUMINUM CAP STAMPED "MERRICK, LS13155"

NOTES:

- 1. THIS SURVEY WAS CONDUCTED TO VERIFY EXISTING CONTROL AND PROVIDE ADDITIONAL CONTROL FOR FUTURE HIGHWAY DESIGN AND CONSTRUCTION PURPOSES, AND IS INTENDED ONLY FOR THE USE OF THE COLORADO DEPARTMENT OF TRANSPORTATION.
- 2. COORDINATES SHOWN ARE PROJECT COORDINATES IN U.S. FEET. ELEVATIONS SHOWN ARE
- 3. BEARINGS ARE BASED ON THE COMMERCE CITY "HARN" NETWORK, BEING MODIFIED COLORADO STATE PLANE COORDINATE SYSTEM BASED ON GPS OBSERVATIONS MADE ON THE

E1/4 SECTION 8, T.3S., R.67W., 3" BRASS CAPPED MONUMENT, ILLEGIBLE IN RANGE BOX. CENTRAL ZONE SPC MODIFIED (GROUND) COORDINATES N. 1719258.35 N. 1718900.73 E. 3168236.32 E. 3167577.29

C1/4 SECTION 8, T.3S., R.67W., 3.25° ALUMINUM CAPPED MONUMENT STAMPED LS17488, 1991, IN RANGE BOX. MODIFIED (GROUND) COORDINATES CENTRAL ZONE SPC N. 1718866.07 E. 3165616.43 E. 3164957.96

CDOT F #126Re	The state of the s	Matrix Design Group, Inc. Grated Design Solutions 1601 Blake Street, Suite 200 Deaver, CO 80202 Phone 303-572-0200 Fax 303-572-0202	RIGHT OF WAY PLAN SHEET Project Number: STU 0021-031 Project Location: 88th Avenue / SH 2 Intersection Project Location: Improvements Project Code: Last Mod. Date Subset Sheets Sheet No. Total No. of Sheet 15500 1/05/2006 3 of 4						
ì	NE 1/4 SEC. 28								
RECEPTION NUMBER	BEGIN PROJECT STA. 31+40.00 & S.H. 2								
St. AT PAGE SIGNED	OWNER: CHICAGO BURLINGTON & QUINCY RAILROAD (100' R.O.W.) EXISTING RIGHT OF WAY - SH HIGHWAY NO. 2 (PROJ. NO. E-285-B 1939) 29+00. 30-00 31+00 32+00 33+00 35+0								
1 / Jone 1 / Jone 1	EXISTING RIGHT OF WAY — SH HIGHWAY NO. 2 (PROJ. NO. E—285—B 1939)	39±00. 40±00. 90 01	41±00 43±00 45±00 45±00 45±00 45±00 45±00 45±00 45±00 45±00 45±00 45±000						
FX184-BOWhose du	EXISTING RIGHT OF WAY — ACQUIRED FROM USA / ROCKY MOUNTAIN ARSENAL (REC. NO. 20041119001173830, 11/19/2004)								
)\dwg\survey\SH2-CDOT\88th_Ave\	OWNER: UNITED STATES OF AMERICA	60' DENVER WATER DEPT. EASEMENT PARCEL 1 REC. NO. C1280437 DACA45-2-04-6008							
05.184.001 (Prairle Gateway)	NE 1/4 SEC. 28 SCALE: 1"= 100'								

