QUARTER, SIXTEENTH,

QUARTER, SIXTEENTH,

AND SECTION CORNERS

.

ROW

RIGHT OF WAY

FI 0.00

HIGH ACCURACY REFERENCE

NETWORK CONTROL MONUMENT

Region 6:

1

SECTION CORNER

(1)

SET EASMENT

⊙ FED

FEDERAL MONUMENT

LOCAL OR PLSS

PROJECT CONTROL

MONUMENT

TEMPORARY EASEMENT LINE (EXISTING)

____ A _ _ _ _ _ _ A _ _ _ _ _

ACCESS CONTROL LINE

RIGHT OF WAY LINE

CITY LIMIT LINE (EXISTING)

QUARTER SECTION LINE

SIXTEENTH SECTION LINE STATE LINE (EXISTING) TOWNSHIP LINE (EXISTING)

SECTION LINE

TOP OF CUT

BARRIER ACCESS CONTROL LINE

VIRGIN RIGHT OF WAY LINE (PROPOSED)

PERMANENT, PROPERTY, SLOPE, & UTILITY EASEMENT LINE

PROPERTY BOUNDARY LINE (EXISTING AND PROPOSED)

▲_{N 9.88}

BLM MARKER

DOT 2000 S Holly Street Denver, CO 80222 Phone: (303) 757-9922

1 |

TEMPÖRARY

\/C

SECONDARÝ CONTROL

MONUMENT

WITNESS CORNER

FI 0.00

DENSIFICATION

CONTROL MONUMENT

____ III- - - ____ III- - - ____ III- - - ___

SURVEY/ROW

TERRAIN

___v__

NOAA

NOAA MÄRKER

FAX: (303) 757-9390 SLK

Sheet Revisions			Sheet Revisions			Sheet Revisions	
Description	Initials	Date	Description	Initials	Date	Description	Initials
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Right of Way Plans Title Sheet Project Number: STU M320-060 Project Location: Colfax/Galapago/Welton Intersection Sec34,T.3S.,R69W., Sec3,T4S.,R68W, 6th PM, Denver Cnty roject Code: Last Mod. Date Subset Sheets Sheet No.

INDEX OF SHEETS

(1) Tabulation of Properties (NA) Project Control Diagram

(4) Land Survey Control Diagram

(NA) Tabulation of Road Approach Sheets

Monumentation Sheets

Scales of Original 11x17 Drawings

Plan Sheets 1"=40'

Ownership Map 1"=40'

(1) Title Sheet


(1) Plan Sheets (NA) Ownership Map

(8) Total Sheets

CITY AND COUNTY OF DENVER STATE OF COLORADO

RIGHT OF WAY PLANS OF PROPOSED FEDERAL AID PROJECT NO. STU M320-060 STATE HIGHWAY NO. 40

> R.O.W. Length of Project = 0.14 Miles Const. Length of Project = 0.14 Miles

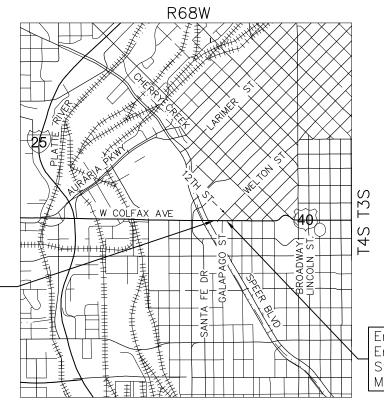

Basis of Bearings: Bearings shown, or used in the calculations of coordinates, are based on City and County of Denver local grid bearing of N 83°14'54" E from David Evans' Control Point No. 104 to Control Point No. 102. Both monuments being described hereon and shown on Denver Justice Center Survey and Right of Way Diagram recorded in the City and County of Denver Land Survey Plats at Reception Number L011113. The survey data was obtained from a combination of RTK GPS and terrestrial total station survey

SHEET NO.

1.01

2.01

3.01 4.01 - 4.04

5.01

6.01

7.01

- 1. This Right—of—Way Plan is not a boundary survey of the adjoining property and is prepared for the Colorado Department of Transportation purposes only.
- 2. For title information, Stantec Consulting relied on Informational Title Commitment File No. 04665A2011, dated 02-14-2011 at 4:00 p.m. prepared by H. C. Peck and Associates, Inc..
- 3. This plan set is subject to change and may not be the most current set. It is the user's responsibility to verify with CDOT that this set is the most current. The information contained on the attached drawing is not valid unless this copy bears an original signature of the Professional Land Surveyor hereon named.

NOTICE: According to Colorado law you must commence any legal action based upon any defect in this survey within three years after you first discover such defect. In no event may any action based upon any defect in this survey be commenced more than ten years from the date of the certification shown hereon.

End Construction Project End ROW Project Station: 104+82.37 M.P.: 297.673

DEPARTMENT OF TRANSPORTAT FEDERAL HIGHWAY ADMINISTRA	
AUTHORIZED:	DATE
DIVISION ADMINISTRATOR	

PROJECT LOCATION MAP

3,000'

Note: For a complete listing of symbology used within this set of plans, please refer to the M-100-1Standard Symbols of the Colorado Department of Transportation M&S Standards Publication dated July 2006. Existing features are shown as screened weight (gray scale), except as noted with the word (existing). Proposed or new features are shown as full weight without screening, except as noted with the word


Begin Construction Project

Begin ROW Project

Station: 100+71.75 M.P.: 297.657

SURVEYOR STATEMENT (ROW PLAN)

I, Alan Warner, a professional land surveyor licensed in the State of Colorado, do hereby state to the Colorado Department of Transportation that based upon my knowledge, information and belief, research, calculations and evaluation of the survey evidence were performed and this Right-of-Way Plan was prepared under my responsible charge in accordance with applicable standards of practice defined by Colorado Department of Transportation publications. This statement is not a guaranty or warranty, either expressed or

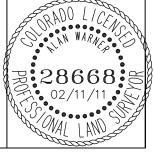

PLS No. 28668

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Region 6:

DOT 2000 S Holly Street Denver, CO 80222 Phone: (303) 757-9390 FAX: (303) 757-9390

SLK

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Right of Way Plans Tabulation of Properties

Project Number: STU M320-060
Project Location: Colfax/Galapago/Welton Intersection
Sec34,T.3S.,R69W., Sec3,T4S.,R68W, 6th PM, Denver Cnty
Project Code: Last Mod. Date Subset Sheets Sheet No.
16952 02-11-11 2.01 of 2.01 2.01

R.O.W. TABULATION OF PROPERTIES IN DENVER COUNTY

STATE HIGHWAY 40

10.0.11.	IABULATION OF PR	OI EIVIIES IIV BEIV	· 210 00 01 11 1								
Parcel No.	Ownership Name and Mailing Address	Site Address	Location	A		Square Feet		Remainder	Book and Page No. and/or	Title Commitment No.	Remarks
				Area of Parcel	Existing ROW	Net Area	Remainder Left	Remainder Right	Reception No.	 	
	Geller, Richard A &	1150 Welton St	SW 1/4, Sec. 34, T3S, R68W	3,717			18,906				Permanent Right of Way
	Paderski, David R	Denver, CO	NW 1/4, Sec. 3, T4S, R68W								
	3310 E. Colfax Ave	80206									
	Denver, CO. 80206-1714										
TE-1	(Same as above)	(Same as above)	(Same as above)	1,804							Temporary Easement For Construction of Roadway

Region 6:

DOT 2000 S Holly Street Denver, CO 80222

Phone: (303) 757-9922 FAX: (303) 757-9390

	Sheet Revisions			Sheet Revisions			Sheet Revisions	
ate	Description	Initials	Date	Description	Initials	Date	Description	Initials
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Land Survey Control Diagram Title Sheet Project Number: STU M320-060 Project Location: Colfax/Galapago/Welton Intersection Sec34,T.3S.,R69W., Sec3,T4S.,R68W, 6th PM, Denver Cnty
 Project Code:
 Last Mod. Date
 Subset Sheets
 Sheet No.

 16952
 02-11-11
 4.01 of 4.04
 4.01

\oplus \oplus 11 QUARTER, SIXTEENTH, SECTION CORNER AND SECTION CORNERS \bigcirc $\langle 1 \rangle$ (1) 1 SET EASMENT TEMPÖRARY RIGHT OF WAY MONUMENT FASMENT POINT MARKER NOAA PP QUARTER, SIXTEENTH, BLM MARKER PROPERTY PIN NOAA MARKER 0 WC. FEDERAL MONUMENT WITNESS CORNER USGS MARKER \blacksquare Δ ROW LOCAL OR PLSS SECONDARY CONTROL RIGHT OF WAY MONUMENT MONUMENT MARKER $\triangle_{\text{N 9.88}}$ △_{N 10.38} EL 0.00 EL 0.00 EL 0.00


DENSIFICATION

CONTROL MONUMENT

DEPARTMENT OF TRANSPORTATION STATE OF COLORADO

LAND SURVEY CONTROL DIAGRAM

State Highway 40 MP 297.657 to 297.673 Section 34, T. 3 S., R. 68 W.. & Section 3, T. 4 S., R 68 W. of the 6th Principle Meridian City and County of Denver

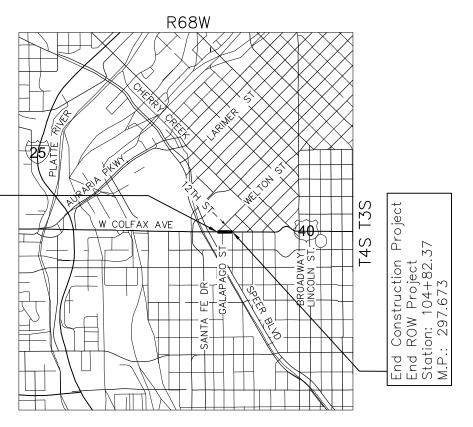

SHEET NO. INDEX OF SHEETS

> 4 01 (1) Title Sheet 4.02 (1) Plan Sheet

(1) Geodetic Control Coordinate Table 4.03 4 04

(1) Monument Coordinate Table

4 Total Sheets

Basis of Bearings: Bearings shown, or used in the calculations of coordinates, are based on City and County of Denver local grid bearing of N 83°14'54" E from David Evans' Control Point No. 104 to Control Point No. 102. Both monuments being described hereon and shown on Denver Justice Center Survey and Right of Way Diagram recorded in the City and County of Denver Land Survey Plats at Reception Number L011113. The survey data was obtained from a combination of RTK GPS and terrestrial total station survey

Basis of Elevations: NAVD 88 Project elevations were established by differential leveling from City of Denver Benchmark No 3B. The published orthometric height of BM 3B is 5214.12 ft NAVD 1988. Site Benchmarks are 2" brass caps marked "DEA" and shown hereon. This information was supplied by the City and County of Denver, order of benchmark is

COORDINATE DATUM: Project coordinates were derived are based on the City and County of Denver grid known as "ccod_local":

Transverse Mercator Zone: ccd_local

Datum: NAD83-1992

Central Point False Northing = 400,000

False Easting = 600,000

Latitude of Origin = N39°45'19" Central Meridian = W104°53'53"

Zone width = $6^{\circ}0'00.0"$

Scale Factor at Origin = 1.00025403000

Units are US Survey Feet and decimals thereof.

- 1. Map of the Official Survey of East Denver known as the Bonsall Map.
- 2. Map of the Official Survey of Witter's Fisrt Addition.
- 3. Miscellanious City and County of Denver tie books.
- 4. Land Survey Pplats Rec. No.'s L002066, L002545, L002928, L006530, L009318 AND L011086.
- 5. Denver Justice Center Survey and Right of Way Diagram, Rec. No. L011113.
- 6. Monument Record for the Southwest Corner., Sec. 34, by D. Forde Dated 03/11/02.

NOTICE: According to Colorado law you must commence any legal action based upon any defect in this survey within three years after you first discover such defect. In no event may any action based upon any defect in this survey be commenced more than ten years from the date of the certification shown hereon.

General Notes:

word (proposed).

PROJECT CONTROL

MONUMENT

1. This Land Survey Control Diagram is not a boundary survey of the adjoining property and is prepared for the Colorado Department of Transportation purposes only. No determination has been made to determine if the found monuments as shown are in their proper position or if they are at the corners they are intended to monument.

HIGH ACCURACY REFERENCE

NETWORK CONTROL MONUMENT

Note: For a complete listing of symbology used within this set of plans, please refer to the M-100-1 Standard Symbols of the Colorado

Department of Transportation M&S Standards Publication dated July 2006. Existing features are shown as screened weight (gray scale),

except as noted with the word (existing). Proposed or new features

are shown as full weight without screening, except as noted with the

Begin Construction Project


Begin ROW Project

M.P.: 297.657

|Station: 100+71.75

- 2. Title policy, title commitment, and title research are not part of this survey, therefore easements, rights, and restrictions of record were not researched and are not shown on this diagram. The verification of the physical evidence with relation to easements, rights of ways, property boundaries, and restrictions, as described in the instruments of record, were not included in this control survey.
- 3. This plan set is subject to change and may not be the most current set. It is the user's responsibility to verify with CDOT that this set is the most current. The information contained on the attached drawing is not valid unless this copy bears an original signature of the Professional Land Surveyor hereon named.
- 4. Refer to the M-629-1 Survey Monuments of the Standard Plans dated July, 2006 found in The Colorado Department of Transportation, M & S Standards for typical survey monument descriptions.


PROJECT LOCATION MAP

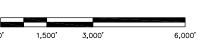


SURVEYOR STATEMENT (ROW PLAN)

I. Alan Warner, a professional land surveyor licensed in the State of Colorado, do hereby state to the Colorado Department of Transportation that this Land Survey Control Diagram was prepared and the field survey it represents was performed under my responsible charge and, based upon my knowledge, information and belief is in accordance with applicable standards of practice defined by Colorado Department of Transportation publications. This statement is not a quaranty or warranty, either expressed or implied.

PLS No. 28668

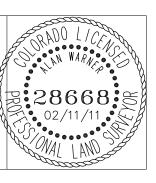

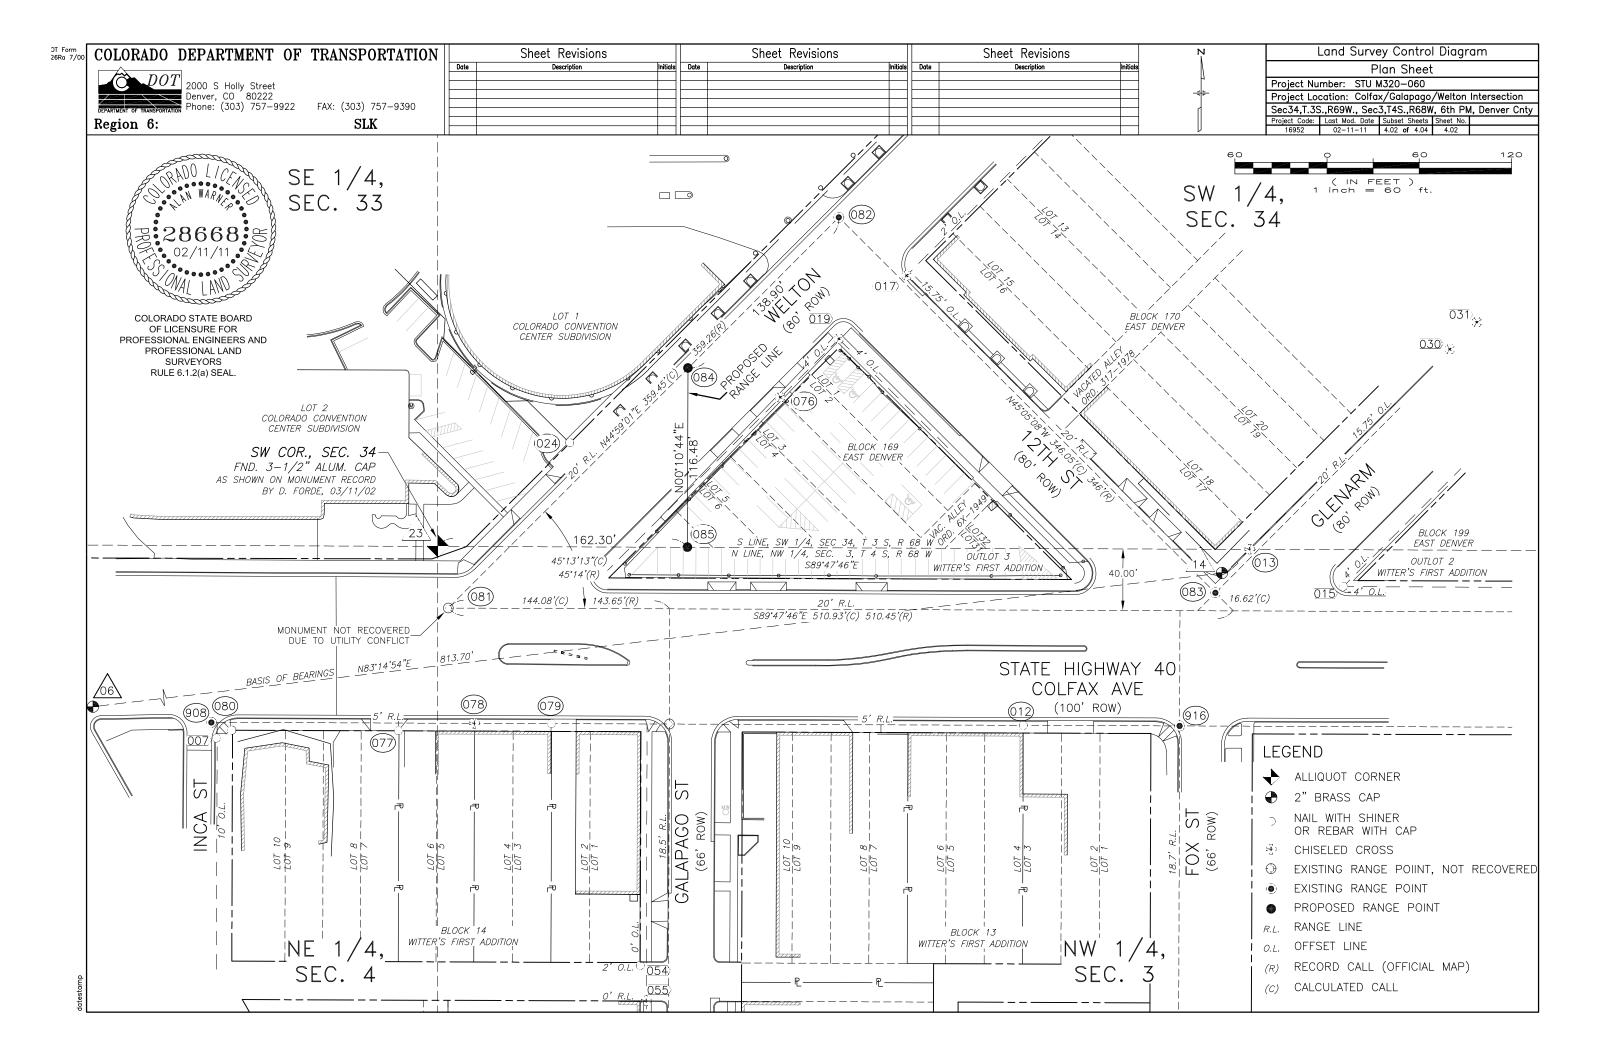

Region 6:

DOT 2000 S Holly Street Denver, CO 80222 Phone: (303) 757-9320 FAX: (303) 757-9390

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Land Survey Control Diagram Geodetic Control Coordinate Table Project Number: STU M320-060

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	GEODETIC COORDINATE TABLE									
	Geodetic (Coordinates	Elip Height	Ortho Height			Project Co	ordinates (Denv	er Local)	
Point No.	Lattitude	Longitude	(NAVD)(m)	(m)	Mapping Angle	Grid Scale Factor	Northing (Sft)	Easting (Sft)	Elevation	Description
•	1 39°44'24.98821"N	104°59'49.09984"W	1572.198	1589.253	0°18'59.59259"	0.999751422	394548.721	572175.442	5214.12	2" Brass Cap CCOD BM 3B
(39°44'23.85836"N	104°59'53.23679"W	1573.447	1590.495	0°18'59.50669"	0.999751166	394434.725	571852.066	5218.15	2" Brass Cap DEA Control Pnt.
14	1 39°44'24.80938"N	104°59'42.89636"W	1572.601	1589.663	0°19'06.02851"	0.99975135	394530.090	572660.144	5215.42	2" Brass Cap DEA Control Pnt.
23	39°44'24.97649"N	104°59'49.42690"W	1571.532	1589.586	0°19'01.90954"	0.999751358	394547.563	572149.886		3 1/2" Alum. Cap. PLS 16401

COLORADO STATE BOARD OF LICENSURE FOR PROFESSIONAL ENGINEERS AND PROFESSIONAL LAND SURVEYORS RULE 6.1.2(a) SEAL.



Region 6:

DOT 2000 S Holly Street Denver, CO 80222 Phone: (303) 757-9922 FAX: (303) 757-9390 SLK

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Land Survey Control Diagram Monument Coordinate Tables Project Number: STU M320-060 Project Location: Colfax/Galapago/Welton Intersection
 Sec34,T.3S.,R69W., Sec3,T4S.,R68W, 6th PM, Denver Cnty

 Project Code:
 Last Mod. Date
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 4.04

	FOUND ALI	QUOT MONUMENT (COORDINATE TABLE
Point No.	Northing(ft)	Easting(ft)	Description
23	394547.407	572149.940	FOUND 3-1/2" ALUM. CAP

COLORADO STATE BOARD OF LICENSURE FOR PROFESSIONAL ENGINEERS AND PROFESSIONAL LAND SURVEYORS RULE 6.1.2(a) SEAL.



FOUND BOUNDARY MONUMENT COORDINATE TABLE									
Point No.	Northing(ft)	Easting(ft)	Description						
12	394430.986	394430.986	PK Nail W/Tag PLS Illegible						
13	394545.628	572678.220	Chiseled X						
24	394614.683	572235.742	PK Nail W/Tag PLS Illegible						
76	394644.246	572372.738	Chiseled cross						
77	394427.367	572124.560	Yellow Plastic Cap PLS Illegible						
78	394432.297	572173.759	Chiseled cross						
79	394432.112	572223.952	PK Nail W/Tag PLS Illegible						
80	394427.609	572016.227	Yellow Plastic Cap PLS Illegible						

·	FOUND R.O.W. MONUMENT COORDINATE TABLE							
Point No.	oint No. Northing(ft) Easting(ft) Descript:							
7	394422.507	572006.241	PK Nail W/Tag PLS Illegible					
15	394521.400	572739.418	PK Nail W/Tag PLS Illegible					
17	394723.597	572454.870	Chiseled cross					
19	394682.393	572410.863	Chiseled cross					
30	394675.907	572808.276	Chiseled cross					
31	394804.706	572936.855	Chiseled cross					
54	394274.583	572281.533	PK Nail W/Tag PLS 16408					
55	394251.596	572285.473	Chiseled cross					
908	394432.893	572005.362	Brass disk in concrete					
916	394430.719	572632.410	1-1/2" Aluminum Cap w/ punch					

DENVER RANGE POINT MONUMENT COORDINATE TABLE							
Point No.	Northing(ft)	Easting(ft)	Description				
81	394507.35900	572156.75600	Calculated Position				
82	394761.54100	572410.79300	Set PK Nail W/ Washer PLS 28668				
83	394517.21000	572655.85500	Set 2-1/2" Alum. Cap PLS 28668				
84	394663.29500	572312.60300	Set PK Nail W/ Washer PLS 28668				
85	394546.81900	572312.23900	Set PK Nail W/ Washer PLS 28668				

Note: Existing range points (082 & 083) are to be preserved during construction and standard City range point monuments to be set at the end of construction. New range points (084 AND 085) are to be monumented at the end of construction.

Region 6:

QUANTITY OF MONUMENTS TO BE SET

1A

MONIJMENT TYPI

2 2A 3 3A* 4 5 5(S)

DOT 2000 S Holly Street Denver, CO 80222 Phone: (303) 757-9922 FAX: (303) 757-9390 SI.K

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Date	Description	Initials	Date	Description	Initials	Date	Description	nitials

Right of Way Plans Monumentation Sheet Project Number: STU M320-060 Project Location: Colfax/Galapago/Welton Intersection Sec34,T.3S.,R69W., Sec3,T4S.,R68W, 6th PM, Denver Cnty
 Project Code:
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 5.01



SLK

	TABULATION OF DENVER RANGE POINT MONUMENTS TO BE SET									
Point No.	Northing(ft)	Easting (ft)	Description	Station (Welton St)	Offset (Welton St)	Station (SH 40)	Offset (SH 40)			
82	394761.541	572410.793	Denver Range Point	205+15.46	22.77R	103+97.76	285.15L			
84	394663.295	572312.603	Denver Range Point	203+76.56	25.57R	102+99.92	186.55L			
85	394546.819	572312.239	Denver Range Point	202+70.08	0.00R	102+99.97	70.08L			



TABULATION OF R.O.W. MONUMENTS TO BE SET								
Point No.	Northing(ft)	Easting (ft)	Description	Station (Welton St)	Offset (Welton St)	Station (SH 40)	Offset (SH 40)	
86	394526.583	57 2357 . 276	Parcel 1	202+49.98	45.10R	103+45.08	50.00L	
87	394537.989	57 2345 . 211	Parcel 1	202+61.35	33.00R	103+32.97	61.36L	
88	394578.939	57 2345 . 339	Parcel 1	203+02.30	33.00R	103+32.96	102.31L	
89	394621.793	57 2355 . 952	Parcel 1 - POB	203+62.69	33.00R	103+43.42	145.20L	
96	394526.925	572261.139	Parcel 1 - DO NOT SET	202+50.02	51.04L	102+48.94	50.00L	



	TABULATION OF TEMPORARY EASEMENT POINTS TO BE STAKED									
Point No.	Northing(ft)	Easting(ft)	Description	Station (Welton St)	Offset (Welton St)					
96	394526.483	572388.235	TE1	20 4+34 . 68	37.23R					
97	394536.483	572388.271	TE1	20 4+34 . 68	47.23R					
98	394538.572	572381.271	TE1	203+60.44	43.00R					
99	394542.288	572355.225	TE1	203+02.30	43.00R					
100	394578.907	572355.339	TE1	202+65.67	43.00R					
101	394615.834	572384.135	TE1	202+59.98	49.06R					
102	394658.272	572408.549	TE1	202+59.97	74.06R					
103	394665.342	572399.478	TE1 POB	202+49.97	74.06R					

General Notes:

- 1. All centerline and offset stationing may not represent the centerline as constructed in the field.
- 2. Refer to the M-629-1 Survey Monuments of the Standard Plans dated July, 2006 found in The Colorado Department of Transportátion, M & S Standards for survey monument descriptions.
- 3. This plan set is subject to change and may not be the most current set. It is the user's responsibility to verify with CDOT that this set is the most current. The information contained on the attached drawing is not valid unless this copy bears an original signature of the Professional Land Surveyor hereon named.
- For the upgrading or resetting of Denver range points refer to the City adn County of Denver specifications. Type 5 monuments can be used where point falls on concrete surface. The Denver range points will be paid for as a CDOT Type 4 in monument box.

COORDINATE DATUM: Project coordinates were derived are based on the City and County of Denver grid known as "ccod_local":

> Transverse Mercator Zone: ccd_local Datum: NAD83-1992 Central Point False Northing = 400,000, False Easting = 600,000 Latitude of Origin = N39'45'19" Central Meridian = W104'53'53" Zone width = $6^{\circ}0'00.0"$ Scale Factor at Origin = 1.00025403000
> Units are US Survey Feet and decimals thereof.

NOTICE: According to Colorado law you must commence any legal action based upon any defect in this survey within three years after you first discover such defect. In no eventmay any action based upon any defect in this survey be commenced more than ten years from the date of the certification shown hereon.

SURVEYOR STATEMENT (R.O.W. MONUMENTS)

, a professional land surveyor licensed in the State of Colorado, do hereby state to the Colorado Department of Transportation that based upon my knowledge, information and belief, adequate research, calculations and evaluation of survey evidence were performed and the Right-of-Way monuments depicted on this Right-of-Way Plan were set under my responsible charge in accordance with applicable standards of practice defined by Colorado Department of Transportation publications. This statement is not a guaranty or warranty, either expressed or implied. PLS No.

ALIQUOT CORNER PERMANENT EASEMENT PROJECT POINTS WITNESS POST (REQUIRED)

TYPE

REFERENCE

ROW

CONTROL

